April 5, 2022



Ms. Lexy Wellott The Planning Center 2 E Congress Street #600 Tucson, AZ 85701

Subject: Minor Amendment to Valencia Crossing – TPC Project No: KBT-50

Dear Ms. Wellott

I have reviewed your letter dated February 18, 2022 (see attached) requesting a minor amendment to the Valencia Crossing PAD (PAD-21).

The proposed minor amendment request:

1) Amend Section III.D: Landscape Borders and Screening of PAD-21 ("Landscaping" for Development Area A) to include language that suggests appropriate landscape treatments for residential uses when development adjacent to other residential uses or zones. Suggested language: "For residential uses, landscape borders and screening requirements shall be provided in accordance with accordance with UDC Section 7.6."

The Valencia Crossing PAD allows for minor amendments and adjustments over time to respond to the changing market demands, or financial conditions, or to respond to all the unanticipated needs for new users.

When PAD-21 was initially proposed in 2012, it was envisioned that Development Area 'A' would develop with higher intensity commercial and office uses, and high-density residential uses to provide the surrounding community with employment opportunities and commercial services needed to sustain the existing and planned residential communities. A landscape border along the eastern edge of Development Area 'A' was proposed to ensure compatibility with the existing neighboring school (Lauffer Middle School).

The site in question is proposing lower density residential (single-family homes) in Development Area 'A', east of the middle school. Adding the landscape border would create an unsafe space between the screen wall and the school's fence.

The current and incoming principals of Lauffer Middle School agreed that removing the 10-foot landscape border is appropriate as it removes an indefensible space that typically invites unwanted activities.

City of Tucson - Department of Planning and Development Services, Landscape Division has reviewed the minor amendment request and attachments and supports the amendment.

> Planning and Development Services Department (PDSD) 201 North Stone Avenue P.O. Box 27210 – Tucson, AZ 85726-7210 Website: www.tucsonaz.gov/pdsd

Therefore, it is determined that this minor amendment request is not in conflict with the overall intent of the Valencia Crossing PAD, and the proposed amendment conforms to the goals and objectives of the PAD.

This minor amendment is supported and approved by the following as a non-substantial change:

- 1. This change does not alter the allowable uses or building heights;
- 2. This change does not alter or vary a PAD policy;
- 3. This change does not result in a change in the traffic circulation; and
- 4. This change is supported by both the current and incoming principals of Lauffer Middle School.
 - a. Comments include: Agreed that removing the 10-foot landscape border is appropriate as it removes an indefensible space that typically invites unwanted activities. Expressed excitement for the proposed subdivision and stated that they were looking forward to the partnership with KB Homes.
- 5. This change is supported by City of Tucson Department of Planning and Development Services Landscape Division.
 - a. Comments include: Requiring a 10' landscape border on the east boundary would result in a tunnel between the two uses, creating an unsafe situation, disregarding the principals of Safe by Design. Further, there are existing mature trees on the school's property along most of this boundary that provide visual relief. Recommended that the landscape required for this border be planted in a more appropriate location on the project site, including adding trees to the southeast.

This amendment approval is only for this specific request and location in Development Area 'A'. Please note that a copy of this letter and included attachments must be attached to any development plan / plat submitted for the Valencia Crossing PAD, and that all the revised Exhibits will be made part of the Valencia Crossing PAD – Minor Amendment.

Sincerely,

John Beald

John Beall, Section Manager - Entitlements Planning and Development Services Department

Attachments: Applicant's Request

Planning and Development Services Department (PDSD) 201 North Stone Avenue P.O. Box 27210 – Tucson, AZ 85726-7210 Website: www.tucsonaz.gov/pdsd



February 18, 2022

Mr. John Beall Entitlement Section Manager City of Tucson Planning and Development Services 201 North Stone Avenue Tucson, AZ 85701

Subject: Valencia Crossing PAD Minor Amendment Request TPC Project No: KBT-50

Dear Mr. Beall:

On behalf of KB Home - Tucson (3501 East Speedway Boulevard, Suite 101 Tucson, AZ 85716), this letter respectfully requests an administrative amendment to the Valencia Crossing PAD (PAD-21) to revise the landscape border requirements for a portion of Development Area 'A'. Approved in 2012 by Mayor and Council, the Valencia Crossing PAD rezoned approximately 195 acres of land located at the intersection of East Valencia Road and East Littletown Road from R-1, C-1, and I-1 to a PAD with the intent of developing employment-generating uses (office, commercial and retail centers), industrial uses, and higher-density residential uses (refer to rezoning case no. C9-12-03).

KB Home - Tucson is currently processing a development plan to construct The Reserve at Valencia Crossing in Development Area' A'. As described in PAD-21, Development Area 'A' is an 85-acre area bisected by Valencia Road at the intersection of Valencia Road and Littletown Road. The area subject to this administrative amendment, herein referred to as the 'Property,' is approximately 10.1 acres located at the northeast corner of Valencia Road and Littletown Road (APN 140-36-005C). As demonstrated in *Attachment A: The Reserve at Valencia Crossing Development Plan,* KB Home - Tucson proposes to construct a 50-lot single-family subdivision that is accessed from a single entrance on Littletown Road. Per PAD-21 and the underlying base zone (C-2), single-family residential uses are permitted on the Property.

When PAD-21 was initially proposed in 2012, it was envisioned that Development Area 'A', and more specifically, the Property would develop with higher intensity commercial and office uses, and high-density residential uses to provide the surrounding community with employment opportunities and commercial services needed to sustain the existing and planned residential communities in the Littletown Area. Due to the intense nature of the uses contemplated at the time of rezoning and to ensure compatibility with the existing school (Billy L. Lauffer Middle School) located to the east of the Property, a 10-foot-wide landscape border with a 5-foot screen wall was proposed along the eastern edge of Development Area 'A' (refer to *Attachment B: Exhibit III.D: Landscape Border Plan*). However, PAD-21 does not specify landscape border or screening treatments for lower intensity residential uses that are compatible with schools (i.e., single-family homes) which becomes problematic for KB Home's proposal.

a 2 e. congress ste 600 tucson az 85701 o 520.623.6146 f 520.622.1950 w azplanningcenter.com This oversight effectively creates an unsafe and indefensible space between the proposed screen wall and the school's fence. Rather than creating a dangerous situation for future residents and users of the school, KB Home – Tucson is proposing to remove the 10-foot landscape border along the eastern Property boundary. Instead, the 5-foot screen wall will be placed on the Property line. This treatment is consistent with the landscape and screening requirements as prescribed by *Unified Development Code (UDC) Section 7.6: Landscape and Screening* for single-family residential subdivisions adjacent to residentially-zoned properties. In the spirit of installing a landscape border, KB Home is committed to providing additional vegetation in the southeast corner of the Property adjacent to Littletown Road and providing one canopy tree in every front yard of the proposed subdivision. This aids in offsetting the project's urban heat island effect, furthers the City's climate change initiative and beautifies the streetscape. Per email dated December 10, 2021, Ms. Anne Warner of PDSD concurs with removing the landscape border for the proposed single-family subdivision (see *Attachment C)*.

To codify this, The Planning Center proposes to amend *Section III.D: Landscape Borders and Screening* of PAD-21 to include language that suggests appropriate landscape treatments for residential uses when developed adjacent to other residential uses or zones. Such language may include:

"No landscape borders or screen walls are required for single-family subdivisions when proposed adjacent to other residential uses or zones."

or

"For residential uses, landscape borders and screening requirements shall be provided in accordance with accordance with UDC Section 7.6."

Aside from including the language mentioned above, no other modifications to PAD-21 are proposed. Upon determining the acceptable language to include in the PAD with PDSD staff, a revised PAD will be provided in clean and redlined versions.

We appreciate your time and are prepared to discuss any questions you may have.

Thank you, THE PLANNING CENTER

Lexy Wellott, AICP Project Manager





MEMORANDUM

Date:	April 1, 2022	Job No:	KBT-50
То:	John Beall		
From:	Lexy Wellott, AICP		
Project:	Valencia Crossing PAD – Mir SUSD Meeting Summary	nor Amendment fo	r The Reserve at Valencia Crossing

This memorandum provides a brief account of the virtual meeting held on March 31, 2022, via Zoom with Mr. John Bellisario (current principal of Lauffer Middle School), Mr. Matthew Craft (incoming principal of Lauffer Middle School), Mrs. Kelly Lee (KB Home) and Miss Lexy Wellott (The Planning Center) to discuss the KB Home's proposed subdivision, and precisely, the removal of the 10-foot landscape border on the eastern boundary as required by the Valencia Crossing PAD.

Miss. Wellott and Mrs. Lee described the current zoning requirements, the impetus for the landscape border when the PAD was crafted (i.e., to ensure compatibility between commercial/employment generating uses proposed and the school), the details of the proposed subdivision, the request to remove the border, and the potential unintended consequences of installing the required landscape border. Mrs. Lee explained that instead of a 10-foot landscape border, KB Home is committed to providing a canopy tree on each lot in the subdivision and additional vegetation in the detention/retention areas adjacent to Littletown Road.

Mr. Bellisario and Mr. Craft agreed that removing the 10-foot landscape border is appropriate as it removes an indefensible space that typically invites unwanted activities. Both Mr. Bellisario and Mr. Craft expressed excitement for the proposed subdivision and stated that they were looking forward to the partnership with KB Homes.

Should you have any questions, please do not hesitate to contact me.

BASIS OF BEARING

THE SOUTH LINE OF THE SOUTHWEST QUARTER OF SECTION 11 AS MONUMENTED BY A 3.5 INCH DISC STAMPED "1/4 S11 S14 RLS 31591" AT THE SOUTH ONE QUARTER CORNER OF SAID SECTION 11 AND BY A 3" ALUMINUM DISC IN STREET WELL STAMPED "A.D.O.T. HIGHWAY DIV. "AT THE SOUTHWEST CORNER OF SAID SECTION 11. AS SHOWN ON THE FINAL PLAT FOR VALENCIA CROSSING LOTS 1-4 RECORDED AT SEQ. #20181380735. SAID BEARING BEING: NORTH 89°09'23" WEST.

BASIS OF ELEVATION

A CGS DISK IN CONCRETE STAMPED "C 317 1952", LOCATED BETWEEN 2 SETS OF RAILROAD TRACKS, ELEVATION BEING 2668.43 NAVD88.

GENERAL NOTES

- 1. EXISTING ZONING IS: PAD-21. (SEE SHEET 3 FOR PAD BOUNDARIES)
- 2. GROSS AREA OF THIS SUBDIVISION IS 10.1 AC OR 441,698 SF
- 3. EXISTING USE: VACANT

PROPOSED USE: SINGLE FAMILY RESIDENTIAL, DETACHED, IN ACCORDANCE WITH THE VALENCIA CROSSING PAD AND THE CITY OF TUCSON UNIFIED DEVELOPMENT CODE.

- 4. TOTAL NUMBER OF LOTS IS 50.
- 5. THIS PROJECT IS SUBJECT TO: 1. THE CONDITIONS OF REZONING CASE C9-12-03, VALENCIA CROSSING PLANNED AREA DEVELOPMENT (PAD-21) APPROVED ON MAY 22, 2012 2. THE AIRPORT ENVIRONS ZONE AFFECTS LOTS 1-50.
- THE PROJECT IS DESIGNED TO COMPLY WITH THE TECHNICAL MANUAL SECTION 6. 4-02, FLOODPLAIN, WASH, AND ERZ STANDARDS.
- THE DEVELOPER, ANY SUCCESSORS AND ASSIGNS, WILL HOLD THE CITY OF 7. TUCSON, ITS OFFICERS, EMPLOYEES, AND AGENTS HARMLESS FROM ANY AND ALL CLAIMS FOR DAMAGES RELATED TO THE USE OF THIS DEVELOPMENT AS SHOWN HEREON, NOW AND IN THE FUTURE, BY REASON OF FLOODING, FLOW AGE, EROSION, OR DAMAGE CAUSED BY WATER, WHETHER SURFACE FLOOD OR RAINFALL.
- 8. DRAINAGE WILL REMAIN IN ITS NATURAL STATE AND WILL NOT BE ALTERED. DISTURBED OR OBSTRUCTED OTHER THAN AS SHOWN ON THIS DEVELOPMENT PLAN.
- THE RESPONSIBILITY OF MAINTAINING THE LOCAL DETENTION BASIN RESTS WITH THE HOMEOWNER'S ASSOCIATION, PER SEC. 1.5 AND 14.3 OF THE CITY OF TUCSON DEPARTMENT OF TRANSPORTATION AND ENGINEERING DIVISION STANDARD MANUAL FOR DRAINAGE DESIGN AND FLOODPLAIN MANAGEMENT, DEC., 1989.
- 10. ALL NEW PUBLIC ROADS WITHIN AND ADJACENT TO THIS PROJECT WILL BE CONSTRUCTED IN ACCORDANCE WITH APPROVED PLANS. CONSTRUCTION PLANS WILL BE SUBMITTED TO THE CITY ENGINEER'S OFFICE FOR REVIEW AND APPROVAL.
- 11. NO STRUCTURE OR VEGETATION SHALL BE LOCATED OR MAINTAINED SO AS TO INTERFERE WITH THE SIGHT VISIBILITY TRIANGLES IN ACCORDANCE WITH SECTION 10-01.5.0, SIGHT VISIBILITY, OF THE TECHNICAL STANDARDS MANUAL.
- 12. TOTAL MILES OF NEW PUBLIC STREETS IS 0.25 MILES.
- 13. PAVING PLANS SHALL BE SUBMITTED TO THE CITY ENGINEER FOR SEPARATE REVIEW AND APPROVAL. ALL PUBLIC ROADS AND DRAINAGE IMPROVEMENTS WITHIN AND ADJACENT TO THIS DEVELOPMENT SHALL BE BUILT IN ACCORDANCE WITH THE CITY OF TUCSON DEVELOPMENT STANDARDS AND THE PIMA/CITY OF TUCSON STANDARD SPECIFICATIONS AND DETAILS.
- 14. ANY RELOCATION, MODIFICATION, ETC., OF EXISTING UTILITIES AND/OR PUBLIC IMPROVEMENTS NECESSITATED BY THE PROPOSED DEVELOPMENT WILL BE AT NO EXPENSE TO THE PUBLIC.
- 15. THE EASTERN PIMA COUNTY TRAILS SYSTEM MASTER PLAN SHOWS THE JULIAN WASH LOOP TRAIL WITHIN AND ADJACENT TO THE DEVELOPMENT SITE.
- 16. ADDITIONAL FIRE HYDRANTS SHALL BE PROVIDED BY THE DEVELOPER AS REQUIRED BY THE FIRE CODE IN ACCORDANCE WITH CITY OF TUCSON STANDARDS.
- 17. THE APPROVED GRADING AND PAVING PLAN FOR THIS PROJECT IS THE ONLY ACCEPTABLE CONSTRUCTION PLAN ON -SITE. THE CONTRACTOR MAY NOT USE ANY OTHER PLANS, SUCH AS THE APPROVED TENTATIVE PLAN AND/OR DEVELOPMENT PLAN, FOR CONSTRUCTION PURPOSES. THE CONTRACTOR MAY ASK THE COT DEVELOPMENT SERVICES INSPECTOR TO CONSULT WITH OTHER APPROVED PLANS FOR ADDITIONAL INFORMATION OR DETAILS THAT MIGHT NOT BE INCLUDED ON THESE APPROVED GRADING AND PAVING PLANS BUT IS NEEDED FOR COMPLETION OF WORK.
- 18. REFUSE AND RECYCLING SERVICE IS TO BE INDIVIDUAL WEEKLY CURBSIDE SERVICE. PLASTIC CONTAINERS (APA'S) SHALL BE PLACED AND REMOVED FROM THE CURBSIDE COLLECTION AREA ON THE DAY OF THE SERVICE AND SCREENED FROM PUBLIC VIEW WHEN STORED.
- 19. THE PERIMETER YARD REQUIREMENTS OF SECTION 6.3.4 MAY BE REDUCED FOR SETBACKS ALONG INTERIOR LOT LINES TO THE EXTENT PERMITTED BY THE CITY'S ADOPTED BUILDING CODES.
- 20. SIDEWALKS ARE NOT TO EXCEED 2% CROSS SLOPE AND 5% RUNNING SLOPE.
- 21. THE PROPERTY OWNER WILL RECORD AN AVIGATION EASEMENT PRIOR TO THE APPROVAL OF THE FINAL PLAT THAT DISCLOSES THE EXISTENCE, AND OPERATIONAL CHARACTERISTICS OF THE TUCSON INTERNATIONAL AIRPORT TO FUTURE OWNERS OR TENANTS OF THE PROPERTY AND CONVEYS TO THE RIGHT OF THE PUBLIC TO LAWFULLY USE THE AIRSPACE ABOVE THE PROPERTY.
- 22. ACCORDING TO THE FAA NOTICE CRITERIA TOOL, THIS PROJECT IS LOCATED IN PROXIMITY TO A NAVIGATION FACILITY AND COULD IMPACT NAVIGATION SIGNAL RECEPTION. THE APPLICANT SHALL FILE FORM 7460 WITH THE FAA AT LEAST 45 DAYS BEFORE CONSTRUCTION ACTIVITIES BEGIN FOR THE PROJECT.
- 23. THE DEVELOPER SHALL PROVIDE THE AIRPORT DISCLOSURE STATEMENT FORM, AT TIME OF SALE, TO THE NEW PROPERTY OWNERS WITH NEW UNIT PURCHASES. IN THE EVENT THE DEVELOPMENT OF ANY RESIDENTIAL USES DOES NOT INVOLVE THE SALE OF NEW UNITS, BUT IS INSTEAD OFFERING RENTAL RESIDENTIAL UNITS TO THE PUBLIC, THE NEW TENANT OF THE RENTAL UNIT SHALL BE PROVIDED A COPY OF THE AIRPORT DISCLOSURE STATEMENT FORM.

SEWER GENERAL NOTES

CONNECTION PERMITS.

2.

ADMINISTATIVE ADDRESS 5251 EAST LITTLETOWN ROAD

TUCSON, AZ 85756

TABULATIONS


USE: SINGLE FAMILY RESIDENTIAL USING THE TABLE III.C: DEVELOPMENT STANDARDS -RESIDENTIAL IN THE VALENCIA CROSSING PAD 21

				REQU	IR
MIN.	SITE	AREA			NC
MIN.	LOT W	/IDTH:			NC
MAX.	SITE	COVE	ERAGE	•	85
MAX.	FLOC)r are	A RA	TIO:	NC
MAX.	HE I GH	IT:			12
MIN.	BLDG	SEPAF	λΑΤΙΟΙ	۷:	ΒL
MIN.	PERIM	1E TE R	SETB	АСК:	2
DEVELO	PMENT	STANE)ARDS	FROM	Τł


STREET SETBACKS:


VALENCIA ROAD LITTLETOWN ROAD LOCAL STREETS

* FROM BACK OF CURB

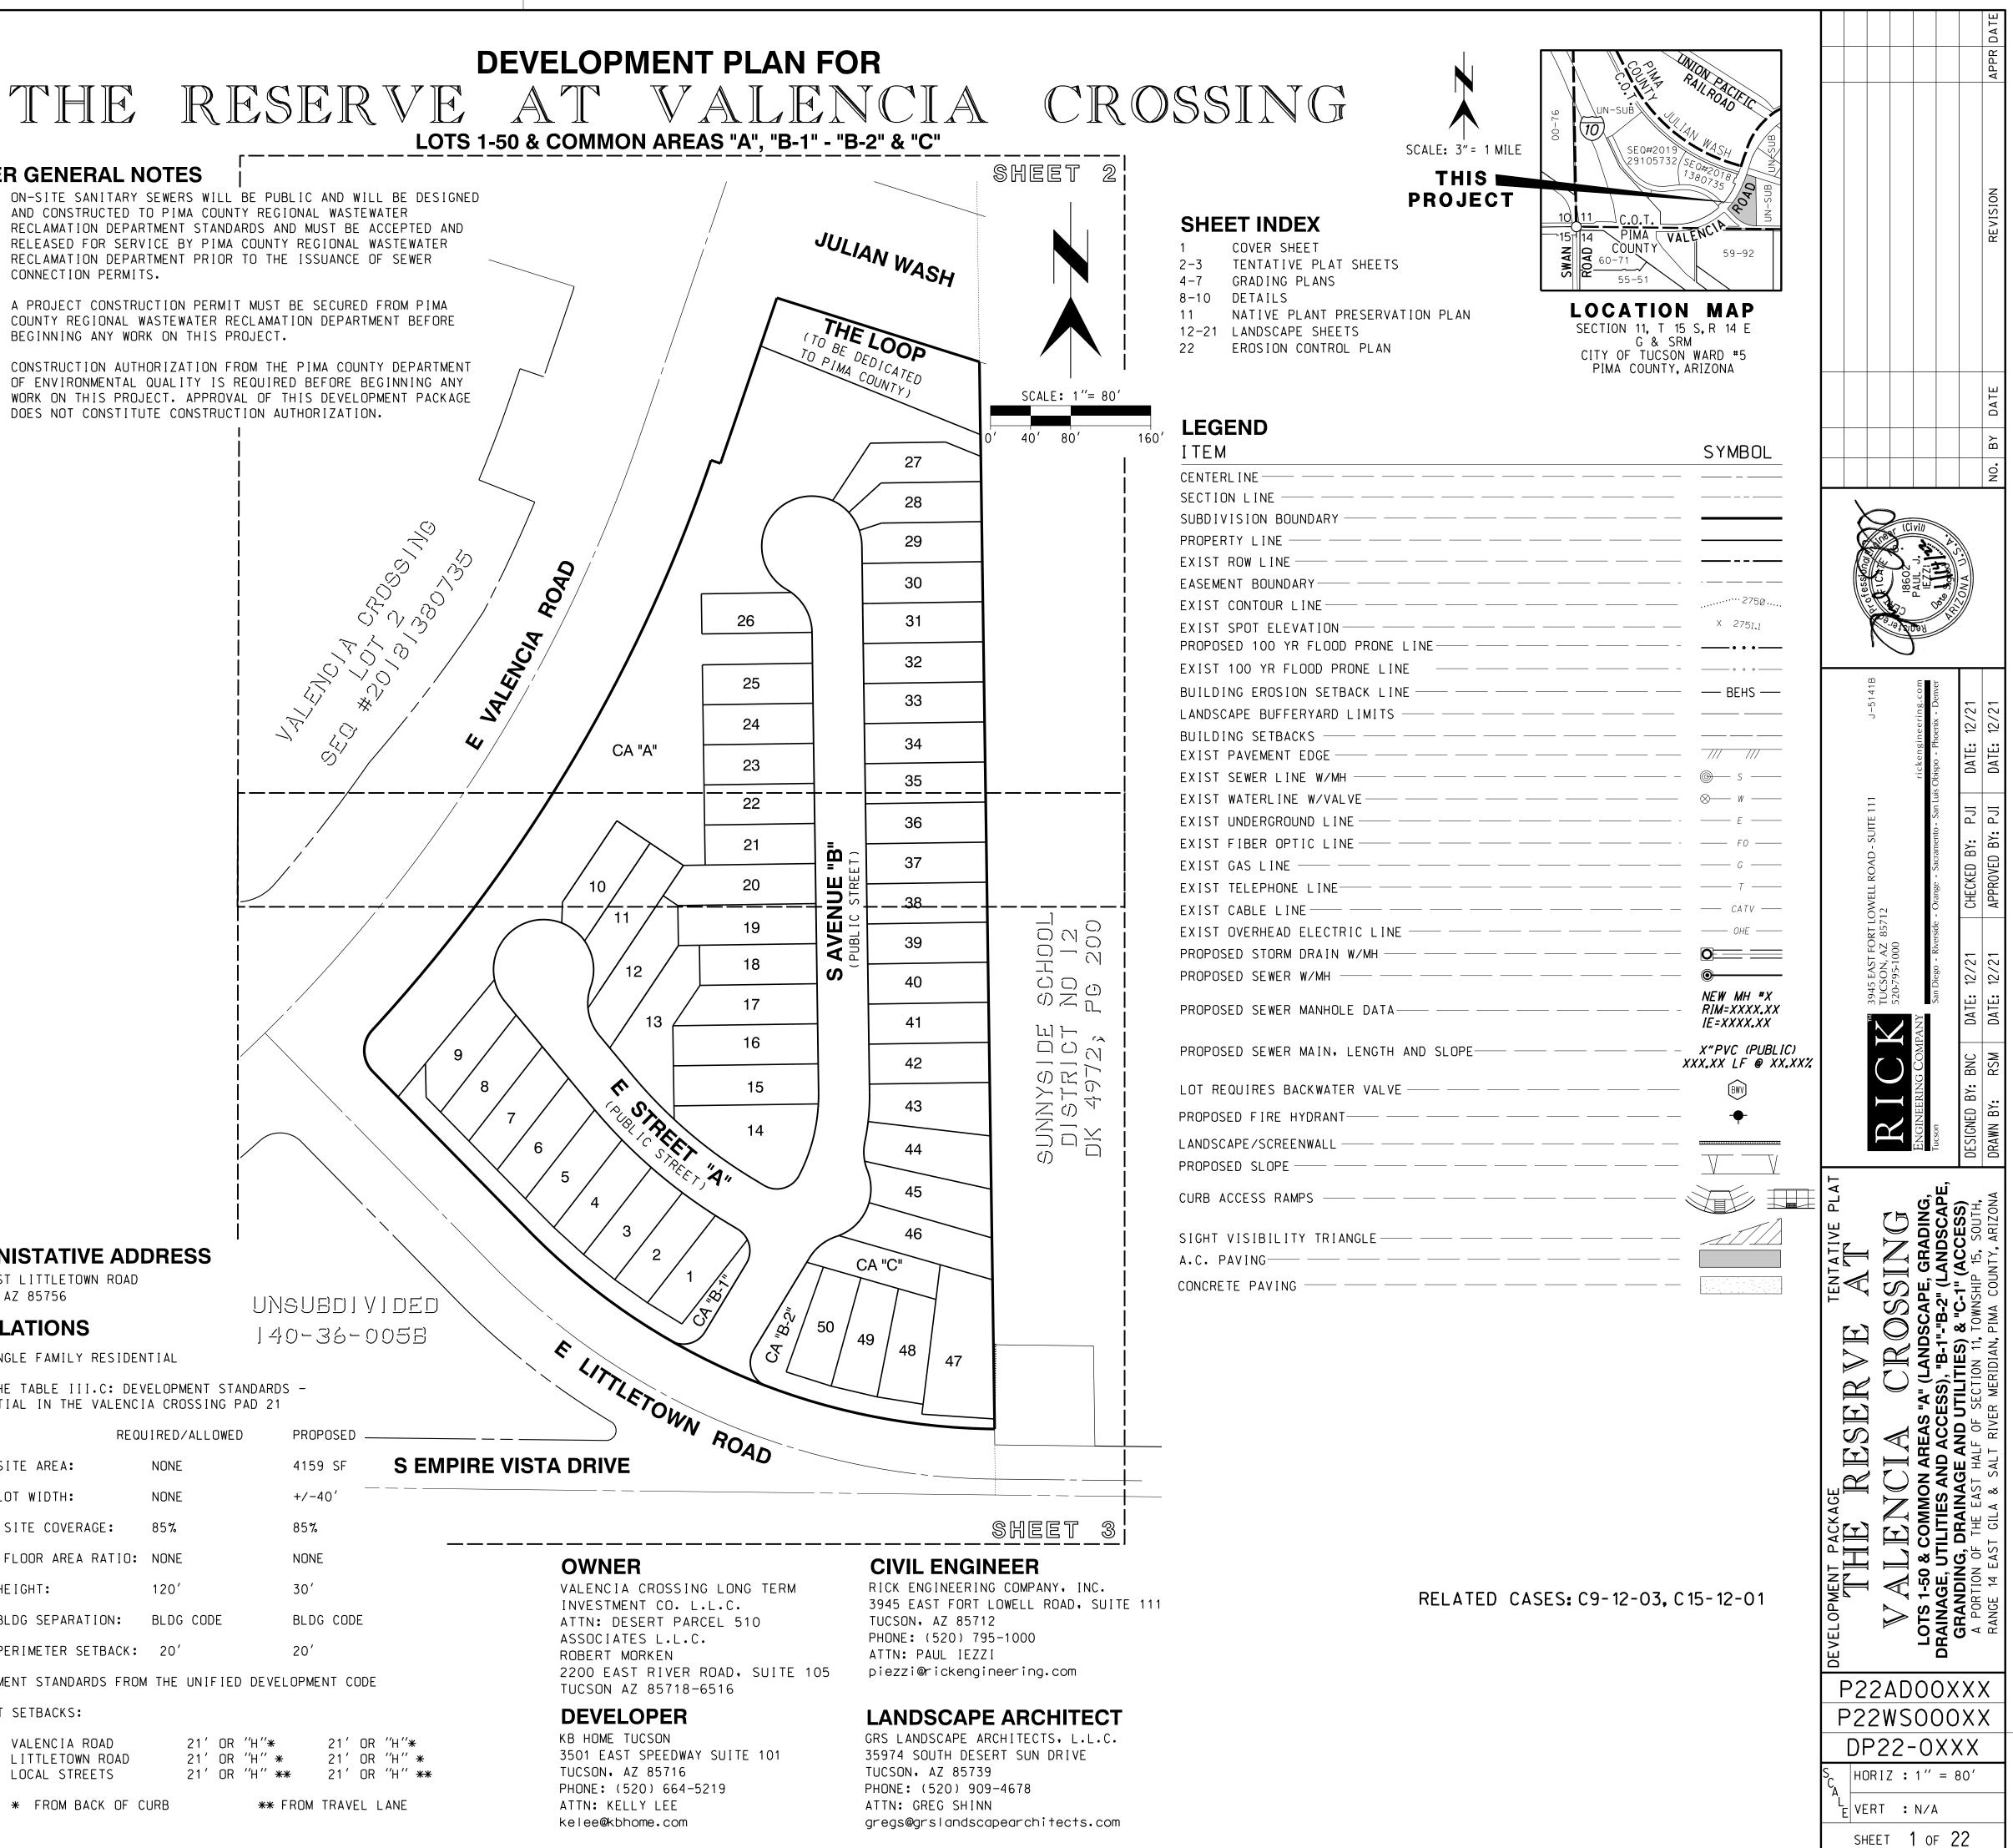

14-JAN-2022

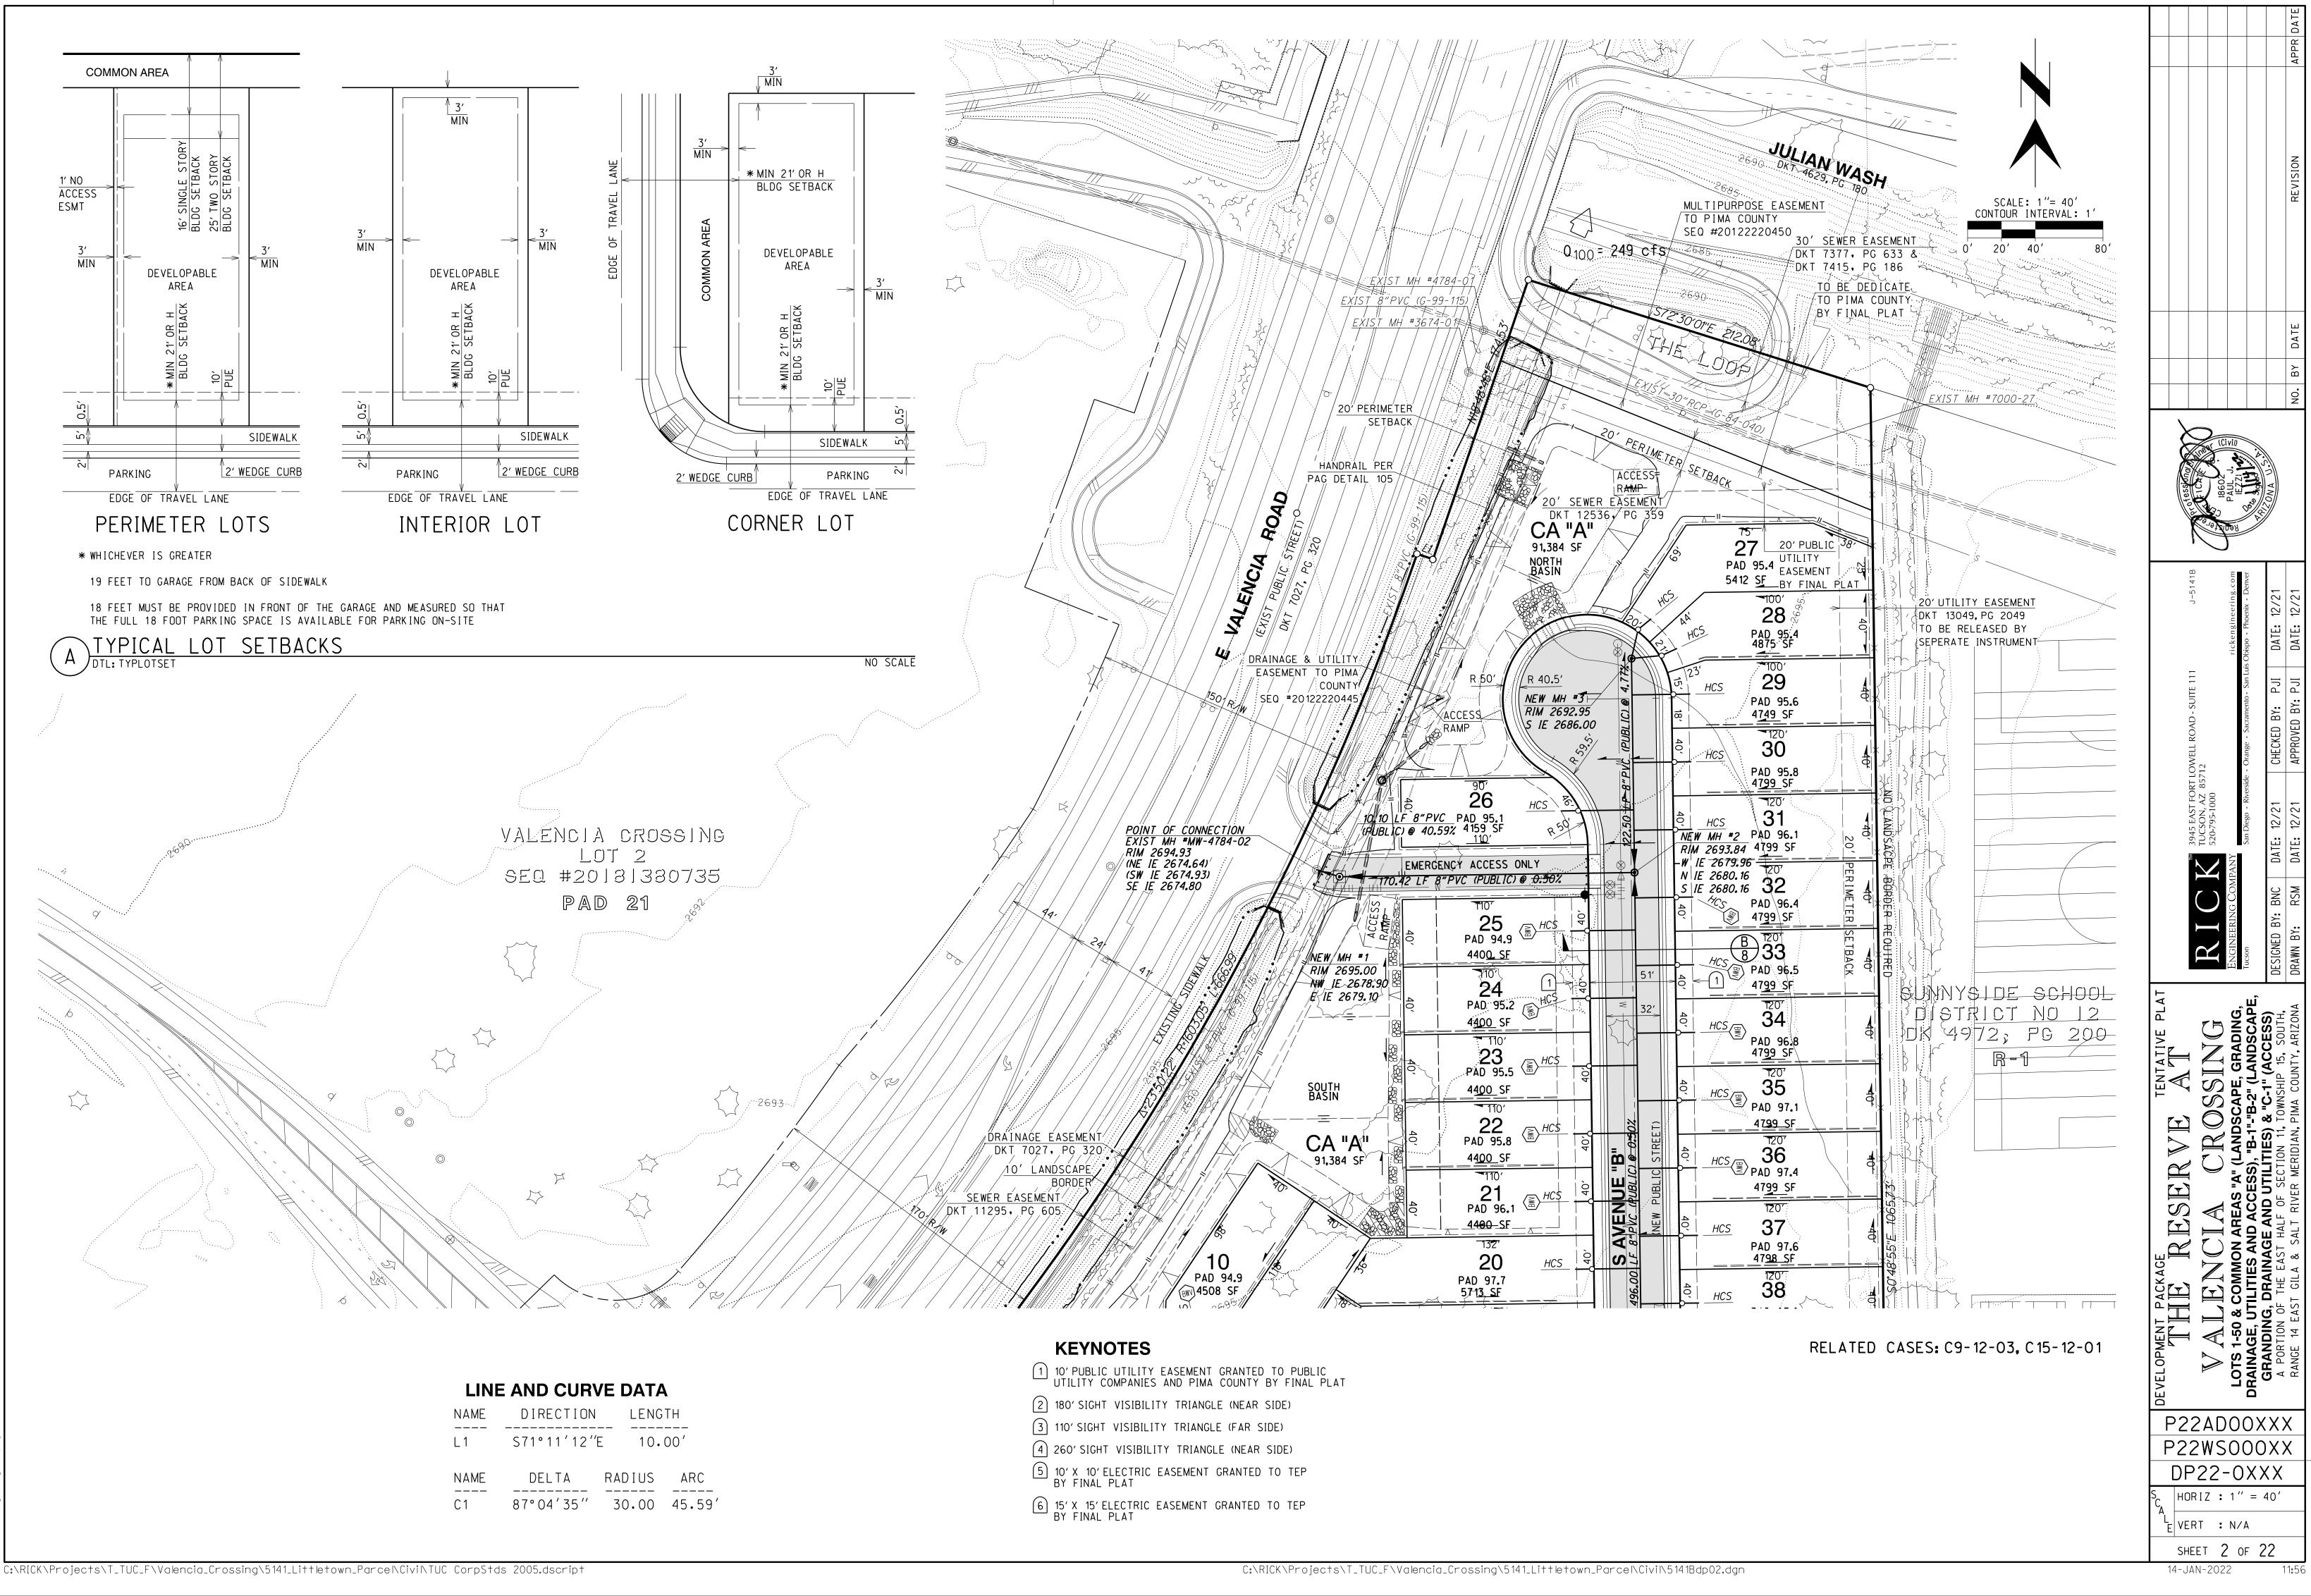

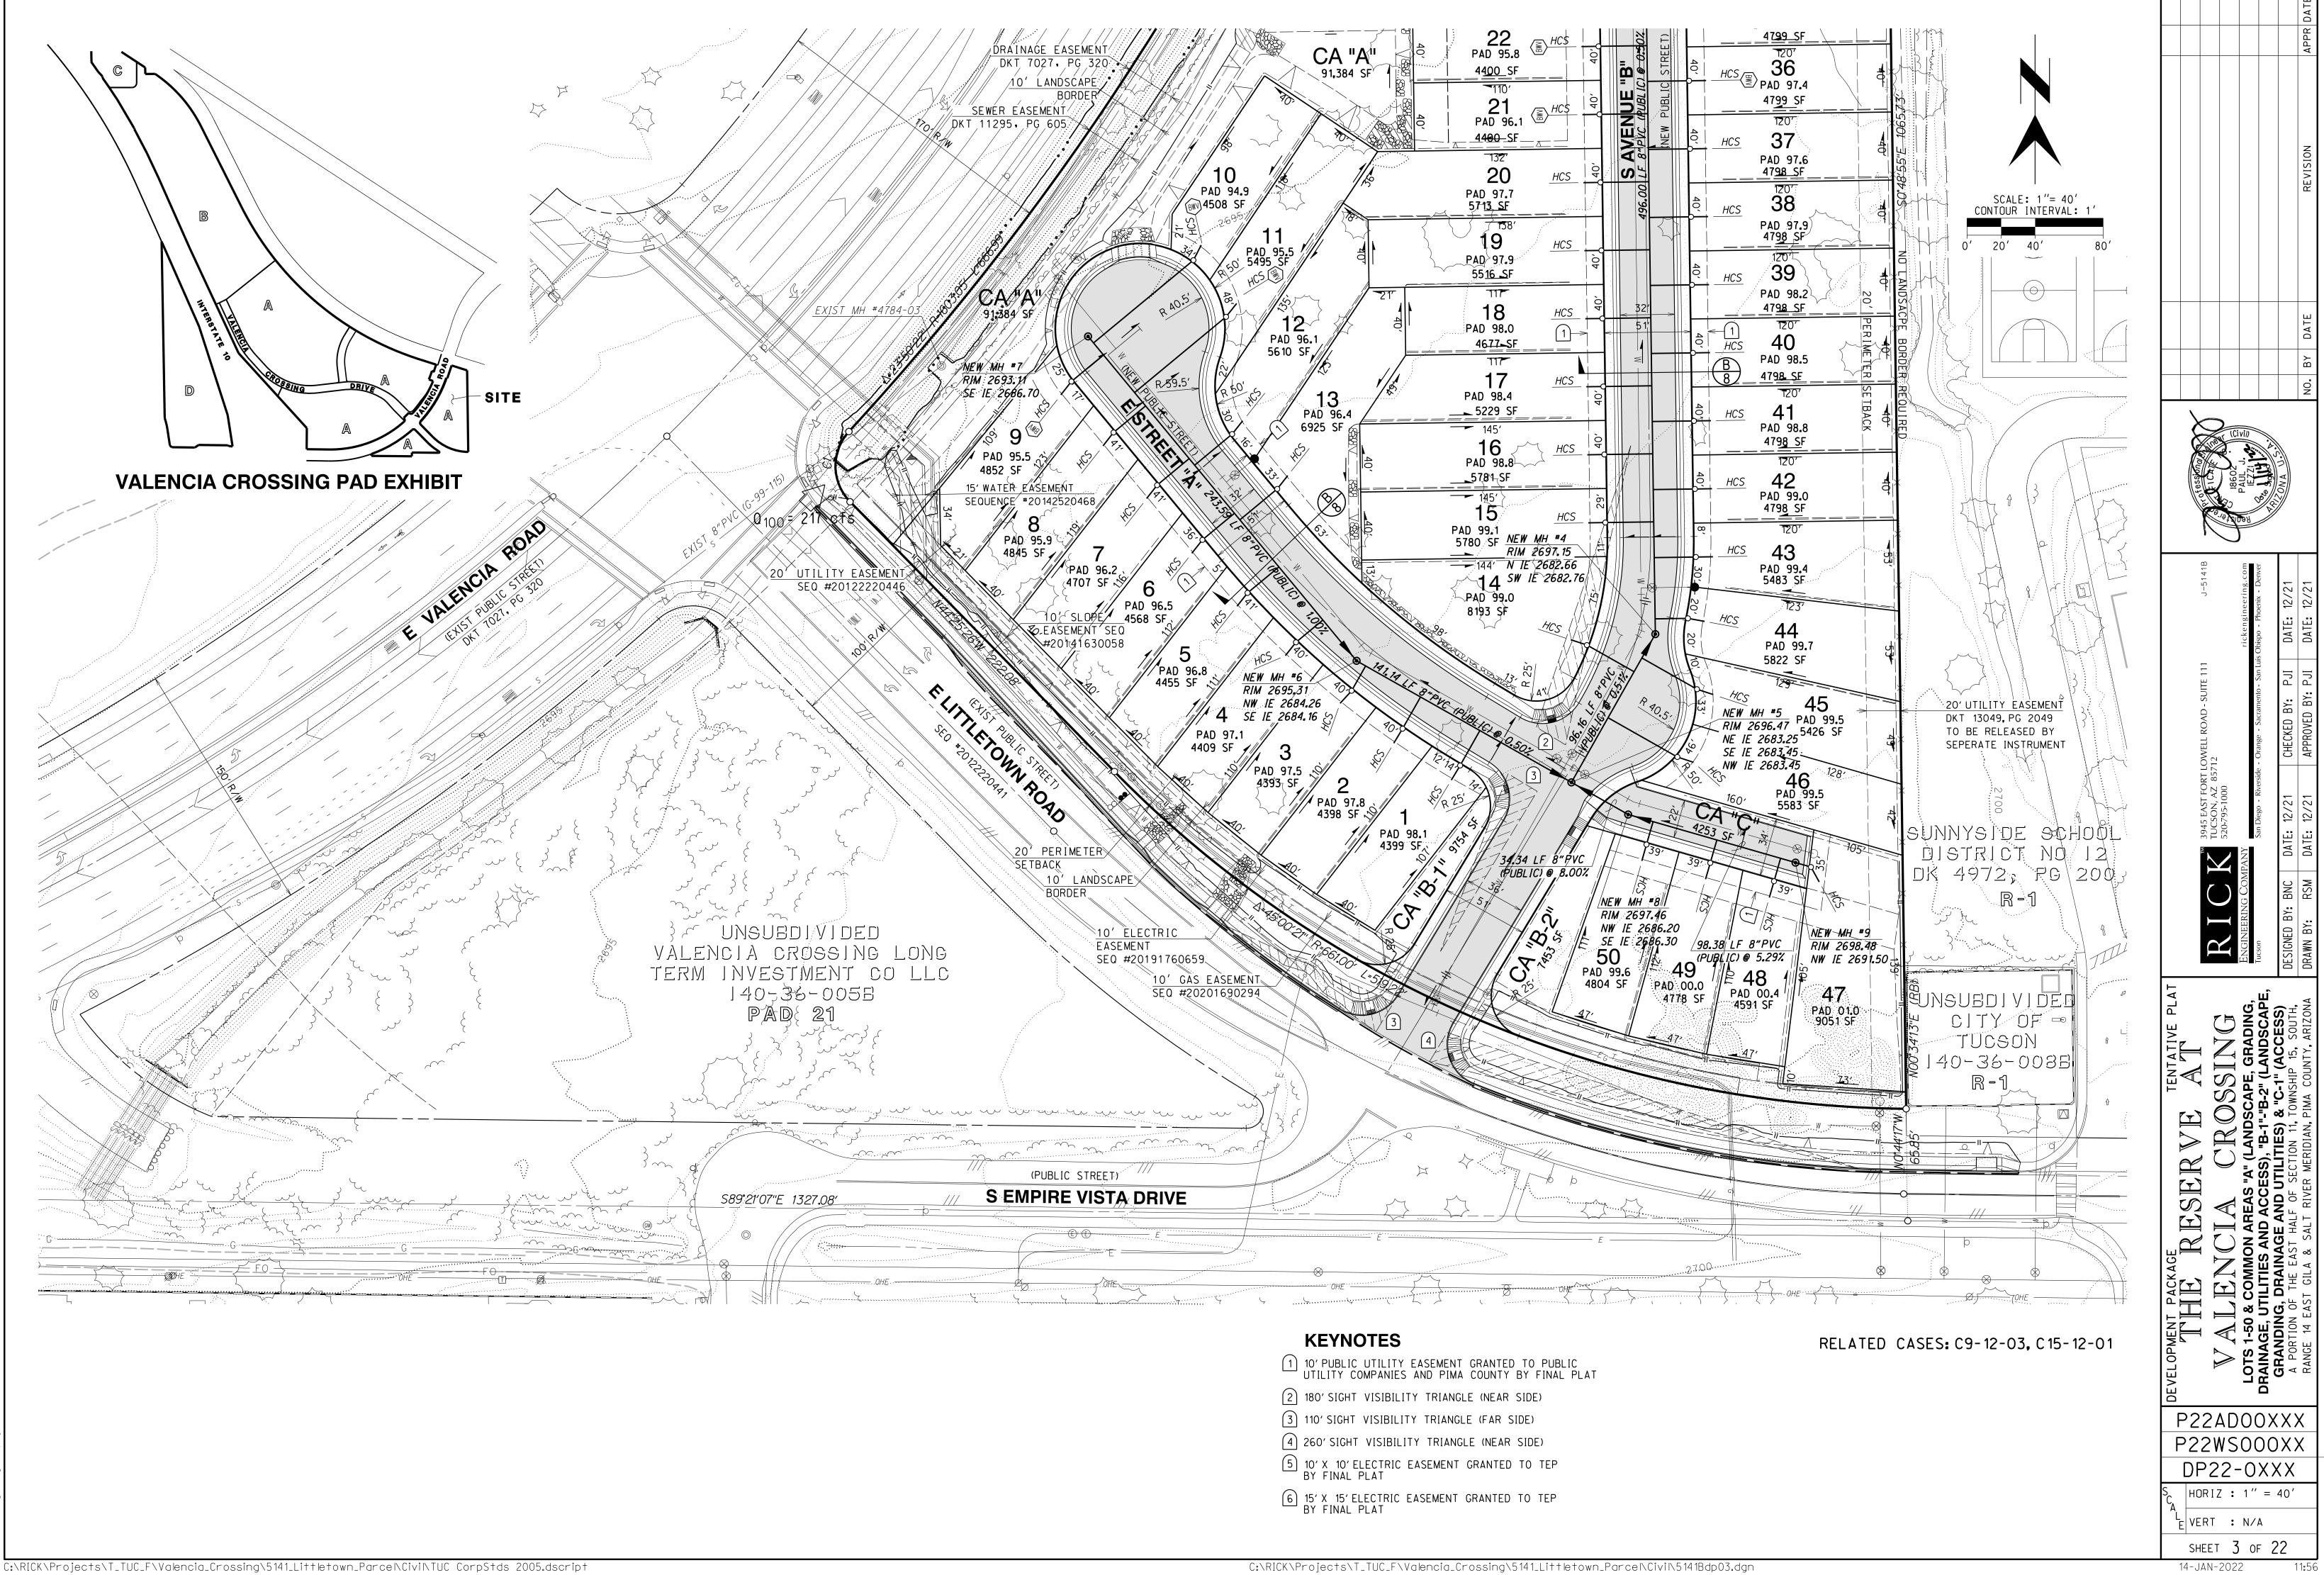



BASIS OF BEARING

THE SOUTH LINE OF THE SOUTHWEST QUARTER OF SECTION 11 AS MONUMENTED BY A 3.5 INCH DISC STAMPED "1/4 S11 S14 RLS 31591" AT THE SOUTH ONE QUARTER CORNER OF SAID SECTION 11 AND BY A 3" ALUMINUM DISC IN STREET WELL STAMPED "A.D.O.T. HIGHWAY DIV. "AT THE SOUTHWEST CORNER OF SAID SECTION 11. AS SHOWN ON THE FINAL PLAT FOR VALENCIA CROSSING LOTS 1-4 RECORDED AT SEQ. 20181380735. SAID BEARING BEING: NORTH 89°09'23" WEST.

BASIS OF ELEVATION

A CGS DISK IN CONCRETE STAMPED "C 317 1952", LOCATED BETWEEN 2 SETS OF RAILROAD TRACKS, ELEVATION BEING 2668.43 NAVD88.

GRADING NOTES


- 1. ALL CONSTRUCTION AND TEST METHODS SHALL BE IN CONFORMANCE WITH PIMA ASSOCIATION OF GOVERNMENTS (PAG) STANDARD SPECIFICATIONS AND STANDARD DETAILS FOR PUBLIC IMPROVEMENTS, 2015 EDITIONS. THESE MAY BE MODIFIED AND/OR SUPPLEMENTED BY THE REQUIREMENTS OF THESE PLANS.
- 2. AN APPROVED COPY OF THIS PLAN SHALL BE KEPT AT THE JOBSITE AT ALL TIMES DURING CONSTRUCTION.
- 3. A GEOTECHNICAL ENGINEERING INVESTIGATION, INCLUDING RECOMMENDATIONS FOR GRADING PROCEDURES HAS BEEN PREPARED BY PATTISON ENGINEERING. ALL EARTHWORK OPERATIONS SHALL CONFORM TO THE RECOMMENDATIONS CONTAINED IN SAID REPORT, DATED SEPTEMBER 16, 2021, PE JN 21-161.
- 4. THE SOILS ENGINEER SHALL OBSERVE, INSPECT, AND TEST ALL EARTHWORK OPERATIONS, INCLUDING, BUT NOT LIMITED TO, CLEARING AND GRUBBING, SUBGRADE PREPARATION, STRUCTURAL AND TRENCH EXCAVATION AND BACKFILL, AND PLACEMENT AND COMPACTION OF FILL, IN ACCORDANCE WITH THE RECOMMENDATIONS AND SPECIFICATIONS SET FORTH IN THE SOILS REPORT.
- 5. THIS APPROVED GRADING PLAN IS THE ONLY ACCEPTABLE CONSTRUCTION PLAN ONSITE. THE CONTRACTOR MAY NOT USE ANY OTHER PLANS, SUCH AS THE APPROVED TENTATIVE PLAT OR DEVELOPMENT PLAN FOR CONSTRUCTION PURPOSES. THIS PLAN IS TO BE USED FOR GRADING CONSTRUCTION ONLY. THE CONTRACTOR SHALL USE OTHER SPECIFIC IMPROVEMENT PLANS FOR CONSTRUCTION OF ALL IMPROVEMENTS OTHER THAN GRADING.
- 6. THE CONTRACTOR SHALL VERIFY LOCATIONS AND ELEVATIONS OF ALL EXISTING UTILITIES WITHIN THE WORK AREA PRIOR TO ANY CONSTRUCTION. THE CONTRACTOR SHALL CALL ARIZONA 811 AT 811, AT LEAST 2 WORKING DAYS PRIOR TO COMMENCING CONSTRUCTION.
- 7. THE CONTRACTOR SHALL GIVE FORTY-EIGHT (48) HOURS NOTICE WHEN HE SHALL REQUIRE THE SERVICES OF THE ENGINEER OR ANY OTHER PERSON PROPERLY AUTHORIZED FOR SUCH PURPOSE FOR LAYING OUT ANY PORTION OF THE WORK. HE SHALL ALSO DIG ALL STAKE HOLES NECESSARY TO GIVE LINE AND LEVELS AND SHALL PROVIDE ASSISTANCE CALLED FOR BY THE ENGINEER OR HIS ASSISTANTS UPON ANY PART OF THE WORK WHENEVER SO REQUESTED.
- THE CONTRACTOR SHALL PRESERVE ALL STAKES SET FOR THE LINES, LEVELS, AND/OR MEASUREMENTS OF THE WORK IN THEIR PROPER PLACES UNTIL AUTHORIZED TO REMOVE THEM BY THE ENGINEER. ANY EXPENSE INCURRED IN REPLACING ANY STAKES WHICH THE CONTRACTOR OR HIS SUBORDINATES MAY HAVE FAILED TO PRESERVE SHALL BE CHARGED TO THE CONTRACTOR.
- 9. ALL CONCRETE SHALL COMPLY WITH PIMA COUNTY/CITY OF TUCSON, STANDARD SPECIFICATIONS FOR PUBLIC IMPROVEMENTS, SECTION 1006, CLASS S, 3,000 PSI COMPRESSIVE STRENGTH AT 28 DAYS, UNLESS OTHERWISE SPECIFIED.
- 10. IT SHALL BE THE CONTRACTOR'S RESPONSIBILITY TO FURNISH, HAUL AND APPLY ALL WATER REQUIRED FOR COMPACTION AND FOR THE CONTROL OF DUST FROM CONSTRUCTION ACTIVITY. THE COST THEREOF IS TO BE INCLUDED IN THE GRADING CONSTRUCTION PRICE.
- 11. THE CONTRACTOR SHALL OBTAIN ALL PERMITS REQUIRED BY GOVERNMENTAL AGENCIES.
- 12. THE CONTRACTOR IS RESPONSIBLE FOR COMPLYING WITH ALL REGULATIONS AND REQUESTS BY THE CITY OF TUCSON AND PIMA COUNTY REGARDING DUST POLLUTION.
- 13. THE CONTRACTOR SHALL COMPLY WITH ALL APPLICABLE OCCUPATIONAL SAFETY AND HEALTH ADMINISTRATION REGULATIONS.
- 14. IT IS THE RESPONSIBILITY OF THE CONTRACTOR TO CALCULATE HIS OWN EARTHWORK QUANTITIES AND SUBMIT HIS BID BASED THEREON.
- 15. ALL ORGANIC MATERIAL SHALL BE REMOVED WITHIN THE CLEARING LIMITS FOR NECESSARY GRADING TO A DEPTH OF SIX (6) INCHES AND HAULED FROM THE SITE PRIOR TO GRADING.
- 16. BUILDING SITES SHALL BE CONSTRUCTED TO WITHIN 0.1 FOOT OF FINISH BUILDING PAD ELEVATIONS AS DESIGNED BY THE ENGINEER. STREETS AND PARKING AREAS SHALL BE CONSTRUCTED TO WITHIN 0.1 FEET OF FINISH SUBGRADE AS DESIGNED BY THE ENGINEER.
- 17. THE CONTRACTOR SHALL BE RESPONSIBLE FOR THE CARE, MAINTENANCE, REPAIR AND/OR REPLACEMENT OF EXISTING IMPROVEMENTS IN THE WORK AREA WHICH HAVE BEEN REMOVED AND/OR DAMAGED DURING THE COURSE OF CONSTRUCTION. ALL REPAIR, REPLACEMENT, AND/OR CLEANUP SHALL BE DONE TO THE SATISFACTION OF THE OWNER.
- 18. ANY ENGINEERING WORK TO BE DONE BELOW GRADE (I.E. TOE-DOWNS, CUTOFF WALLS, DRAINAGE PIPES/STRUCTURES, ETC.) SHALL NOT BE BACK FILLED UNTIL A PLANNING AND DEVELOPMENT SERVICES DEPARTMENT (PDSD) INSPECTOR INSPECTS THE WORK AND APPROVES IT.
- 19. THE CONTRACTOR IS NOT PERMITTED TO MAKE AN AUTONOMOUS DECISION TO CARRY OUT CONSTRUCTION FIELD CHANGES WITHOUT PRIOR WRITTEN APPROVAL FROM THE ENGINEER OF RECORD AND THE CITY OF TUCSON PDSD.
- 20. CALL FOR STORM WATER POLLUTION PREVENTION PLAN (SWPPP) INSPECTION AND PRE-CONSTRUCTION MEETINGS. FOR A PDSD ENGINEERING INSPECTION, CALL IVR AT (520) 740-6970, OR SCHEDULE WITH A CUSTOMER SERVICE REPRESENTATIVE AT THE PDSD, OR CONTACT PDSD ENGINEERING AT (520) 791-5550, EX 2101, OR SCHEDULE INSPECTIONS ONLINE AT: HTTP://CMS3.TUCSONAZ.GOV/PDSD/INSPECTIONS
- 21. THE PROJECT WILL BE IN COMPLIANCE WITH CITY OF TUCSON TECHNICAL STANDARDS MANUAL SECTION 2-01.0.0 (EXCAVATING AND GRADING).

FOR CONTINUATION OF GRADING NOTES SEE SHEET 5

EARTHWORK QUANTITIES:

CUT:	8,760
FILL:	8,760
IMPORT/EXPORT:	0 CY

C:\RICK\Projects\T_TUC_F\Valencia_Crossing\5141_Littletown_Parcel\Civil\TUC_CorpStds_2005.dscript

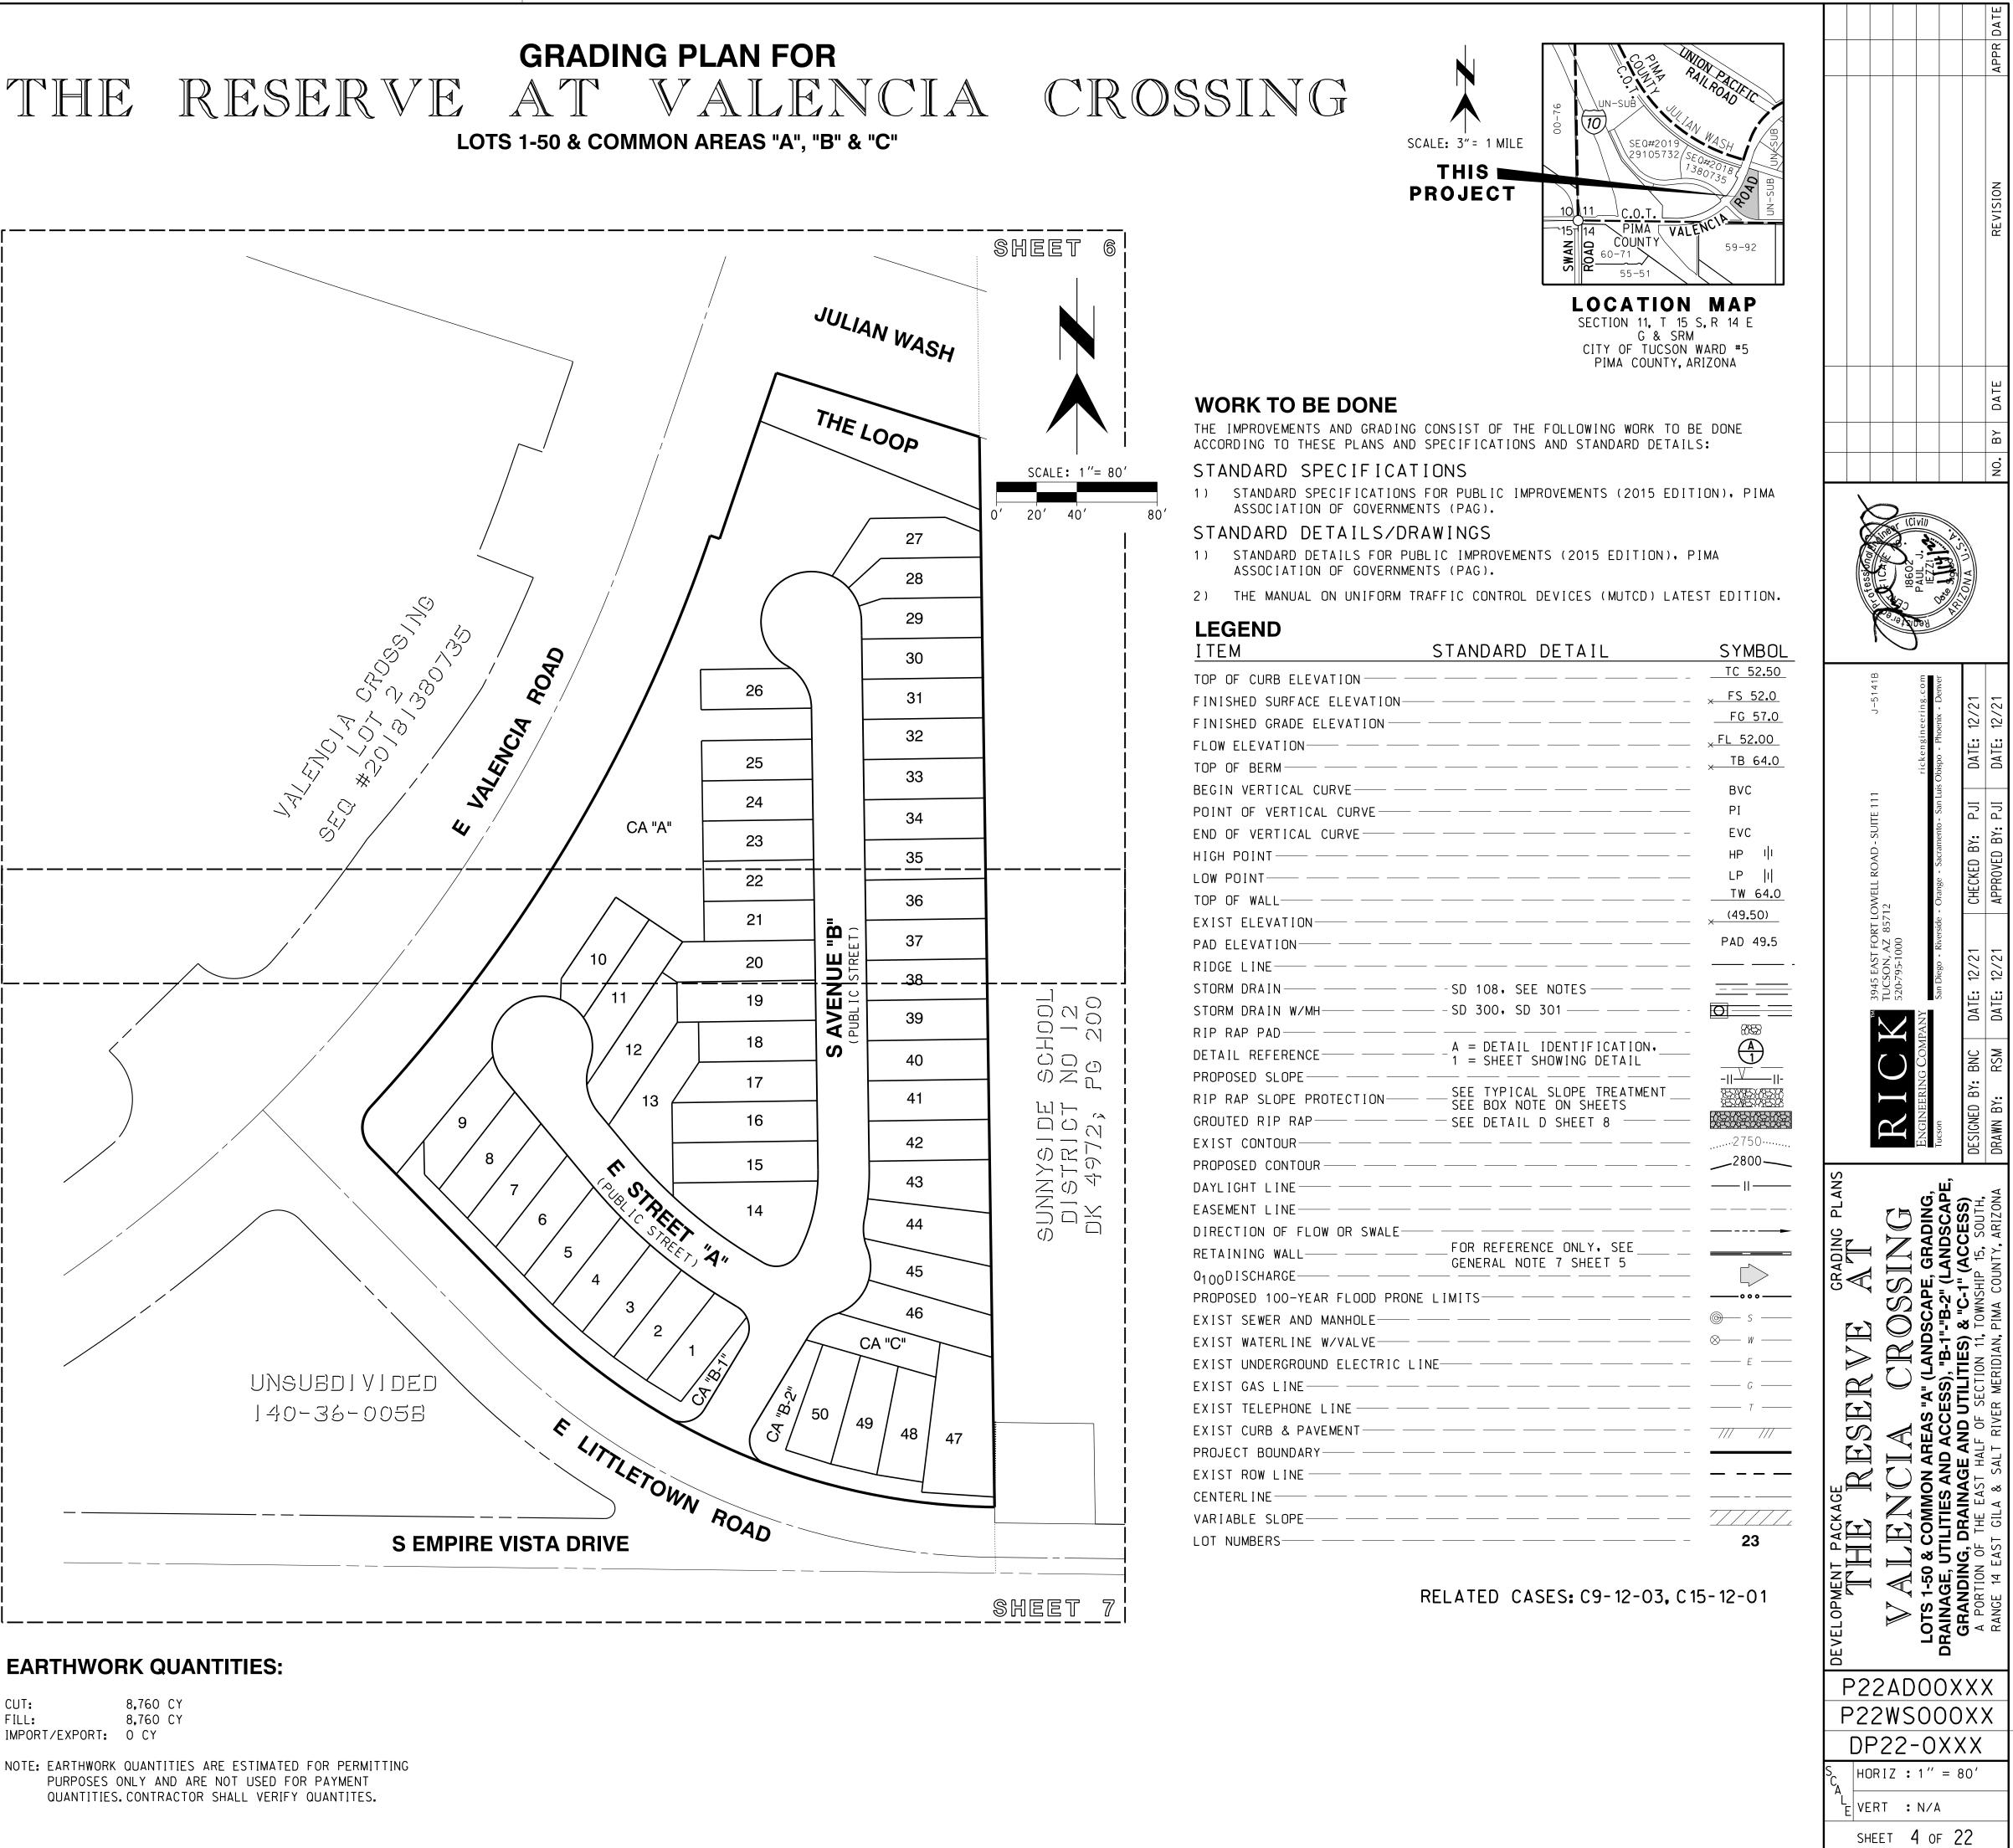

NOTE: EARTHWORK QUANTITIES ARE ESTIMATED FOR PERMITTING PURPOSES ONLY AND ARE NOT USED FOR PAYMENT QUANTITIES. CONTRACTOR SHALL VERIFY QUANTITES.

14-JAN-2022

22. A COPY OF THE APPROVED GRADING PLAN, GRADING PERMIT, AND ANY GEOTECHNICAL REPORTS SHALL BE KEPT AT THE SITE AT ALL TIMES, UNTIL FINAL GRADING APPROVAL. 23. ANY REVISION TO THE GRADING PLAN MAY REQUIRE A RE-SUBMITTAL OF A REVISED GRADING PLAN FOR REVIEW. CONTACT PDSD ENGINEERING AT (520) 791-5550 TO DISCUSS CHANGES IN GRADING DESIGN. 24. IF GRADING CONSTRUCTION IS EXPECTED TO LAST LONGER THAN THE EXPIRATION DATE OF THE GRADING PERMIT, CONTACT PDSD TO RENEW/EXTEND THE GRADING PERMIT. IF FINAL GRADING INSPECTION HAS NOT BEEN COMPLETED BEFORE THE GRADING PERMIT EXPIRES, AND THE PERMIT HAS NOT BEEN RENEWED, ADDITIONAL FEES AND REVIEWS MAY BE REQUIRED. 25. THE OWNER SHALL BE SOLELY RESPONSIBLE FOR OPERATION, MAINTENANCE AND LIABILITY FOR DRAINAGE STRUCTURES. 26. THE PERMITTEE SHALL NOTIFY THE PDSD WHEN THE GRADING OPERATION IS READY FOR FINAL GRADING INSPECTION. FINAL GRADING APPROVAL SHALL NOT BE GIVEN UNTIL ALL WORK, INCLUDING INSTALLATION OF ALL DRAINAGE FACILITIES AND THEIR PERMANENT PROTECTIVE DEVICES, AND ALL EROSION CONTROL MEASURES HAVE BEEN COMPLETED IN ACCORDANCE WITH THE APPROVED GRADING PLAN AND GRADING PERMIT, AND ANY REQUIRED REPORTS HAVE BEEN SUBMITTED. 27. DEPRESS ALL LANDSCAPE AREAS A MAXIMUM OF 9-INCHES FOR WATER HARVESTING. 28. THE CONTRACTOR SHALL REMOVE THE FINE MATERIALS FROM THE BOTTOM OF ALL DRAINAGE RELATED BASINS AND SCARIFY THEIR BOTTOMS ONCE THE CONSTRUCTION 9. ALL NOTES SHALL CROSS-APPLY TO ALL CONSTRUCTION DISCIPLINES INVOLVED ACTIVITIES ARE COMPLETED, IN ORDER TO REMOVE ANY FINE MATERIAL BUILD UP CAUSED BY CONSTRUCTION AND TO RESTORE SOIL PERCOLATION. BMP'S MAY BE INSTALLED AT THE BASIN INLET(S) TO PREVENT THE FINES FROM ENTERING THE 10. FACE OF CURB REVEAL IS 6 INCHES UNLESS OTHERWISE SHOWN. BASIN. 29. SEE THE ASSOCIATED STORM WATER POLLUTION PREVENTION PLAN (SWPPP) AS A PART OF THIS GRADING PERMIT. 30, CONTACT PERMITS AND CODES AT (520) 791-5100 FOR ANY QUESTIONS REGARDING 12, CONTRACTOR IS REQUIRED TO TAKE PRECAUTIONARY MEASURES TO PROTECT THE ANY RIGHT-OF-WAY PERMIT REQUIREMENTS. 31. AS-BUILTS AND LETTERS OF COMPLETION FOR BASIN (AND OVERALL PROJECT) IS (ARE) REQUIRED. 32. A PROFESSIONAL ENGINEER, REGISTERED IN THE STATE OF ARIZONA, SHALL SUBMIT A STATEMENT OF CONFORMANCE TO AS-BUILT PLAN AND THE SPECIFICATIONS. MAINTENANCE OF DETENTION/RETENTION FACILITIES 33. THE OWNER, OR HOMEOWNER'S ASSOCIATION SHALL BE SOLELY RESPONSIBLE FOR OPERATION, MAINTENANCE AND LIABILITY FOR PRIVATE DRAINAGE STRUCTURES AND DETENTION/RETENTION BASINS. 34. THE OWNER OR HOMEOWNER'S ASSOCIATION SHALL HAVE AN ARIZONA REGISTERED PROFESSIONAL CIVIL ENGINEER PREPARE A CERTIFIED INSPECTION REPORT FOR THE PRIVATE DRAINAGE AND DETENTION/RETENTION FACILITIES AT LEAST ONCE EACH YEAR. THESE CERTIFIED REPORTS WILL BE ON FILE WITH THE OWNER FOR REVIEW BY CITY STAFF, UPON WRITTEN REQUEST. 35. CITY STAFF MAY PERIODICALLY INSPECT THE PRIVATE DRAINAGE AND DETENTION/RETENTION FACILITIES TO VERIFY THAT SCHEDULED AND UNSCHEDULED MAINTENANCE ACTIVITIES ARE BEING PERFORMED ADEQUATELY. 36. THE OWNER OR HOMEOWNER'S ASSOCIATION AGREE TO REIMBURSE THE CITY FOR ANY AND ALL COSTS ASSOCIATED WITH MAINTAINING THE PRIVATE DRAINAGE AND DETENTION/RETENTION FACILITIES, SHOULD THE CITY FIND THE OWNER(S) OR HOMEOWNER'S ASSOCIATION DEFICIENT IN THEIR OBLIGATION TO ADEQUATELY OPERATE AND MAINTAIN THEIR FACILITIES. STORM DRIAN NOTES 1. SUBSTITUTION OF ANY MATERIALS FOR CONSTRUCTION OF STORM DRAIN WILL NOT BE ALLOWED UNLESS FIRST APPROVED BY THE ENGINEER OF WORK. 2. STORM DRAINS ARE TO BE CONSTRUCTED IN COMPLIANCE WITH PIMA ASSOCIATION OF GOVERNMENTS (PAG) STANDARD SPECIFICATIONS AND STANDARD DETAILS FOR PUBLIC IMPROVEMENTS, 2015 EDITIONS. THESE MAY BE MODIFIED AND/OR SUPPLEMENTED BY THE REQUIREMENTS OF THESE PLANS. 3. SRP STORM DRAIN SHALL BE CONTECH ULTRA-FLO ALUMINIZED STEEL PIPE 3/4" X 3/4" X 7-1/2" CORRUGATIONS OR EQUIVALENT, 12 GAGE THICKNESS. PIPE AND BEDDING SHALL BE INSTALLED PER MANUFACTURER'S RECOMMENDATIONS AND STANDARD DETAIL NO. 108 4. CMP STORM DRAIN SHALL BE CONTECH CORRUGATED STEEL PIPE, 2-2/3" X 21. IT SHALL BE THE CONTRACTOR'S RESPONSIBILITY TO FULLY COMPLY WITH THE 1/2" ANNULAR CORRUGATIONS OR EQUIVALENT. 14 GAGE THICKNESS. PIPE AND BEDDING SHALL BE INSTALLED PER MANUFACTURER'S RECOMMENDATIONS AND STANDARD DETAIL NO. 108. **ENGINEER'S GENERAL NOTES** 1. CURB RADII ARE MEASURED TO FRONT FACE OF CURB. 2. THE CONTRACTOR SHALL VERIFY EXISTENCE OF ALL UTILITIES BY CALLING ARIZONA 811 AT 811 TWO (2) WORKING DAYS PRIOR TO CONSTRUCTION. THE PLAN LOCATIONS OF EXISTING UTILITIES BEING SHOWN ARE APPROXIMATE. 3. THE CONTRACTOR AGREES TO PROTECT ALL ADJACENT PROPERTY AND EXISTING IMPROVEMENTS, INCLUDING POSITIVE CONTROL OF EARTH SPILLAGE, CONSTRUCTION 24. THE GRADING CONTRACTOR SHALL EXCAVATE AND REMOVE THE SOIL BENEATH ALL WATER, AND RUNOFF WATERS. 4. THE CONTRACTOR AGREES THAT HE SHALL ASSUME SOLE AND COMPLETE RESPONSIBILITY FOR JOBSITE CONDITIONS DURING THE COURSE OF THE PROJECT, INCLUDING SAFETY OF ALL PERSONS AND PROPERTY. THIS REQUIREMENT SHALL 25. ALL RIP RAP IS NOT SHOWN FOR CLARITY. REFER TO THE TYPICAL SLOPE APPLY CONTINUOUSLY AND NOT BE LIMITED TO NORMAL WORKING HOURS. THE CONTRACTOR SHALL DEFEND, INDEMNIFY AND HOLD THE OWNER AND THE ENGINEER HARMLESS FROM ANY AND ALL LIABILITY, REAL OR ALLEGED, IN CONNECTION WITH 26. THE GRADING CONTRACTOR SHALL EXCAVATE AND REMOVE THE SOIL BENEATH ALL THE PERFORMANCE OF WORK ON THIS PROJECT, EXCEPTING FOR LIABILITY ARISING FROM THE SOLE NEGLIGENCE OF THE OWNER OR THE ENGINEER.

GRADING NOTES - CONTINUED

ENGINEER'S GENERAL NOTES - CONTINUED

- UTILITIES CAUSED BY HIS OPERATIONS.
- CALLING THE ENGINEER OF WORK AT (520) 795-1000.
- UNDER THE GRADING PERMIT FOR THIS PROJECT.
- BE USED FOR BIDDING OR PAYMENT QUANTITIES.
- WITH THIS PROJECT.
- **REFERENCE**.
- TO THE GRADING LIMITS SHOWN.
- GRADING.
- OPERATIONS.
- OFF-SITE BY THE CONTRACTOR.
- PRESERVE, SHALL BE CHARGED TO THE CONTRACTOR.
- AREA TO BE GRADED.

- THIS PROJECT.
- NOTED.
- AREAS TO BE RIP RAPPED.
- THESE PLANS.

C:\RICK\Projects\T_TUC_F\Valencia_Crossing\5141_Littletown_Parce\Civi\TUC_CorpStds_2005.dscript

5. THE EXISTENCE AND LOCATION OF ANY EXISTING UNDERGROUND UTILITIES OR STRUCTURES SHOWN ON THESE PLANS WERE OBTAINED BY A SEARCH OF THE AVAILABLE RECORDS. APPROVAL OF THIS PLAN DOES NOT CONSTITUTE A REPRESENTATION OF THE ACCURACY OR COMPLETENESS OF THE LOCATION OR THE EXISTENCE OR NONEXISTENCE OF ANY UNDERGROUND UTILITY OR STRUCTURE WITHIN THE LIMITS OF THIS PROJECT. THE CONTRACTOR IS REQUIRED TO TAKE ALL PRECAUTIONARY MEANS TO PROTECT ANY UTILITY NOT OF RECORD OR NOT SHOWN ON THESE PLANS. THE CONTRACTOR SHALL VERIFY LOCATIONS AND ELEVATIONS OF ALL UTILITIES PRIOR TO ANY CONSTRUCTION. THE CONTRACTOR SHALL BE SOLELY AND COMPLETELY RESPONSIBLE FOR COSTS INCURRED AS A RESULT OF DAMAGE TO

6. IF THERE ARE ANY QUESTIONS REGARDING THESE PLANS OR FIELD STAKES, THE CONTRACTOR SHALL REQUEST AN INTERPRETATION BEFORE DOING ANY WORK BY

7. RETAINING WALLS AND/OR SCREEN WALLS REFERENCED ON THIS PLAN ARE TO BE DESIGNED BY OTHERS. ELEVATIONS SHOWN HEREON ARE FOR REFERENCE ONLY. THE CONTRACTOR SHALL CONFIRM EXACT ELEVATIONS. ALL RETAINING WALLS AND/OR SCREEN WALLS REQUIRE A SEPARATE BUILDING PERMIT AND ARE NOT COVERED

8. IT IS THE RESPONSIBILITY OF THE CONTRACTOR TO CALCULATE HIS OWN EARTHWORK QUANTITIES AND SUBMIT HIS BID THEREON. EARTHWORK QUANTITIES SHOWN HEREON ARE ESTIMATED FOR PERMITTING PURPOSES ONLY AND ARE NOT TO

11. SOME ELEVATIONS ARE SHORTENED FOR CLARITY, REMOVING THE THOUSAND AND HUNDRED UNIT VALUES. SEE BASIS OF ELEVATION FOR FULL ELEVATION

NATIVE VEGETATION WITHIN ALL OPEN SPACE AREAS AND CONFINE HIS OPERATIONS

13. WRITTEN PERMISSION SHALL BE OBTAINED IN ADVANCE FOR ANY OFF-SITE

14. THE CONTRACTOR SHALL FACILITATE THE WORK OF THE SOILS ENGINEER DURING

15. ALL EARTHWORK OPERATIONS SHALL BE DONE UNDER THE OBSERVATION OF A SOILS ENGINEER AND IN ACCORDANCE WITH THE RECOMMENDATIONS AND SPECIFICATIONS SET FORTH IN THE SOILS REPORT. THE SOILS ENGINEER SHALL OBSERVE, INSPECT, AND TEST ALL EARTHWORK OPERATIONS, INCLUDING, BUT NOT LIMITED TO, CLEARING AND GRUBBING, SUBGRADE PREPARATION, STRUCTURAL AND TRENCH EXCAVATION AND BACKFILL, AND PLACEMENT AND COMPACTION OF FILL.

16. CUT AND FILL SLOPES SHALL BE TRIMMED TO THE FINISH GRADE TO PRODUCE A UNIFORM CROSS-SECTION. THE SLOPE OF THE EXCAVATIONS OR EMBANKMENTS SHALL BE SHAPED AND TRIMMED AS SHOWN ON THE PLANS AND LEFT IN A NEAT AND ORDERLY CONDITION. ALL STONES, ROOTS, OR OTHER WASTE MATTER EXPOSED ON EXCAVATION OR EMBANKMENT SLOPES SHALL BE REMOVED AND LEGALLY DISPOSED OF

17. THE CONTRACTOR SHALL PRESERVE ALL STAKES SET FOR THE LINES, LEVELS OR MEASUREMENTS OF THE WORK IN THEIR PROPER PLACES UNTIL AUTHORIZED TO REMOVE THEM BY THE ENGINEERS. ANY EXPENSE INCURRED IN REPLACING ANY STAKES WHICH THE CONTRACTOR OR HIS SUBORDINATES MAY HAVE FAILED TO

18. PRIOR TO THE START OF GRADING, ALL VEGETATION AND OBSTRUCTIONS, AS WELL AS TRASH, SHALL BE REMOVED FROM CUT AND FILL AREAS AND LEGALLY DISPOSED OF OFF-SITE. ANY EXISTING IRRIGATION, DRAINAGE OR UTILITY LINES OR OTHER ABANDONED SUBSURFACE STRUCTURES SHALL BE REMOVED, DESTROYED OR ABANDONED IN COMPLIANCE WITH SPECIFICATIONS OF THE APPROPRIATE BUILDING OFFICE OR THE SOILS ENGINEER. BRUSH SHALL BE REMOVED ONLY WITHIN THE

19. THE FINAL TEST RESULTS AND APPROVAL FROM THE SOILS ENGINEER SHALL CONTAIN THE TYPE OF FIELD TESTING PERFORMED AND SUBMITTED TO THE OWNER. EACH TEST SHALL BE IDENTIFIED WITH THE METHOD OF OBTAINING THE IN-PLACE DENSITY, WHETHER SAND CONE, DRIVE RING, OR NUCLEAR DENSITY GAUGE.

20. EXISTING MANHOLE RIMS, VALVE COVERS, ETC., TO REMAIN IN PLACE, SHALL BE ADJUSTED TO PROPOSED FINISHED GRADE AND/OR FINISHED SURFACE ELEVATIONS.

ARIZONA POLLUTANT DISCHARGE ELIMINATION SYSTEM GENERAL PERMIT IN ACCORDANCE WITH THE STORM WATER POLLUTION PREVENTION PLAN PREPARED FOR

22. ALL STATIONING IS MEASURED ALONG THE STREET CENTERLINE, UNLESS OTHERWISE

23. THE GENERAL CONTRACTOR SHALL COORDINATE ALL RIP RAP SLOPE TREATMENT REQUIREMENTS WITH THE LANDSCAPE CONTRACTOR. LANDSCAPE PLANTINGS AND IRRIGATION LINES WITHIN AREAS TO BE RIP RAPPED SHALL BE COORDINATED TO FACILITATE THE WORK OF THE LANDSCAPE CONTRACTOR BEFORE THE RIP RAP IS PLACED. SEE LANDSCAPE PLANS FOR PLANTINGS AND IRRIGATION LINES WITHIN

PROPOSED RIP RAP AREAS SUCH THAT THE FINISHED SURFACE OF THE RIP RAP WILL MATCH THE FINISHED SURFACE ELEVATION AND SLOPE AS CALLED OUT ON

TREATMENT BOX FOR SURFACE TREATMENT OF FINISHED SLOPE FACES.

DECOMPOSED GRANITE AREAS SO THAT THE FINISHED SURFACE OF THE DECOMPOSED GRANITE WILL MATCH THE FINISHED SURFACE ELEVATION AS CALLED OUT ON THESE PLANS. WATER HARVESTING AREAS SHALL BE KEPT LOW TO ACHIEVE THE FULL DEPTH OF WATER HARVESTING TO THE FINISHED SURFACE OF THE DECOMPOSED GRANITE. SEE LANDSCAPE PLANS FOR DECOMPOSED GRANITE AREAS.

ENGINEER'S GENERAL NOTES - CONTINUED


27. THE BOTTOMS OF ALL WATER HARVESTING AREAS SHALL BE COMPACTED IN ACCORDANCE WITH THE SOILS ENGINEER'S RECOMMENDATIONS TO FACILITATE GROUNDWATER INFILTRATION. DECOMPOSED GRANITE USED IN WATER HARVESTING AREAS SHALL BE SCREENED PRIOR TO PLACEMENT TO REMOVE ALL FINE MATERIAL. WATER HARVESTING AREAS SHALL NOT BE UTILIZED FOR WORKER PARKING OR MATERIAL STORAGE AT ANYTIME DURING CONSTRUCTION.


28. THE BOTTOMS OF ALL RETENTION AND/OR DETENTION BASINS SHALL BE COMPACTED IN ACCORDANCE WITH THE SOILS ENGINEER'S RECOMMENDATIONS TO FACILITATE GROUNDWATER INFILTRATION AND SHALL REMAIN "NATURAL", IE, DECOMPOSED GRANITE, RIP RAP, HYDROSEED OR OTHER GROUND COVER SHALL NOT BE PLACED IN THE BASIN BOTTOMS. WHENEVER POSSIBLE IRRIGATION LINES AND EQUIPMENT SHALL ALSO NOT BE PLACED WITHIN THE BASIN BOTTOMS, RETENTION AND/OR DETENTION BASINS/AREAS SHALL NOT BE UTILIZED FOR WORKER PARKING OR MATERIAL STORAGE AT ANYTIME DURING CONSTRUCTION. THE CONTRACTOR SHALL SCARIFY ALL RETENTION AND/OR DETENTION BASIN BOTTOMS IMMEDIATELY PRIOR TO REMOVING EARTHWORK EQUIPMENT FROM PROJECT SITE AND/OR BEGINNING LANDSCAPING ACTIVITIES. CONTRACTOR SHALL COORDINATE AND CONFIRM WITH THE SOILS ENGINEER THE SPECIFIC COMPACTION/TREATMENT SPECIFICATION REQUIREMENTS FOR THE BASIN BOTTOMS.

- 29. THE CONTRACTOR SHALL CONFIRM THAT ALL RETENTION AND/OR DETENTION BASINS ARE CONSTRUCTED IN ACCORDANCE WITH THE PLANS AND SHALL CONFIRM THE REQUIRED STORAGE VOLUMES PRIOR TO BEGINNING ANY LANDSCAPING ACTIVITIES WITHIN OR ADJACENT TO THE BASINS. IT IS STRONGLY RECOMMENDED THAT ALL RETENTION AND/OR DETENTION BASINS BE BLUE TOPPED FOR FINAL GRADE CONTROL. ALL BASINS SHALL BE AS-BUILT IN THEIR ENTIRETY BY A REGISTERED LAND SURVEYOR. SEALED AS-BUILT DRAWINGS SHALL BE SUBMITTED TO THE ENGINEER OF RECORD FOR VOLUME CONFIRMATION PRIOR TO BEGINNING ANY LANDSCAPING ACTIVITIES WITHIN OR ADJACENT TO THE BASINS.
- 30. REFER TO THE FINAL PLAT FOR THIS PROJECT FOR ADDITIONAL HORIZONTAL CONTROL AND RECORDING INFORMATION.
- 31. ALL REMAINING DISTURBED AREAS, EXCEPT RETENTION AND/OR DETENTION BASIN BOTTOMS, NOT OTHERWISE ALREADY TREATED, SHALL BE STABILIZED IN A FINAL MANNER IN CONFORMANCE WITH THE STORM WATER POLLUTION PREVENTION PLAN (SWPPP) PREPARED FOR THIS PROJECT. A NOTICE OF TERMINATION TO CLOSE OUT THE SWPPP'S NOTICE OF INTENT CANNOT BE FILED WITH ADEQ UNTIL THESE FINAL STABILIZATION MEASURES ARE IN PLACE.
- 32. PER SECTION 404 OF THE CLEAN WATER ACT, DREDGED OR FILL MATERIAL SHALL NOT BE PERMANENTLY OR TEMPORARILY PLACED IN ANY JURISDICTIONAL WATERS.
- HIS OBSERVATIONS AND COMPACTION TESTS DURING THE FILLING AND COMPACTING 33. WHERE A TRAIL OR OTHER WALKWAY FEATURE TIES INTO THE BACK OF A PEDESTRIAN RAMP, THE CONCRETE HEADER AT THAT RAMP SHALL BE REMOVED AND A SMOOTH TRANSITION BE MADE INTO THE RAMP SURFACE.
 - 34. IF UNANTICIPATED CONDITIONS ARE ENCOUNTERED DURING THE COURSE OF CONSTRUCTION AND ARE BEYOND THE SCOPE OF THE DESIGN, THE CONTRACTOR SHALL NOTIFY THE ENGINEER AND HE SHALL SUBMIT THE NECESSARY REVISED OR SUPPLEMENTAL IMPROVEMENT PLANS FOR REVIEW AND APPROVAL.
 - 35. UPON COMMENCEMENT OF WORK, TRAFFIC CONTROL DEVICES SHALL BE POSTED AND MAINTAINED BY THE CONTRACTOR UNTIL SUCH TIME AS THE WORK IS COMPLETED. ALL WARNING SIGNS, BARRICADES, ETC. SHALL BE IN ACCORDANCE WITH THE MANUAL ON UNIFORM TRAFFIC CONTROL DEVICES ADOPTED BY THE STATE OF ARIZONA PURSUANT TO A.R.S. 28-650.


						REVISION APPR DATE	
						DATE	
PAUL J. S. MO. BY NO. BY NO. BY							
	J-5141B		rickengineering.com Misno Phomix Domor		DATE: 12/21	DATE: 12/21	
	3945 EAST FORT LOWELL ROAD - SUITE 111	85712	rickengineering.com San Dioro Dioreido Orono Sarramato San Luic Obieno Phoneix Donuor	asue - Olange - Jaclantento - Jan Luis C	CHECKED BY: PJI	APPROVED BY: PJI	
	W 3945 EAST FO	TUCSON, AZ 85712 520-795-1000		Jail Diego - Nive	DATE: 12/21	RSM DATE: 12/21	
		RIC	ENGINEERING COMPANY Tuesod	I I I I I I I I I I I I I I I I I I I	DESIGNED BY: BNC	DRAWN BY: RSM	
DEVELOPMENT PACKAGE	THE RESERVE AT	VALENCIA CROSSING	LOTS 1-50 & COMMON	DRAINAGE, UTILITIES AND ACCESS), "B-1"-"B-2" (LANDSCAPE,	A PORTION OF THE EAST HALF OF SECTION 11, TOWNSHIP 15, SOUTH,	RANGE 14 EAST GILA & SALT RIVER MERIDIAN, PIMA COUNTY, ARIZONA	
F	P22 DP	2 A D 2 W S 2 2 -	00	00 X X	XX		
S A I	SHE	RT :	N// 0 OF	A	2	1:56	


RELATED CASES: C9-12-03, C15-12-01

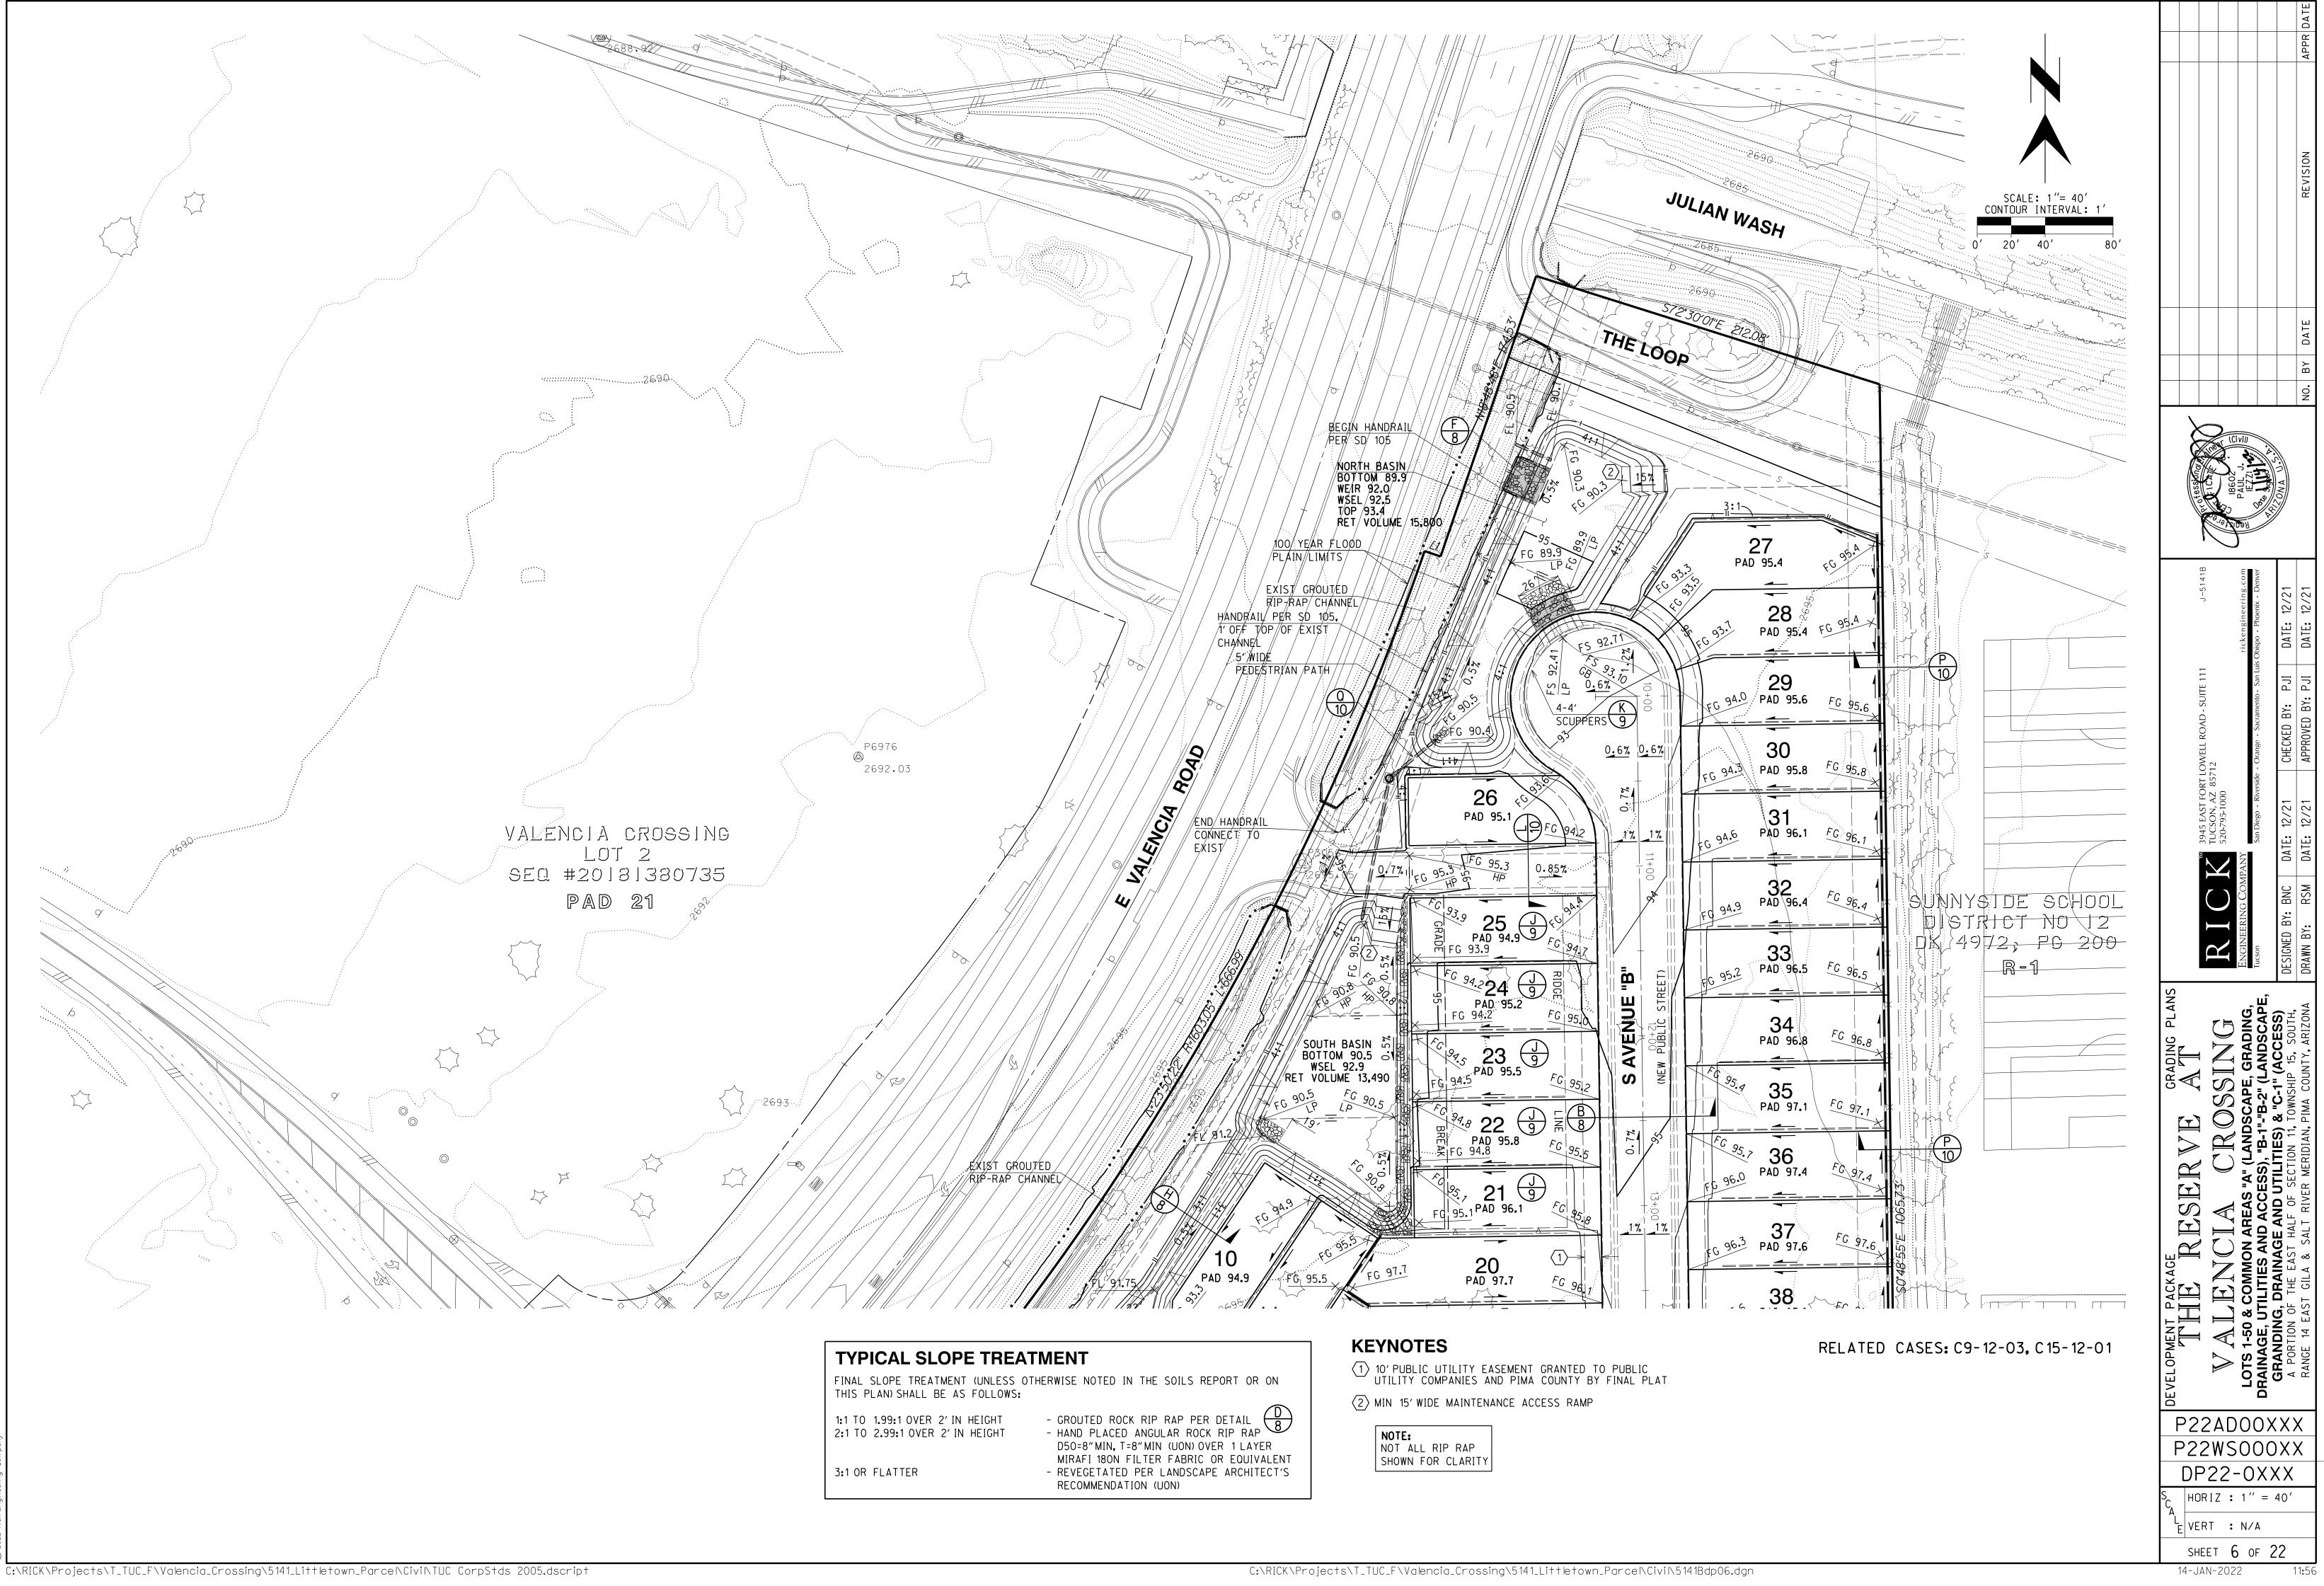


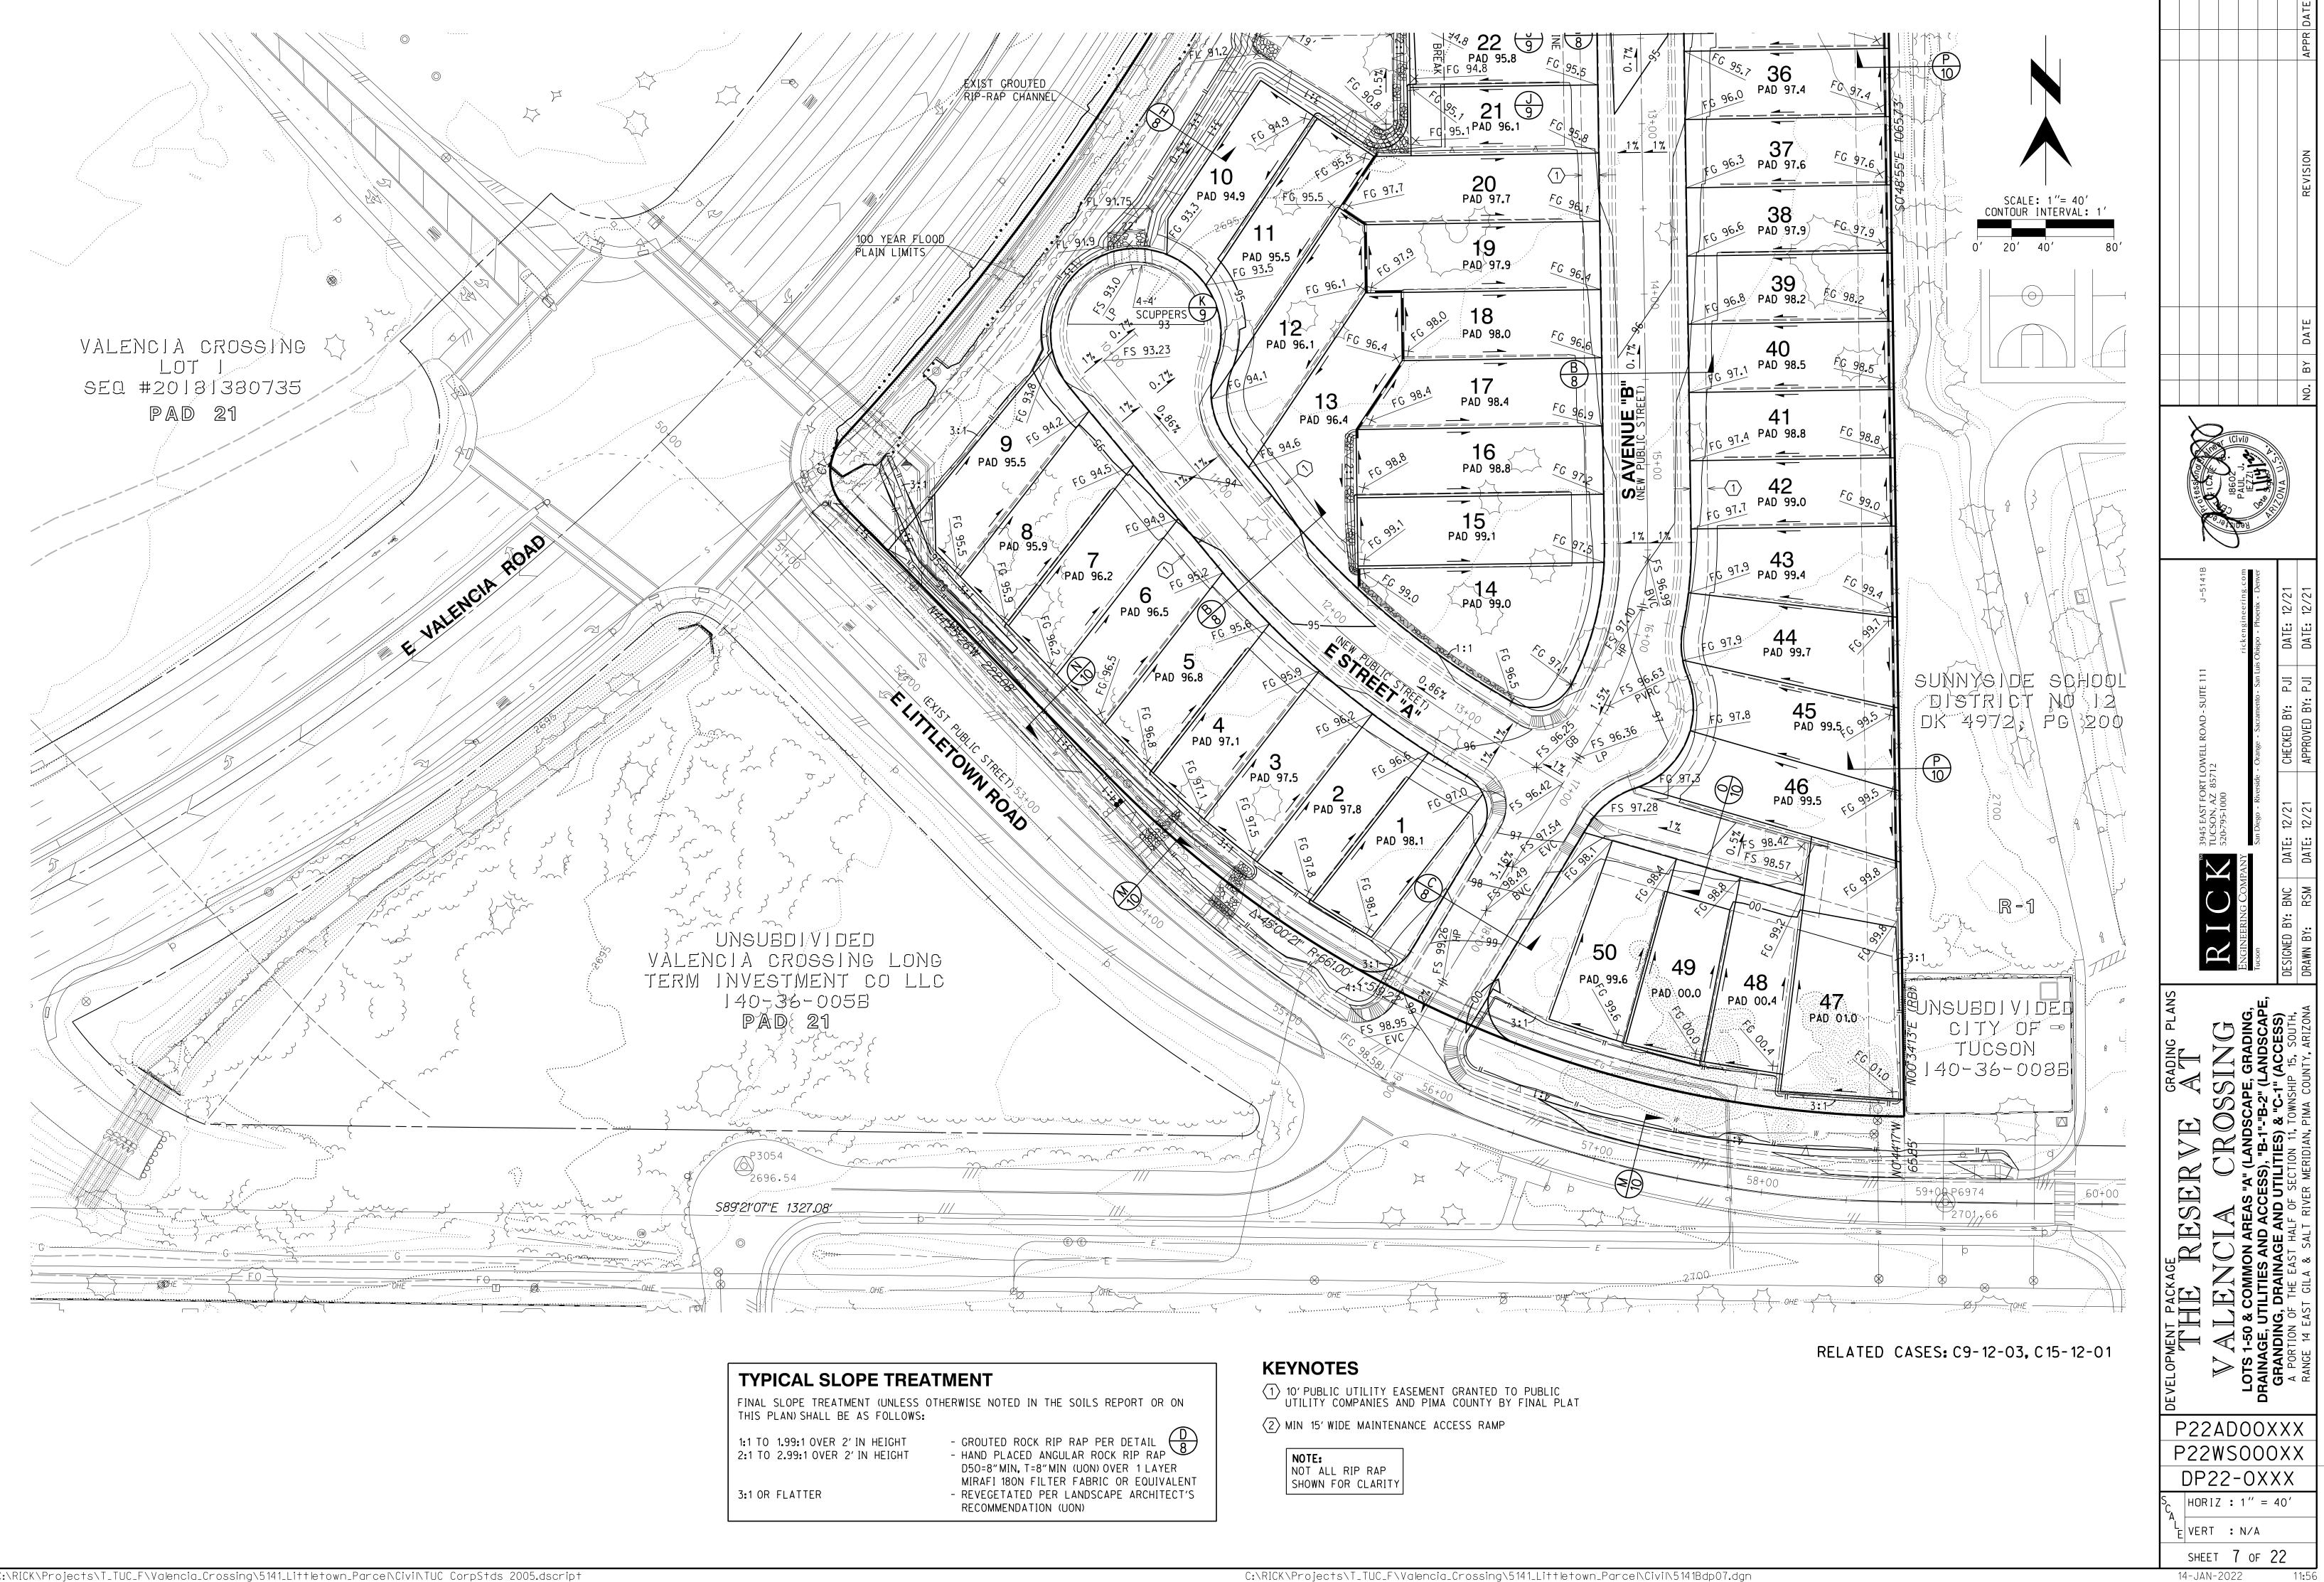




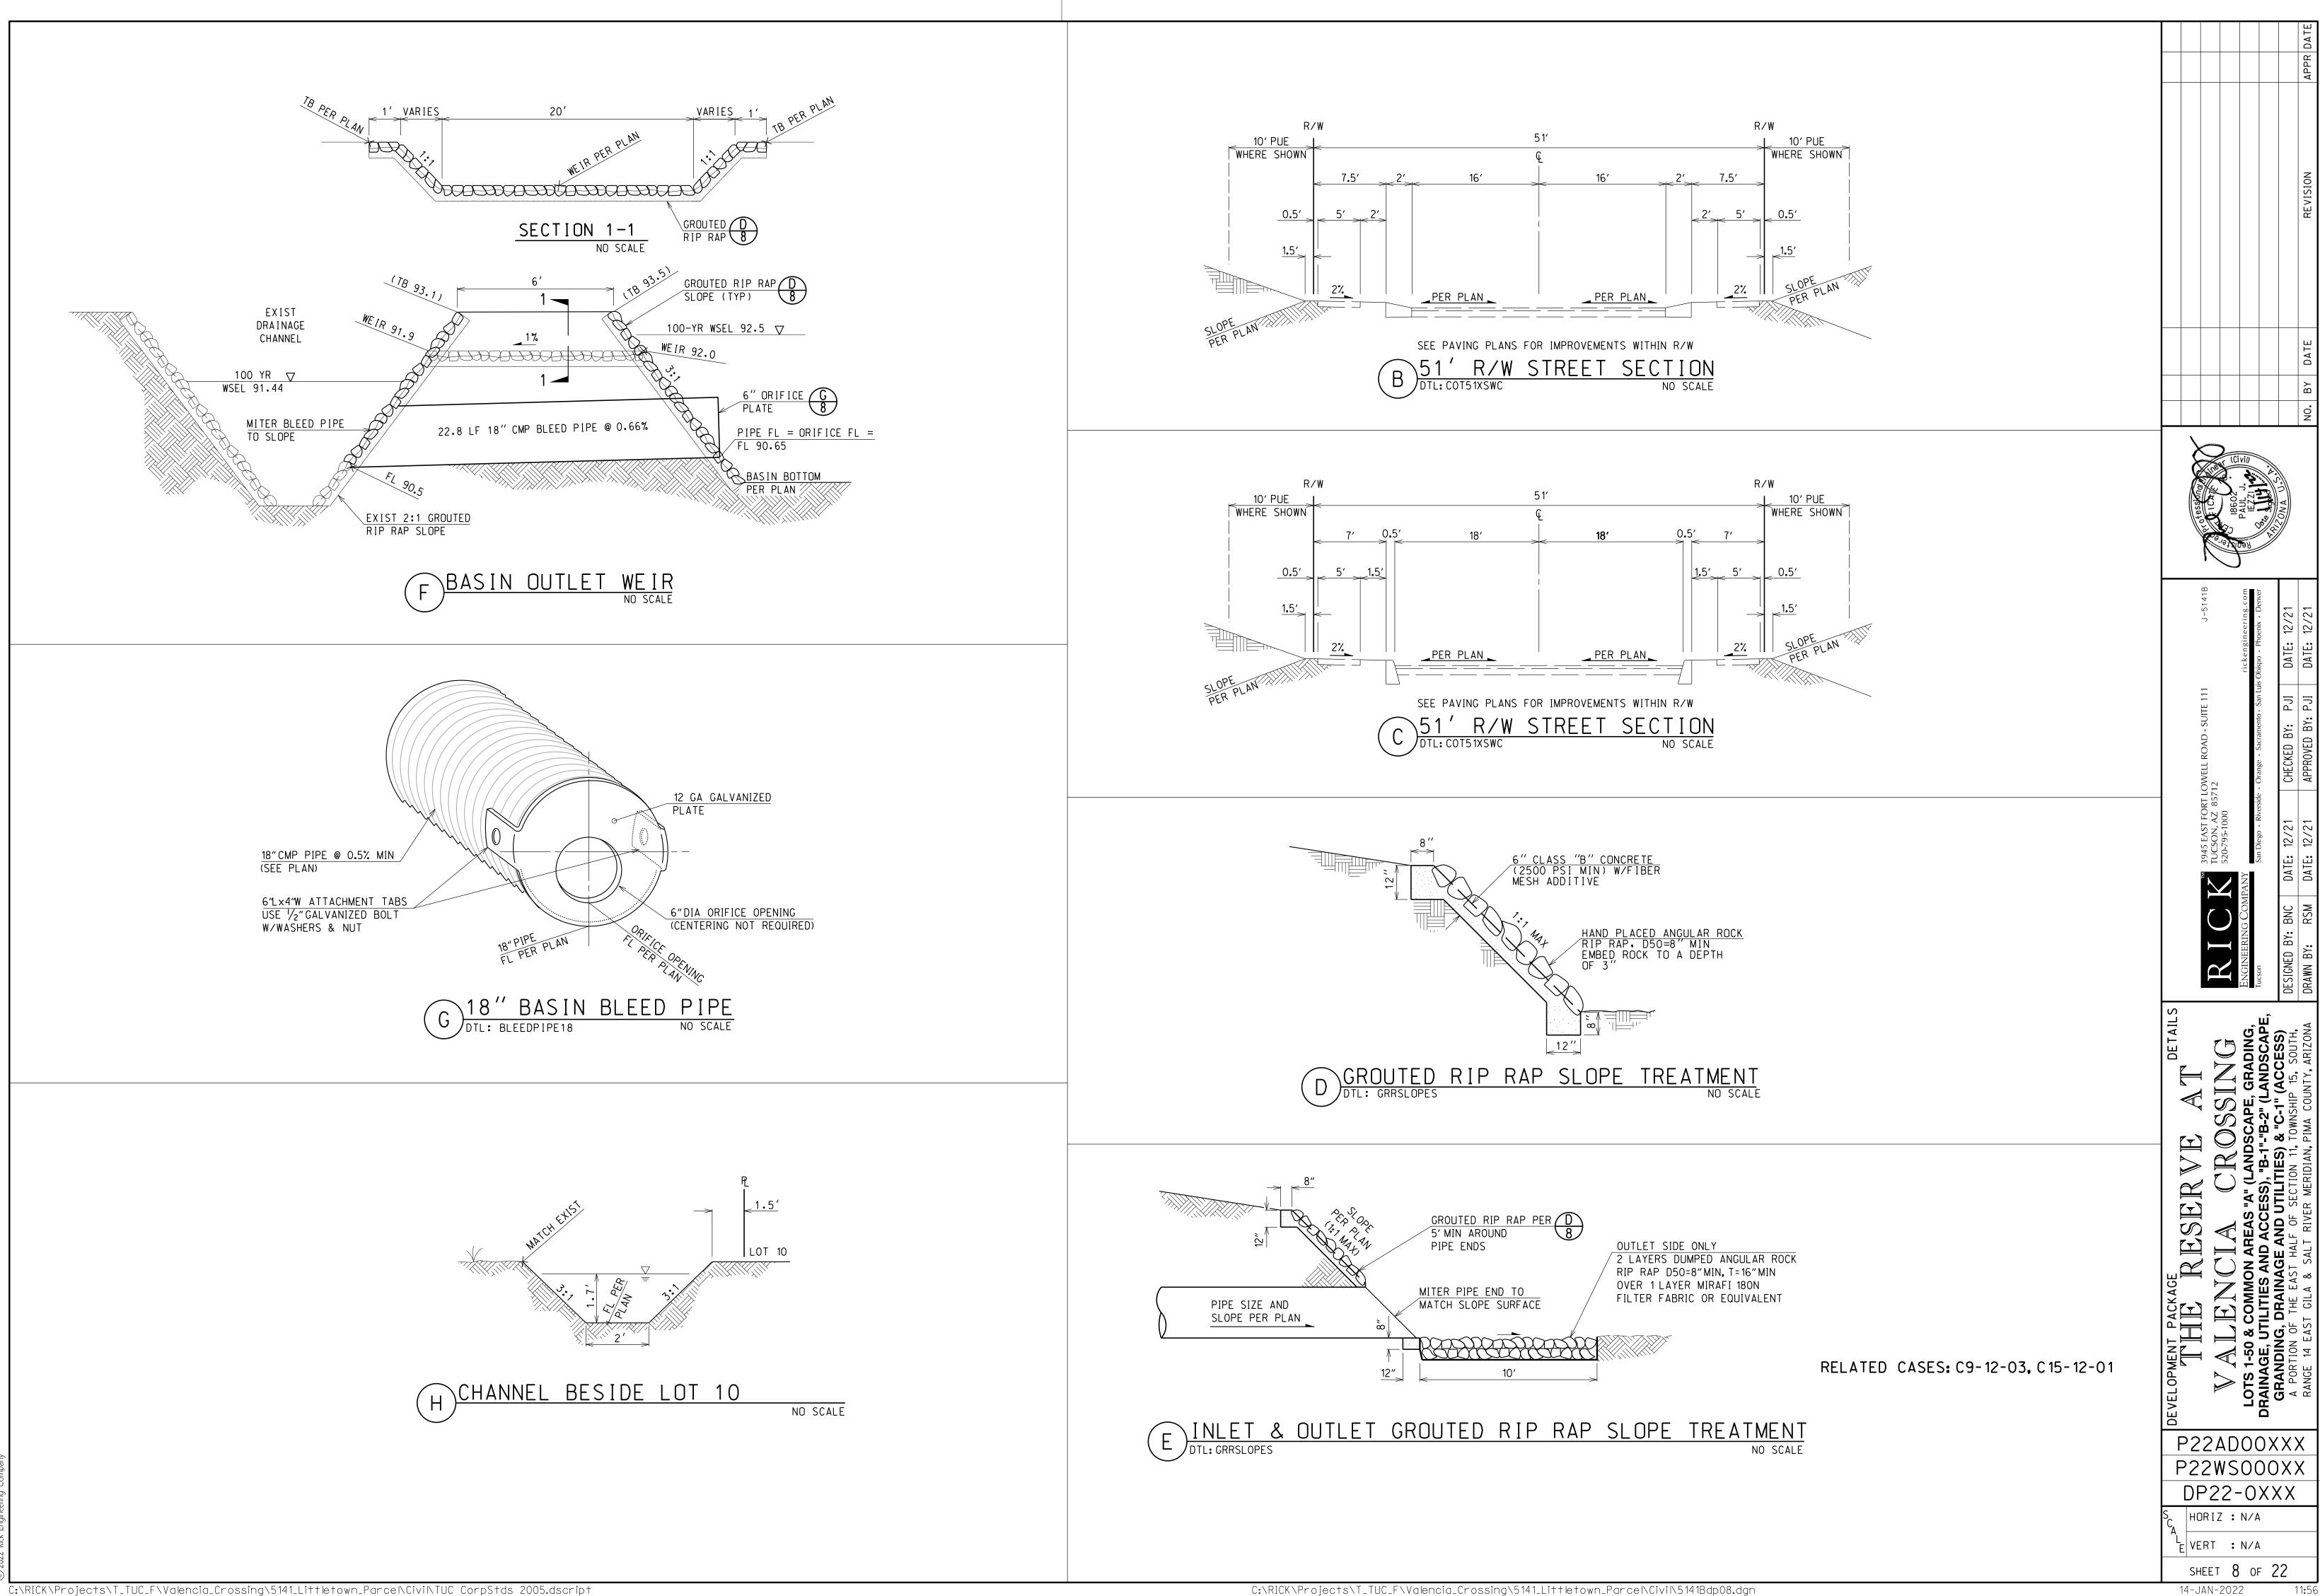


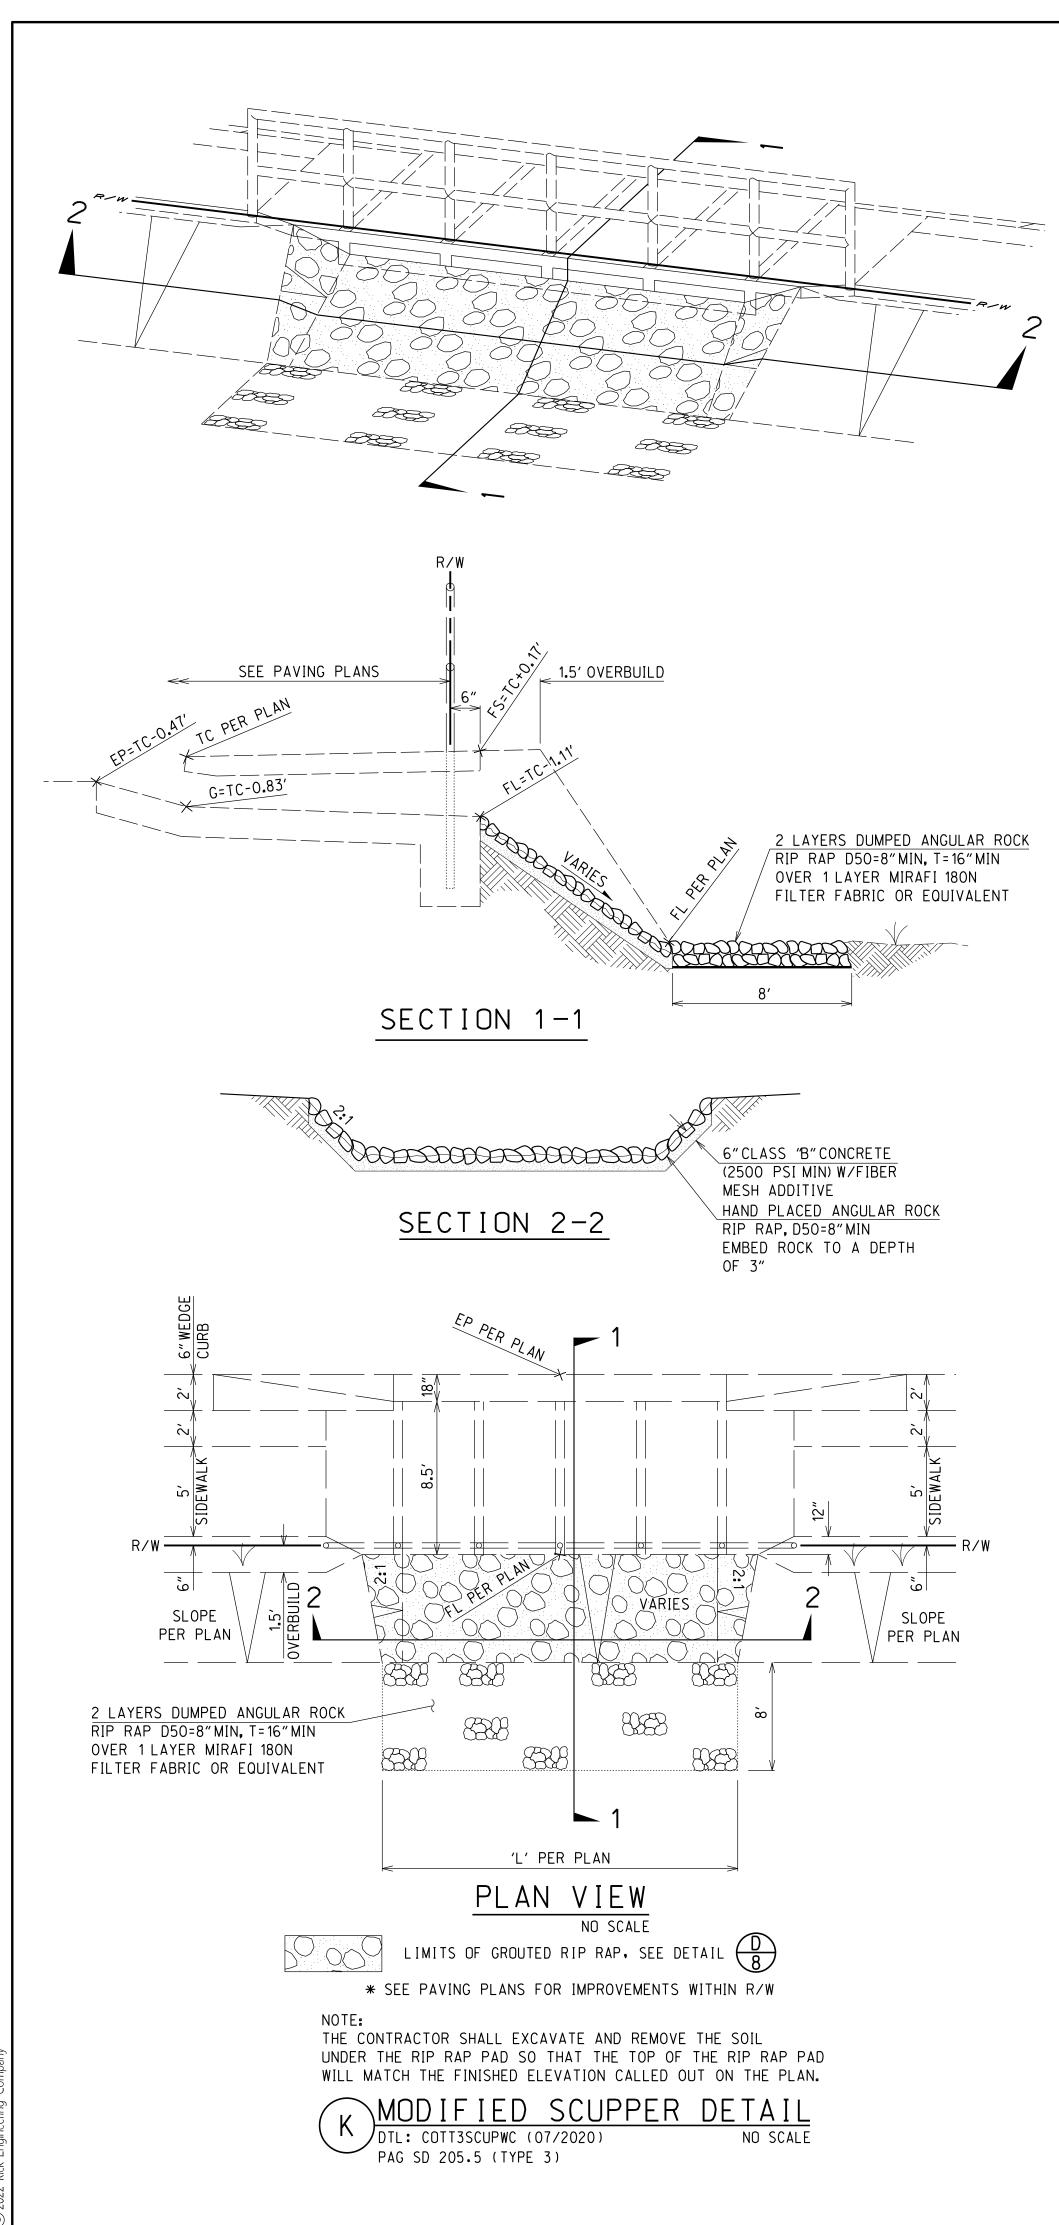

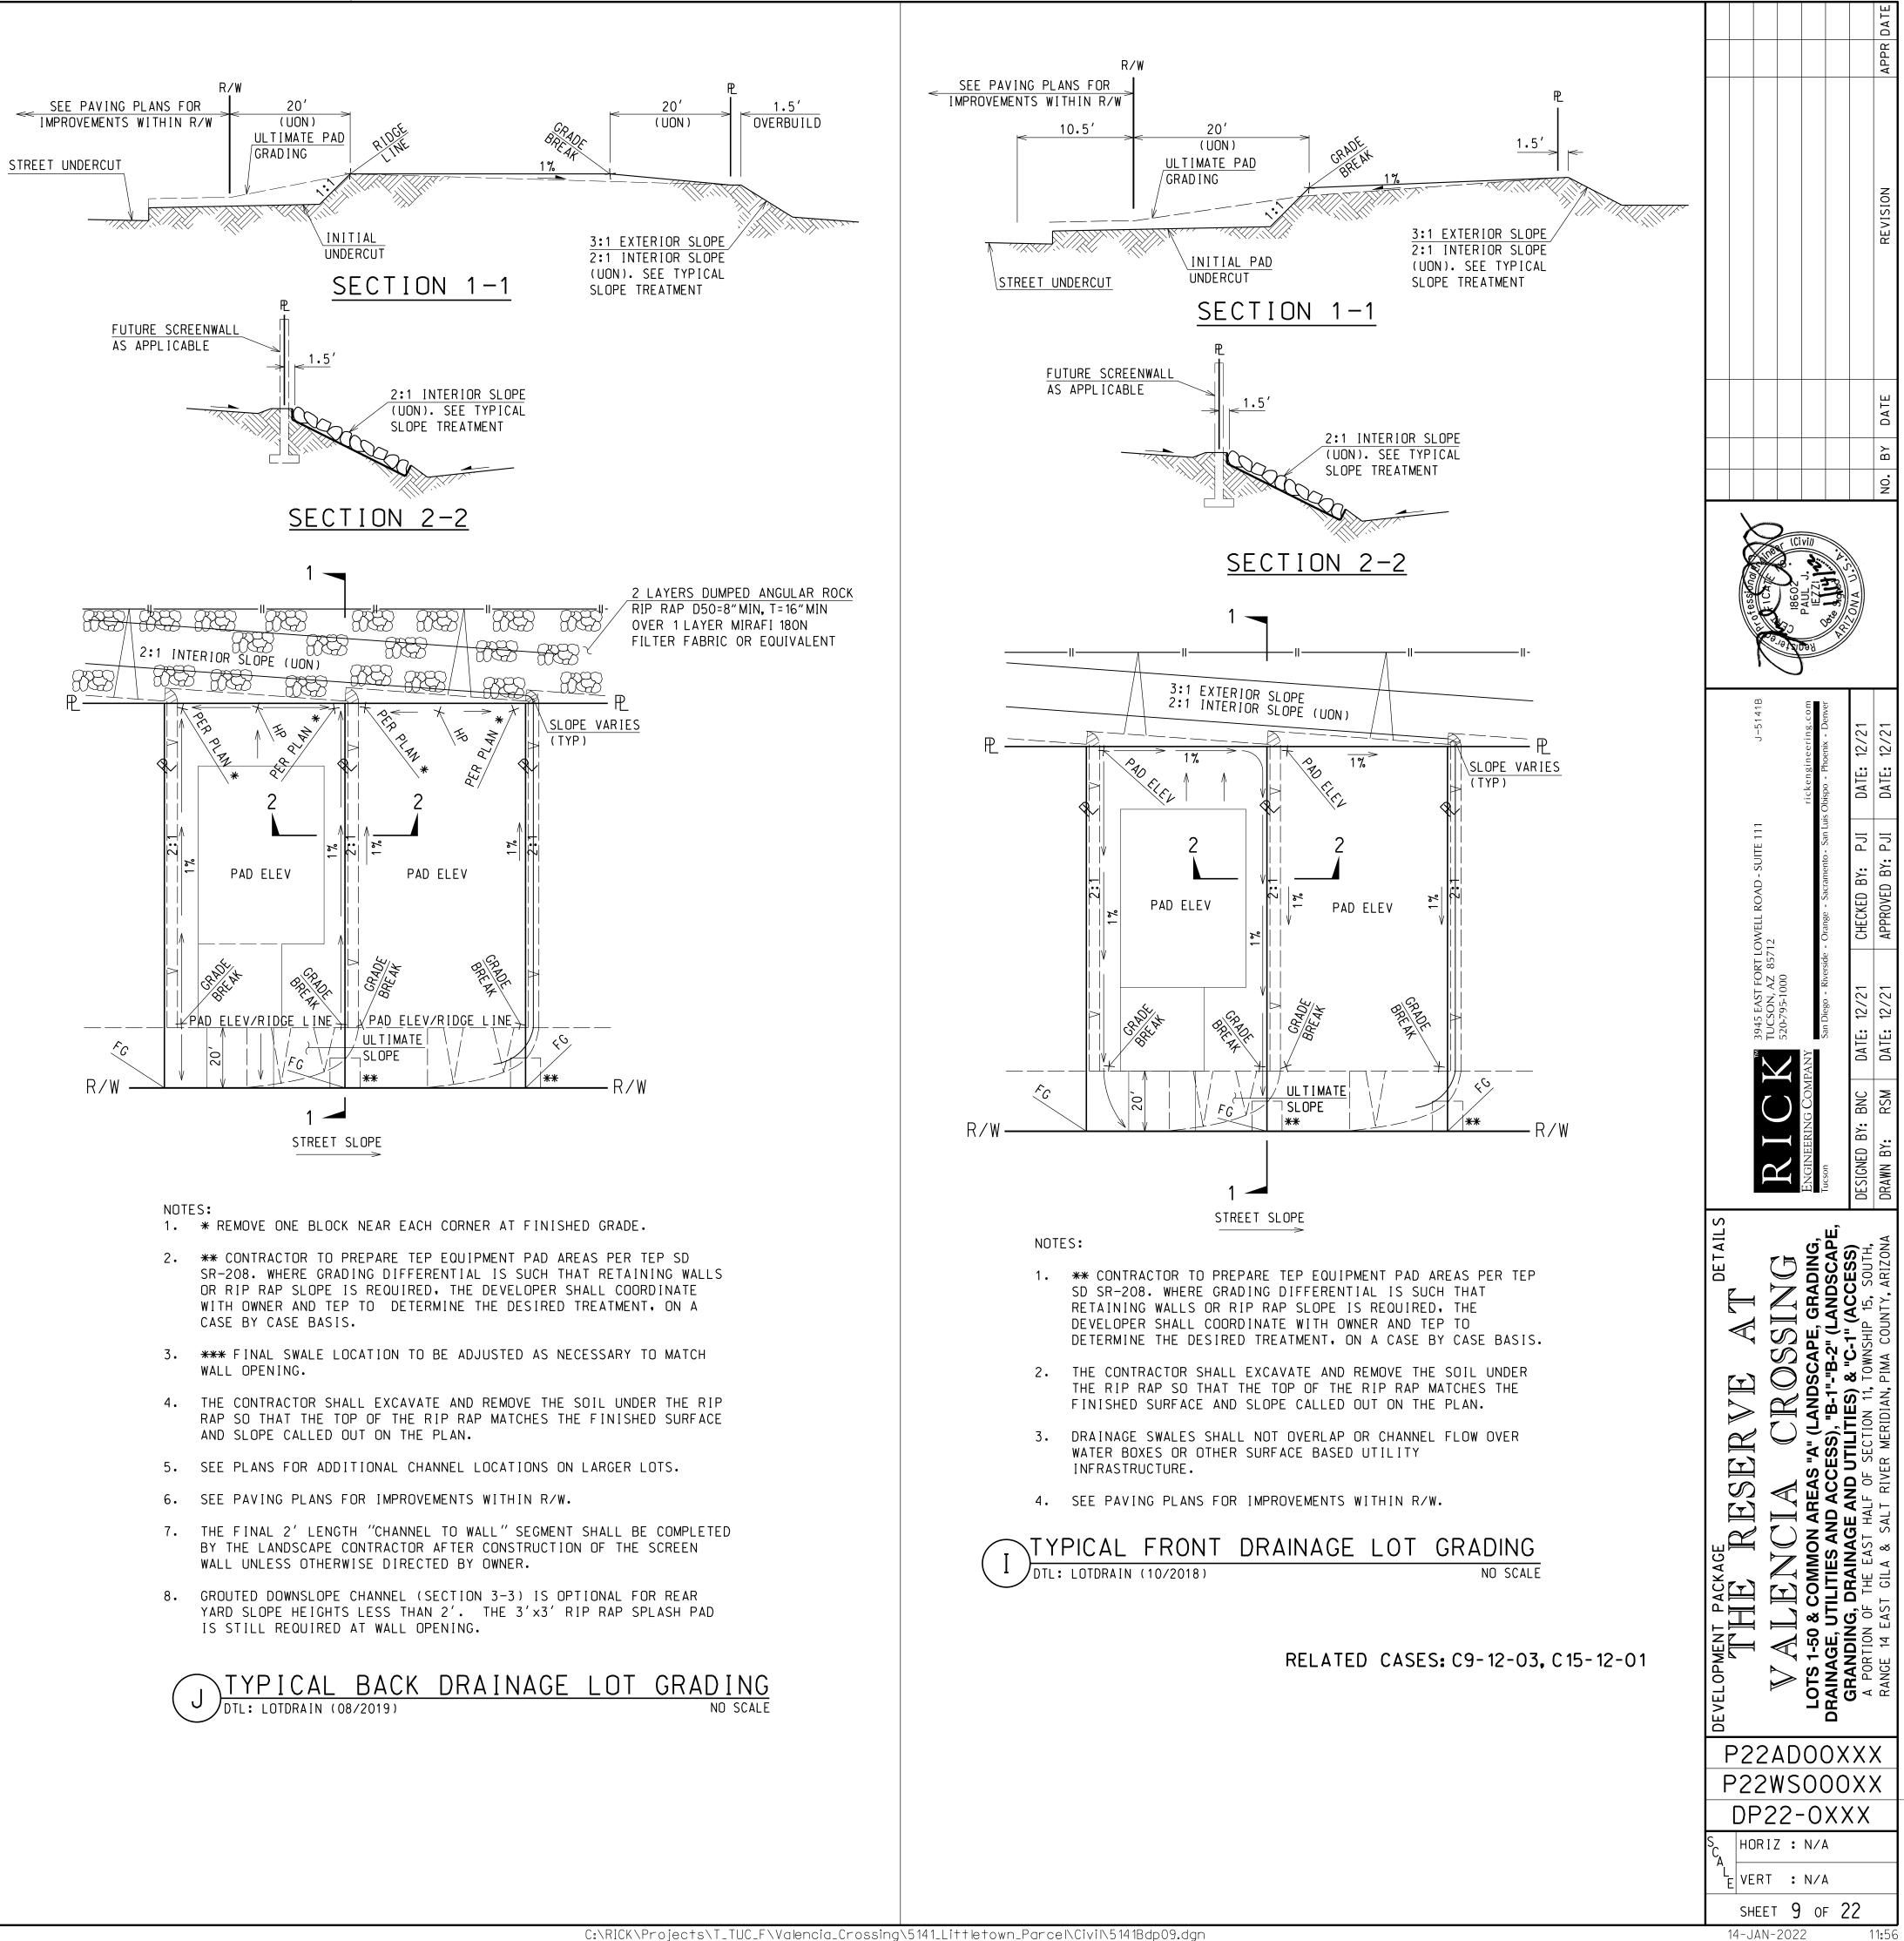

C:\RICK\Projects\T_TUC_F\Valencia_Crossing\5141_Littletown_Parcel\Civil\TUC_CorpStds_2005.dscript

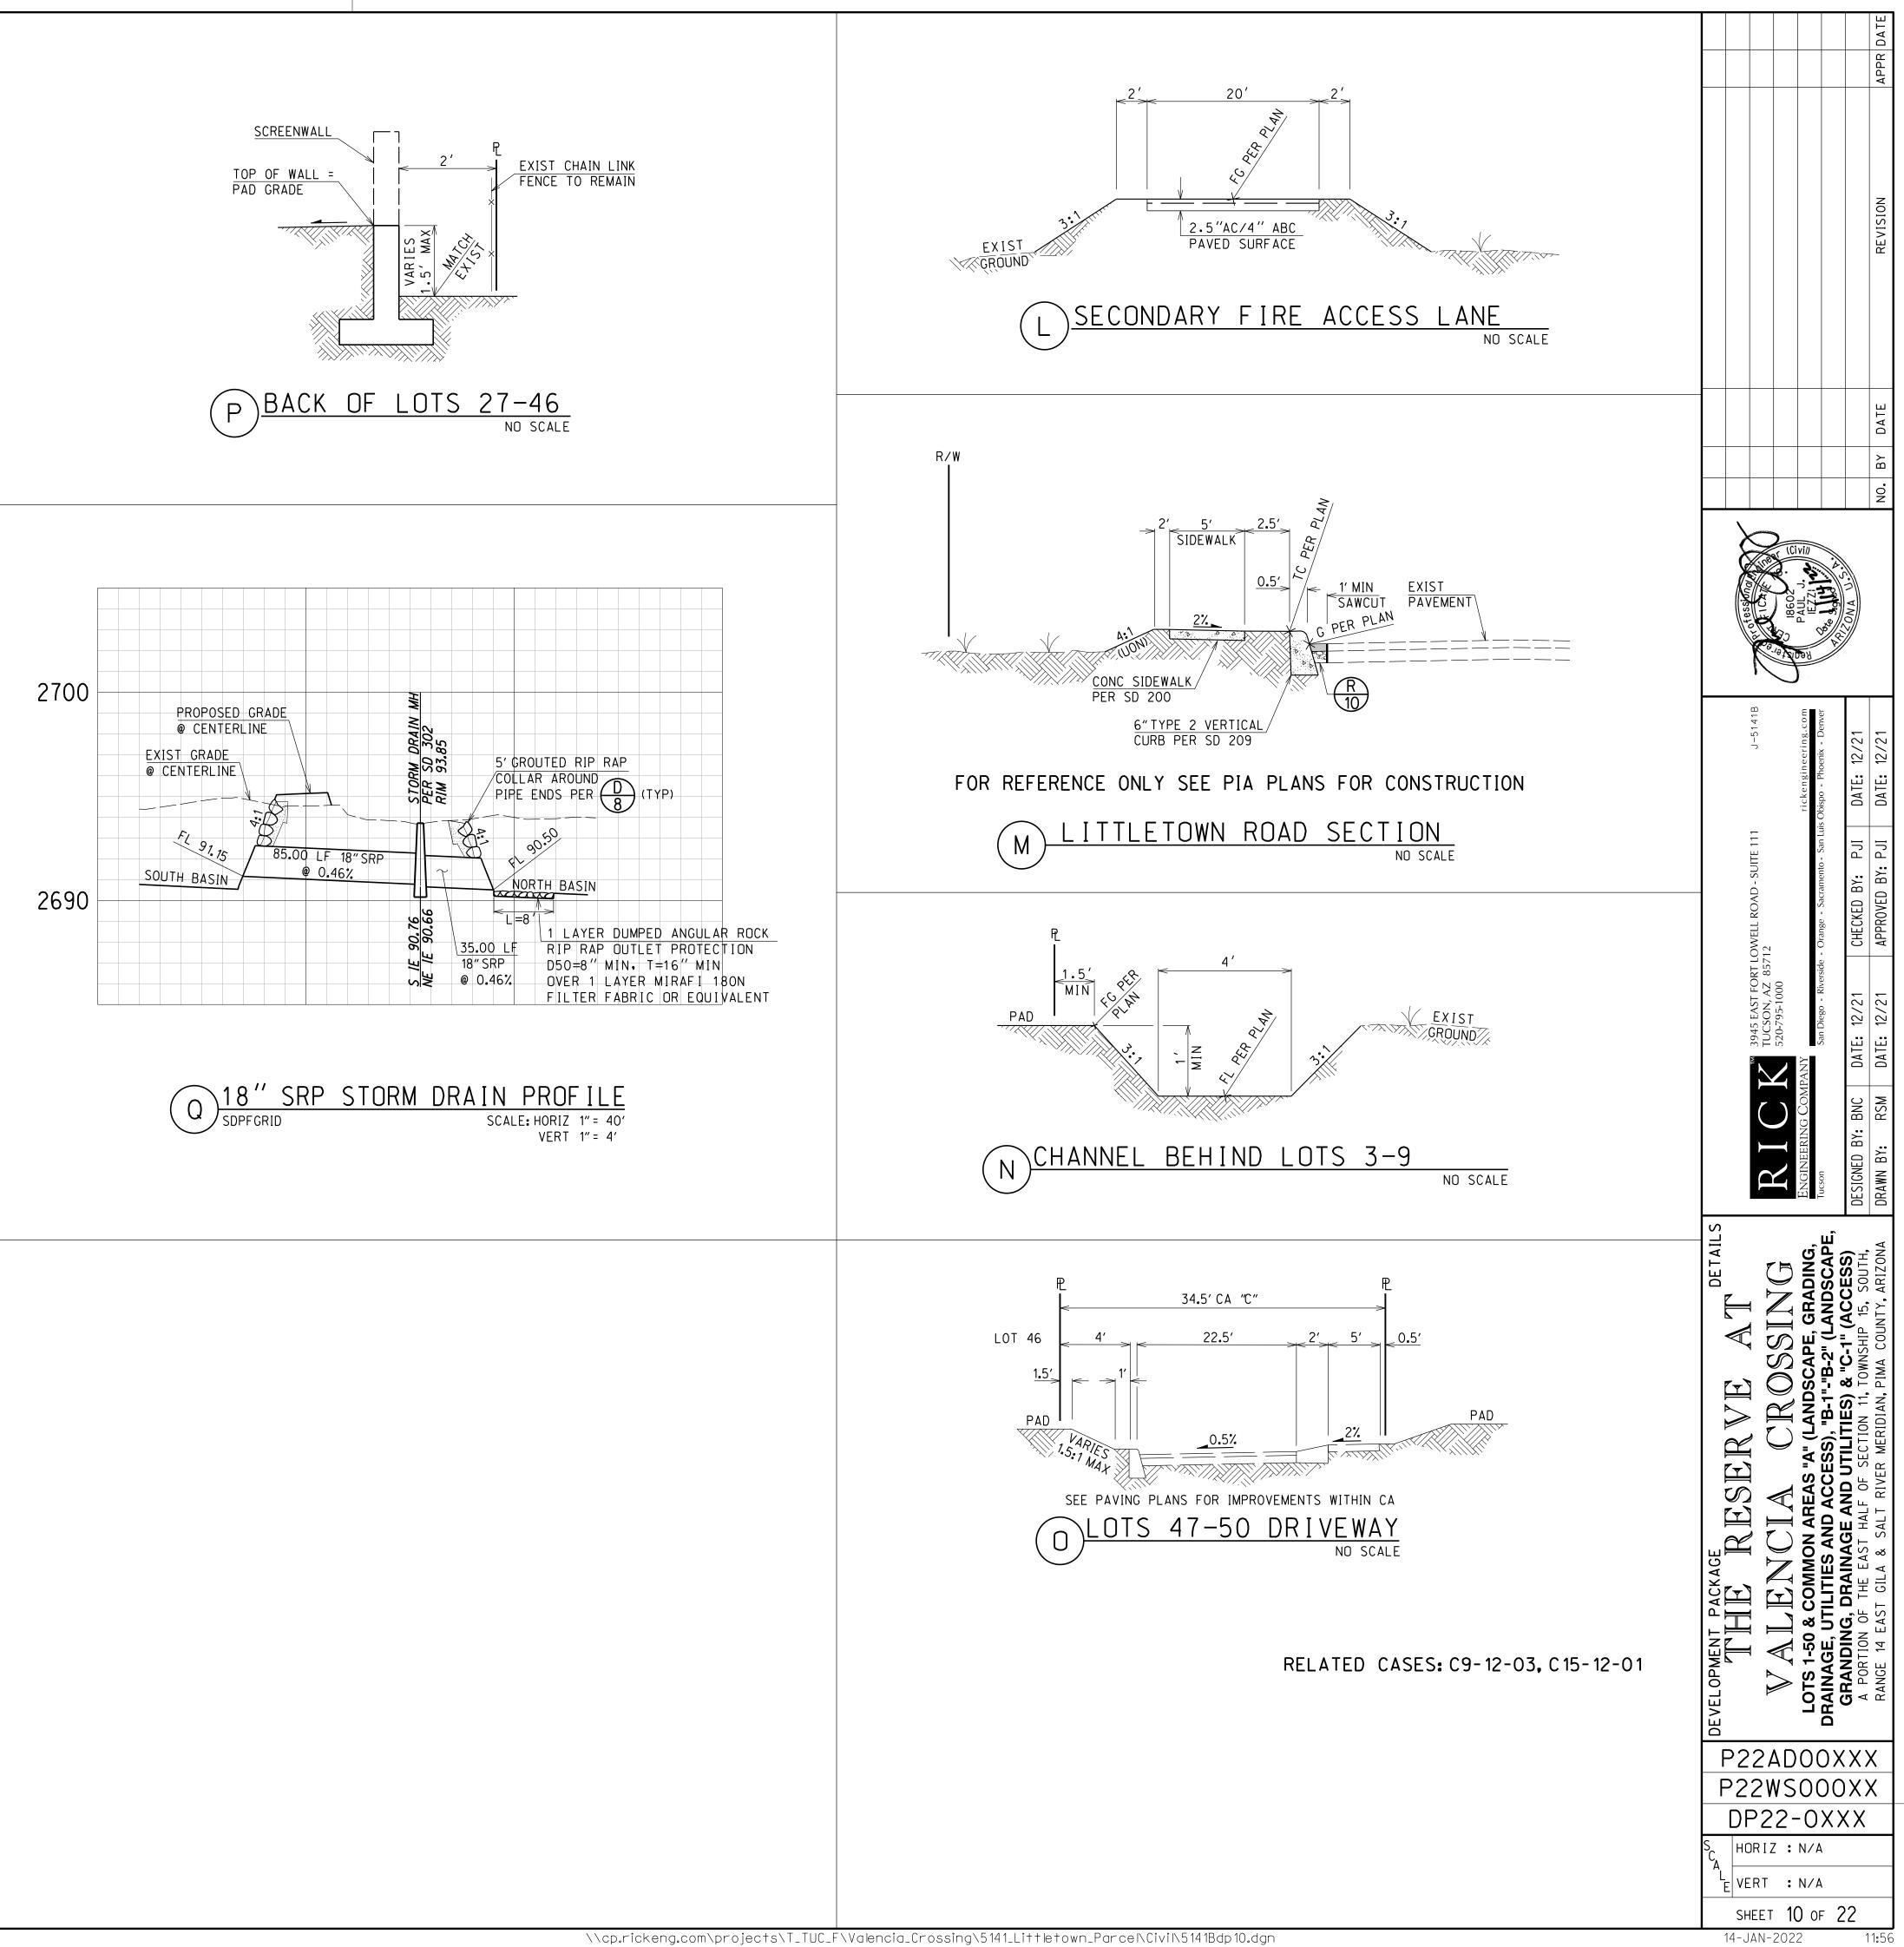

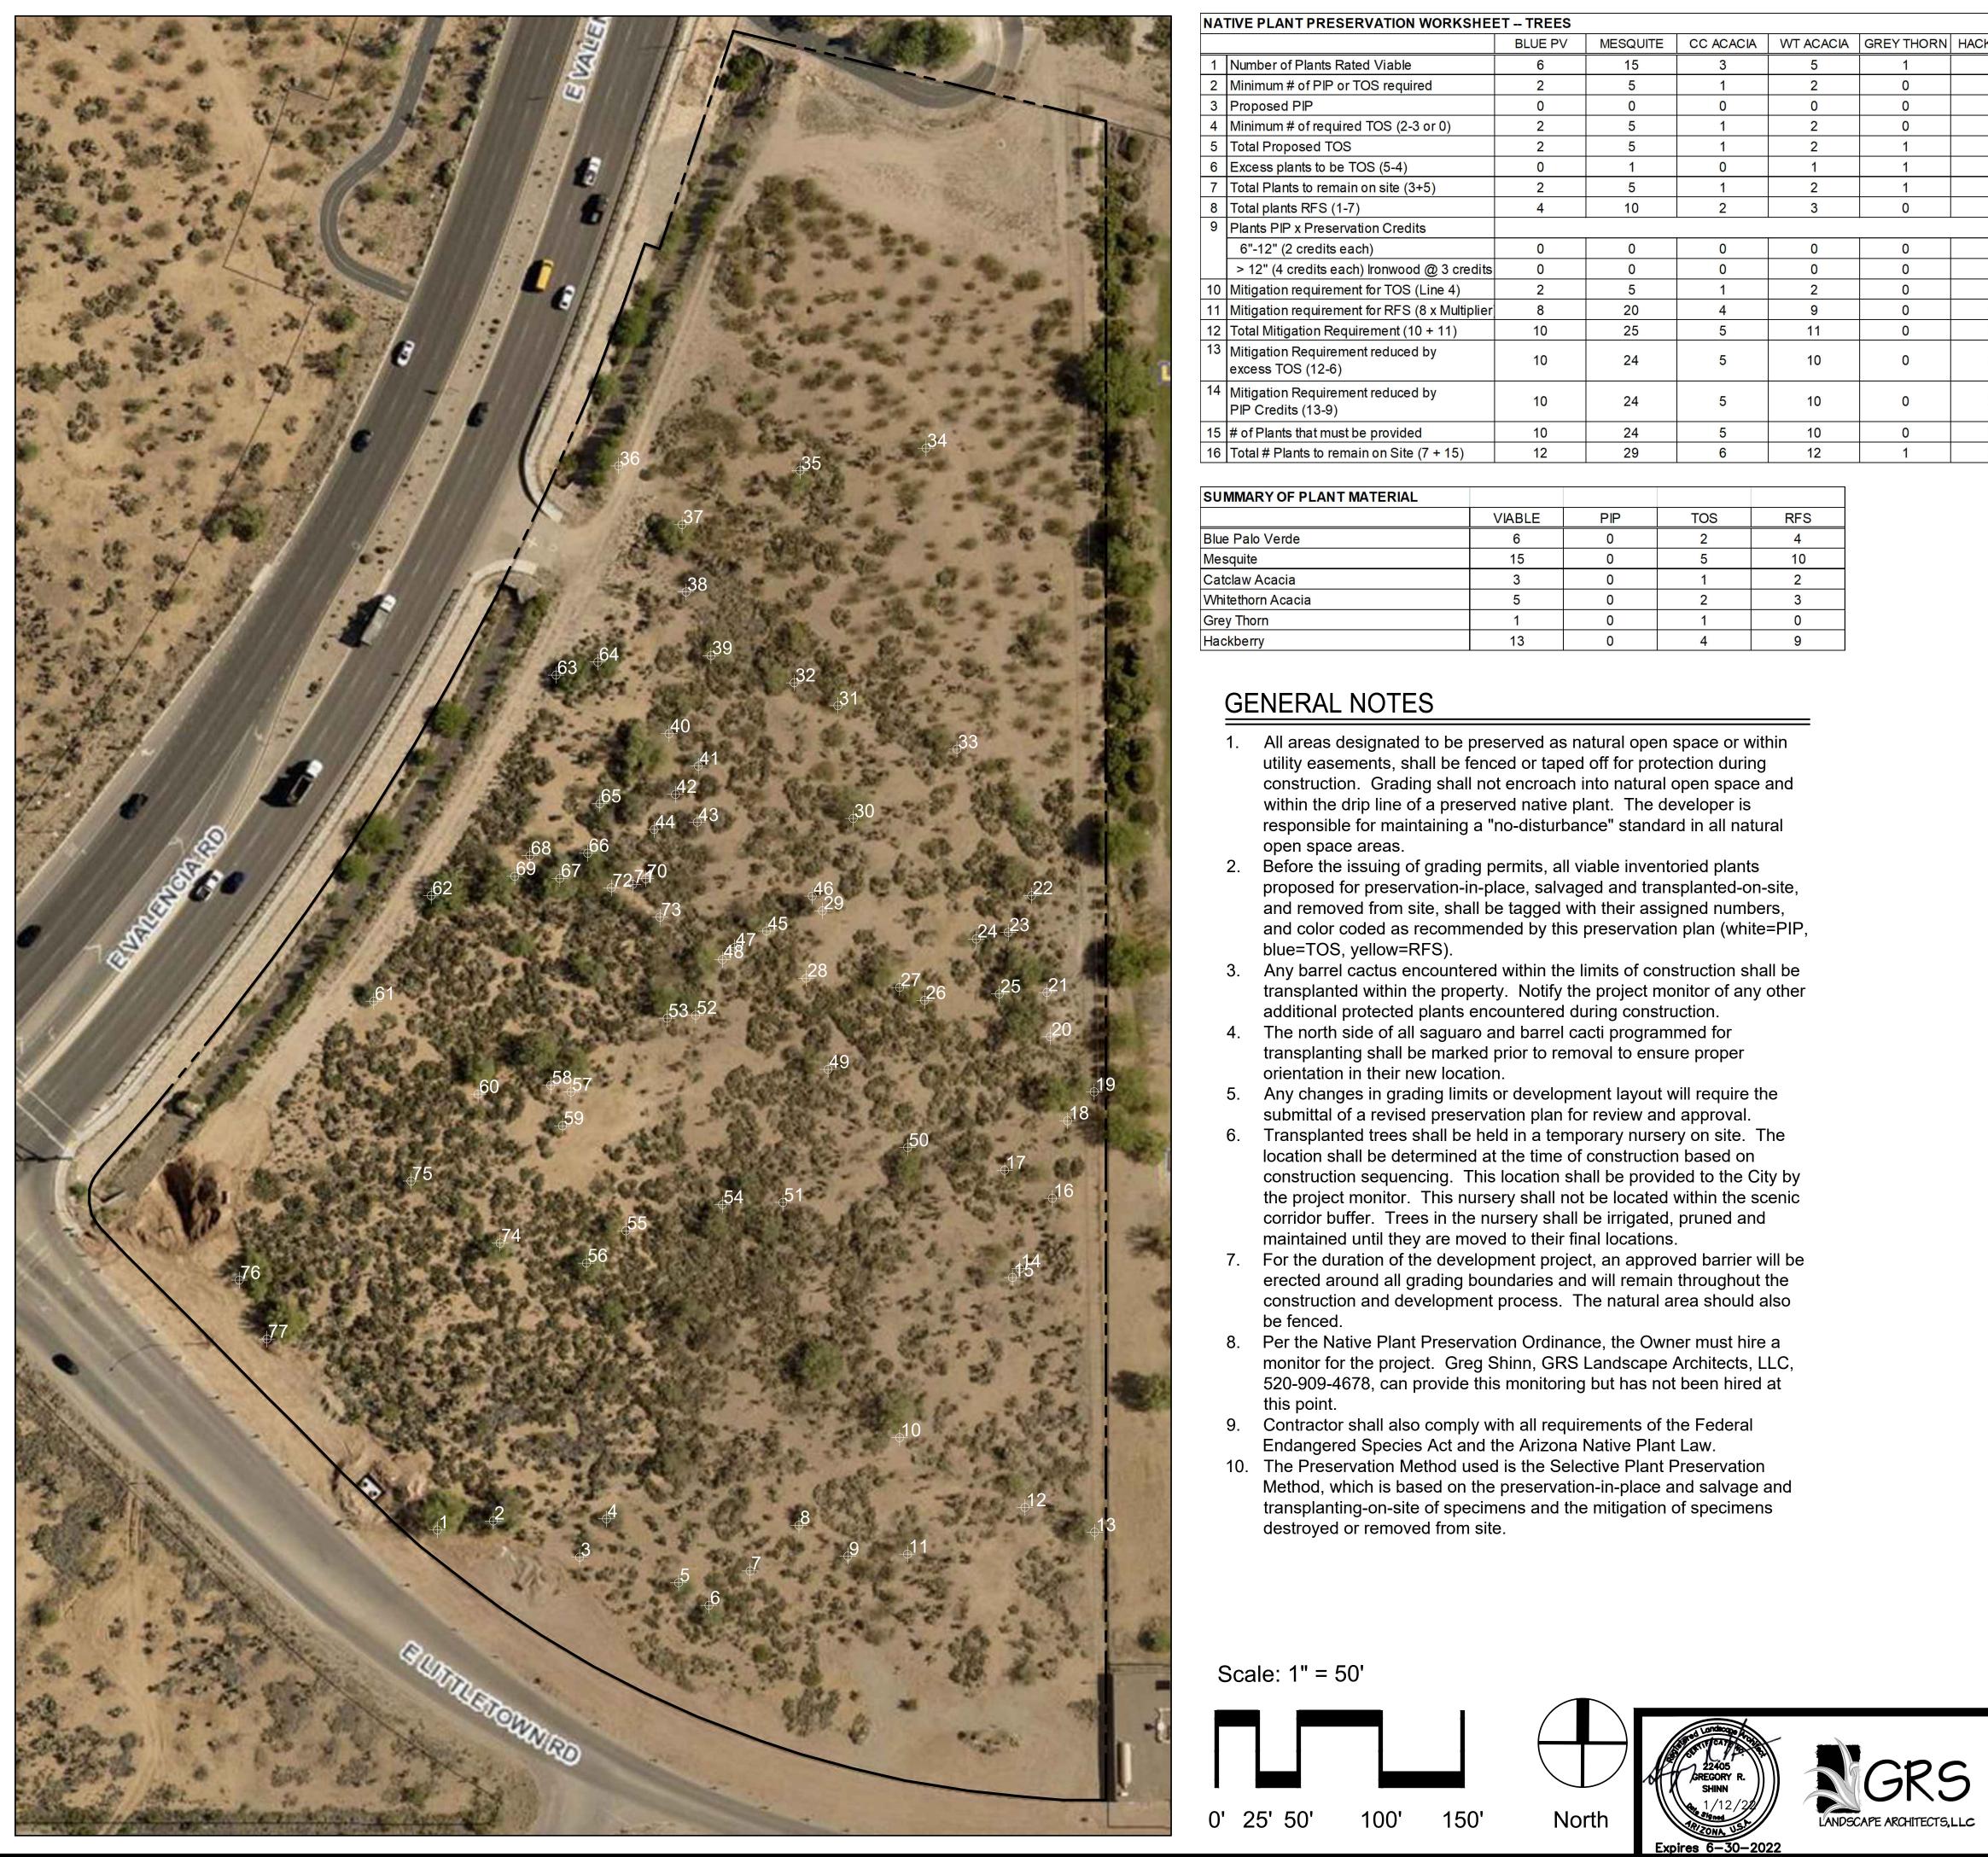

		BLUE PV	MESQUITE	CC ACACIA	WT ACACIA	GREY THORN
1	Number of Plants Rated Viable	6	15	3	5	1
2	Minimum # of PIP or TOS required	2	5	1	2	0
3	Proposed PIP	0	0	0	0	0
4	Minimum # of required TOS (2-3 or 0)	2	5	1	2	0
5	Total Proposed TOS	2	5	1	2	1
6	Excess plants to be TOS (5-4)	0	1	0	1	1
7	Total Plants to remain on site (3+5)	2	5	1	2	1
8	Total plants RFS (1-7)	4	10	2	3	0
9	Plants PIP x Preservation Credits					
	6"-12" (2 credits each)	0	0	0	0	0
	> 12" (4 credits each) lronwood @ 3 credits	0	0	0	0	0
10	Mitigation requirement for TOS (Line 4)	2	5	1	2	0
11	Mitigation requirement for RFS (8 x Multiplier	8	20	4	9	0
12	Total Mitigation Requirement (10 + 11)	10	25	5	11	0
13	Mitigation Requirement reduced by excess TOS (12-6)	10	24	5	10	0
14	Mitigation Requirement reduced by PIP Credits (13-9)	10	24	5	10	0
15	# of Plants that must be provided	10	24	5	10	0
16	Total # Plants to remain on Site (7 + 15)	12	29	6	12	1

	VIABLE	PIP	TOS	RFS
Blue Palo Verde	6	0	2	4
Mesquite	15	0	5	10
Catclaw Acacia	3	0	1	2
Whitethorn Acacia	5	0	2	3
Grey Thorn	1	0	1	0
Hackberry	13	0	4	9

		P	LANT	INVENTORY		VIABILITY	P	ECOMMEND	
N	HACKBERRY		ID NO.	DESCRIPTION	SIZE		RANSPLAN		COMMENTS
	13		1	Cercidium floridum - Blue Palo Verde	12+	L		NV	BL, DW, RT
	4		2	Cercidium floridum - Blue Palo Verde	12	L	L	NV	BL, DW, RT
+			3	Celtis pallida - Hackberry	8	H	M	RFS	MS, TM
_	0		4	Prosopis velutina - Native Mesquite	10	L	L	NV	RT, TM, DW
	4		5	Prosopis velutina - Native Mesquite	10	L	L	NV	RT, , DW
	4		6	Cercidium floridum - Blue Palo Verde	12	L	L	NV	RT, DW
	0		7	Prosopis velutina - Native Mesquite	4	L	L	NV	RT, DW
+			8	Celtis pallida - Hackberry	8	M	M	RFS	TM, MS,
\dashv	4		9	Celtis pallida - Hackberry	6	L	L	NV	RD
	9	_	10	Prosopis velutina - Native Mesquite	12+	M	L	RFS	SZ
			11	Prosopis velutina - Native Mesquite	12+	L	L	NV	DW, RT
	0		<u>12</u> 13	Prosopis velutina - Native Mesquite	10 12		L	NV	DW, RT, LB
+		-	13	Cercidium floridum - Blue Palo Verde Prosopis velutina - Native Mesquite	12		L.	NV NV	<u>DW, RT, </u> DW, IN
_	0	_	15	Prosopis velutina - Native Mesquite	10		<u> </u>	NV	DW, IN, LE
	4		16	Prosopis velutina - Native Mesquite	8			NV	
	18		17	Celtis pallida - Hackberry	8	M	M	TOS	TM, MS
1	22		18	Prosopis velutina - Native Mesquite	12+	M	L	RFS	DW, SZ
+	22		19	Prosopis velutina - Native Mesquite	4	M	M	TOS	MS
	22		20	Prosopis velutina - Native Mesquite	12+	L	L	NV	DW, LB
			21	Prosopis velutina - Native Mesquite	12+	M	L	RFS	DW, LB
T			22	Prosopis velutina - Native Mesquite	12+	М	L	RFS	SZ
	22		23	Celtis pallida - Hackberry	6	М	М	RFS	DW, MS
+			24	Prosopis velutina - Native Mesquite	8	L	L	NV	RT, ST
	22		25	Prosopis velutina - Native Mesquite	12+	L	L	NV	RT, IN, DW
	26		26	Acacia greggii - Catclaw Acacia	10	M	M	RFS	MS, LB, DW
			27	Prosopis velutina - Native Mesquite	12	M	L	RFS	SZ, LB, DW
		\vdash	28	Cercidium floridum - Blue Palo Verde	4	M	M	TOS	MS, LB,
		-	<u>29</u> 30	Celtis pallida - Hackberry Prosopis velutina - Native Mesquite	8 12+	M M	M	RFS RFS	<u>MS, TM</u> SZ, LB
			31	Cercidium floridum - Blue Palo Verde	8	M	M	TOS	LE, VMS
		-	32	Prosopis velutina - Native Mesquite	10			NV	DW, IN
			33	Prosopis velutina - Native Mesquite	10	M		TOS	DW, LB
		-	34	Prosopis velutina - Native Mesquite	12			NV	DW, IN, RT
			35	Prosopis velutina - Native Mesquite	10	L	L	NV	DW, IN, RT
			36	Prosopis velutina - Native Mesquite	10	H	 L	RFS	SZ,
			37	Prosopis velutina - Native Mesquite	10	H	L	TOS	SZ, TM
			38	Celtis pallida - Hackberry	10	М	L	RFS	SZ, TM
			39	Prosopis velutina - Native Mesquite	12+	L	L	NV	RT, DW
			40	Prosopis velutina - Native Mesquite	18+	L	L	NV	BL, DW, RT
			41	Zizyphus obtusifolia - Gray Thorn	10	H	Н	TOS	PS,
			42	Celtis pallida - Hackberry	8	M	L	RFS	TM
			43	Celtis pallida - Hackberry	8	М	M	RFS	TM, VMS
			44	Celtis pallida - Hackberry	12	M	L	RFS	SZ, TM
		_	45	Cercidium floridum - Blue Palo Verde	12+	L	L	NV	RT
			46	Celtis pallida - Hackberry	8	M	M	TOS	
			47 48	Acacia constricta - White ThornAcacia	8	M	<u> </u>	NV RFS	TM, RT
			40	Cercidium floridum - Blue Palo Verde Prosopis velutina - Native Mesquite	0 12+		<u> </u>	NV	LB, DW IN, DW, RT
		⊢	<u>49</u> 50	Prosopis velutina - Native Mesquite	12+		L 	NV	IN, DW, RT
		\vdash	51	Prosopis velutina - Native Mesquite	10			NV	IN, DW, RT
		F	52	Prosopis velutina - Native Mesquite	12	M	L	TOS	LB, DW
			53	Prosopis velutina - Native Mesquite	10	L	L	NV	DY
			54	Prosopis velutina - Native Mesquite	12+	L	L	NV	DW, LB
			55	Prosopis velutina - Native Mesquite	8	L	L	NV	DW, LB, RT
			56	Prosopis velutina - Native Mesquite	8	L	L	NV	DY
			57	Prosopis velutina - Native Mesquite	10	L	L	NV	DY
			58	Prosopis velutina - Native Mesquite	12+	M	L	RFS	SZ
			59	Acacia greggii - Catclaw Acacia	8	M	M	TOS	VMS, LB
		\vdash	60	Cercidium floridum - Blue Palo Verde	10	M	L	RFS	SZ, LB
			61	Celtis pallida - Hackberry	8	M	M	TOS	VMS, TM
		\vdash	62 63	Prosopis velutina - Native Mesquite	12+	M	L .	RFS	SZ, LB
		\vdash	63 64	Prosopis velutina - Native Mesquite Prosopis velutina - Native Mesquite	<u>12+</u> 12	M	L	RFS NV	SZ, LB DW, LB, RD
		\vdash	65	Acacia constricta - White ThornAcacia	6	M	L 	RFS	DW, LB, RD DW, LB, TM
		\vdash		Acacia constricta - White ThornAcacia	6	M	M	TOS	VMS, DW
		\vdash	67	Cercidium floridum - Blue Palo Verde	10	M		RFS	LB, DW
		⊢	68	Acacia constricta - White ThornAcacia	8	M	M	TOS	VMS, TM
			69	Prosopis velutina - Native Mesquite	12	L	L	NV	DW, RT
			70	Celtis pallida - Hackberry	8	M	M	TOS	MS
			71	Acacia constricta - White ThornAcacia	8	M	L	RFS	TM
			72	Acacia constricta - White ThornAcacia	8	M	L	RFS	LB, SZ
			73	Celtis pallida - Hackberry	8	М	M	RFS	VMS, SZ
			74	Prosopis velutina - Native Mesquite	10	M	M	TOS	DW, VMS
				Acacia greggii - Catclaw Acacia	8	М	L	RFS	DŴ, LB
			76	Cercidium floridum - Blue Palo Verde	12+	L	L	NV	DW, BL
			77	Cercidium floridum - Blue Palo Verde	12+	M		RFS	SZ

DP22-xxx

NATIVE PLANT PRESERVATION PLAN The Reserve at Valencia Crossing

Lots 1-50 & Common Areas "A-1"-"A-X" (Landscape, Grading, Drainage and Utilities), "B-1"-B-X" (Recreation, Landscape, Grading, Drainage and

Utilities) & "C-1" (Drainage)


A Portion of the East Half of Section 11, T-15-S, R-14-E, G&SRM, Tucson, Pima Co, AZ

35974 S. Desert Sun Drive Tucson, AZ 85739 (520) 909-4678 gregs@grslandscapearchitects.com

Design 1/12/22 🗆 Constru KVP/LMW 🖾 Agency Drawn by: Checked by:

	🗆 Design Review	
2/22	Construction Documents	
/LMW	🛛 Agency Submittal	
	Construction Set	
GRS	🛛 Not for Construction	

N-1 11of*22*

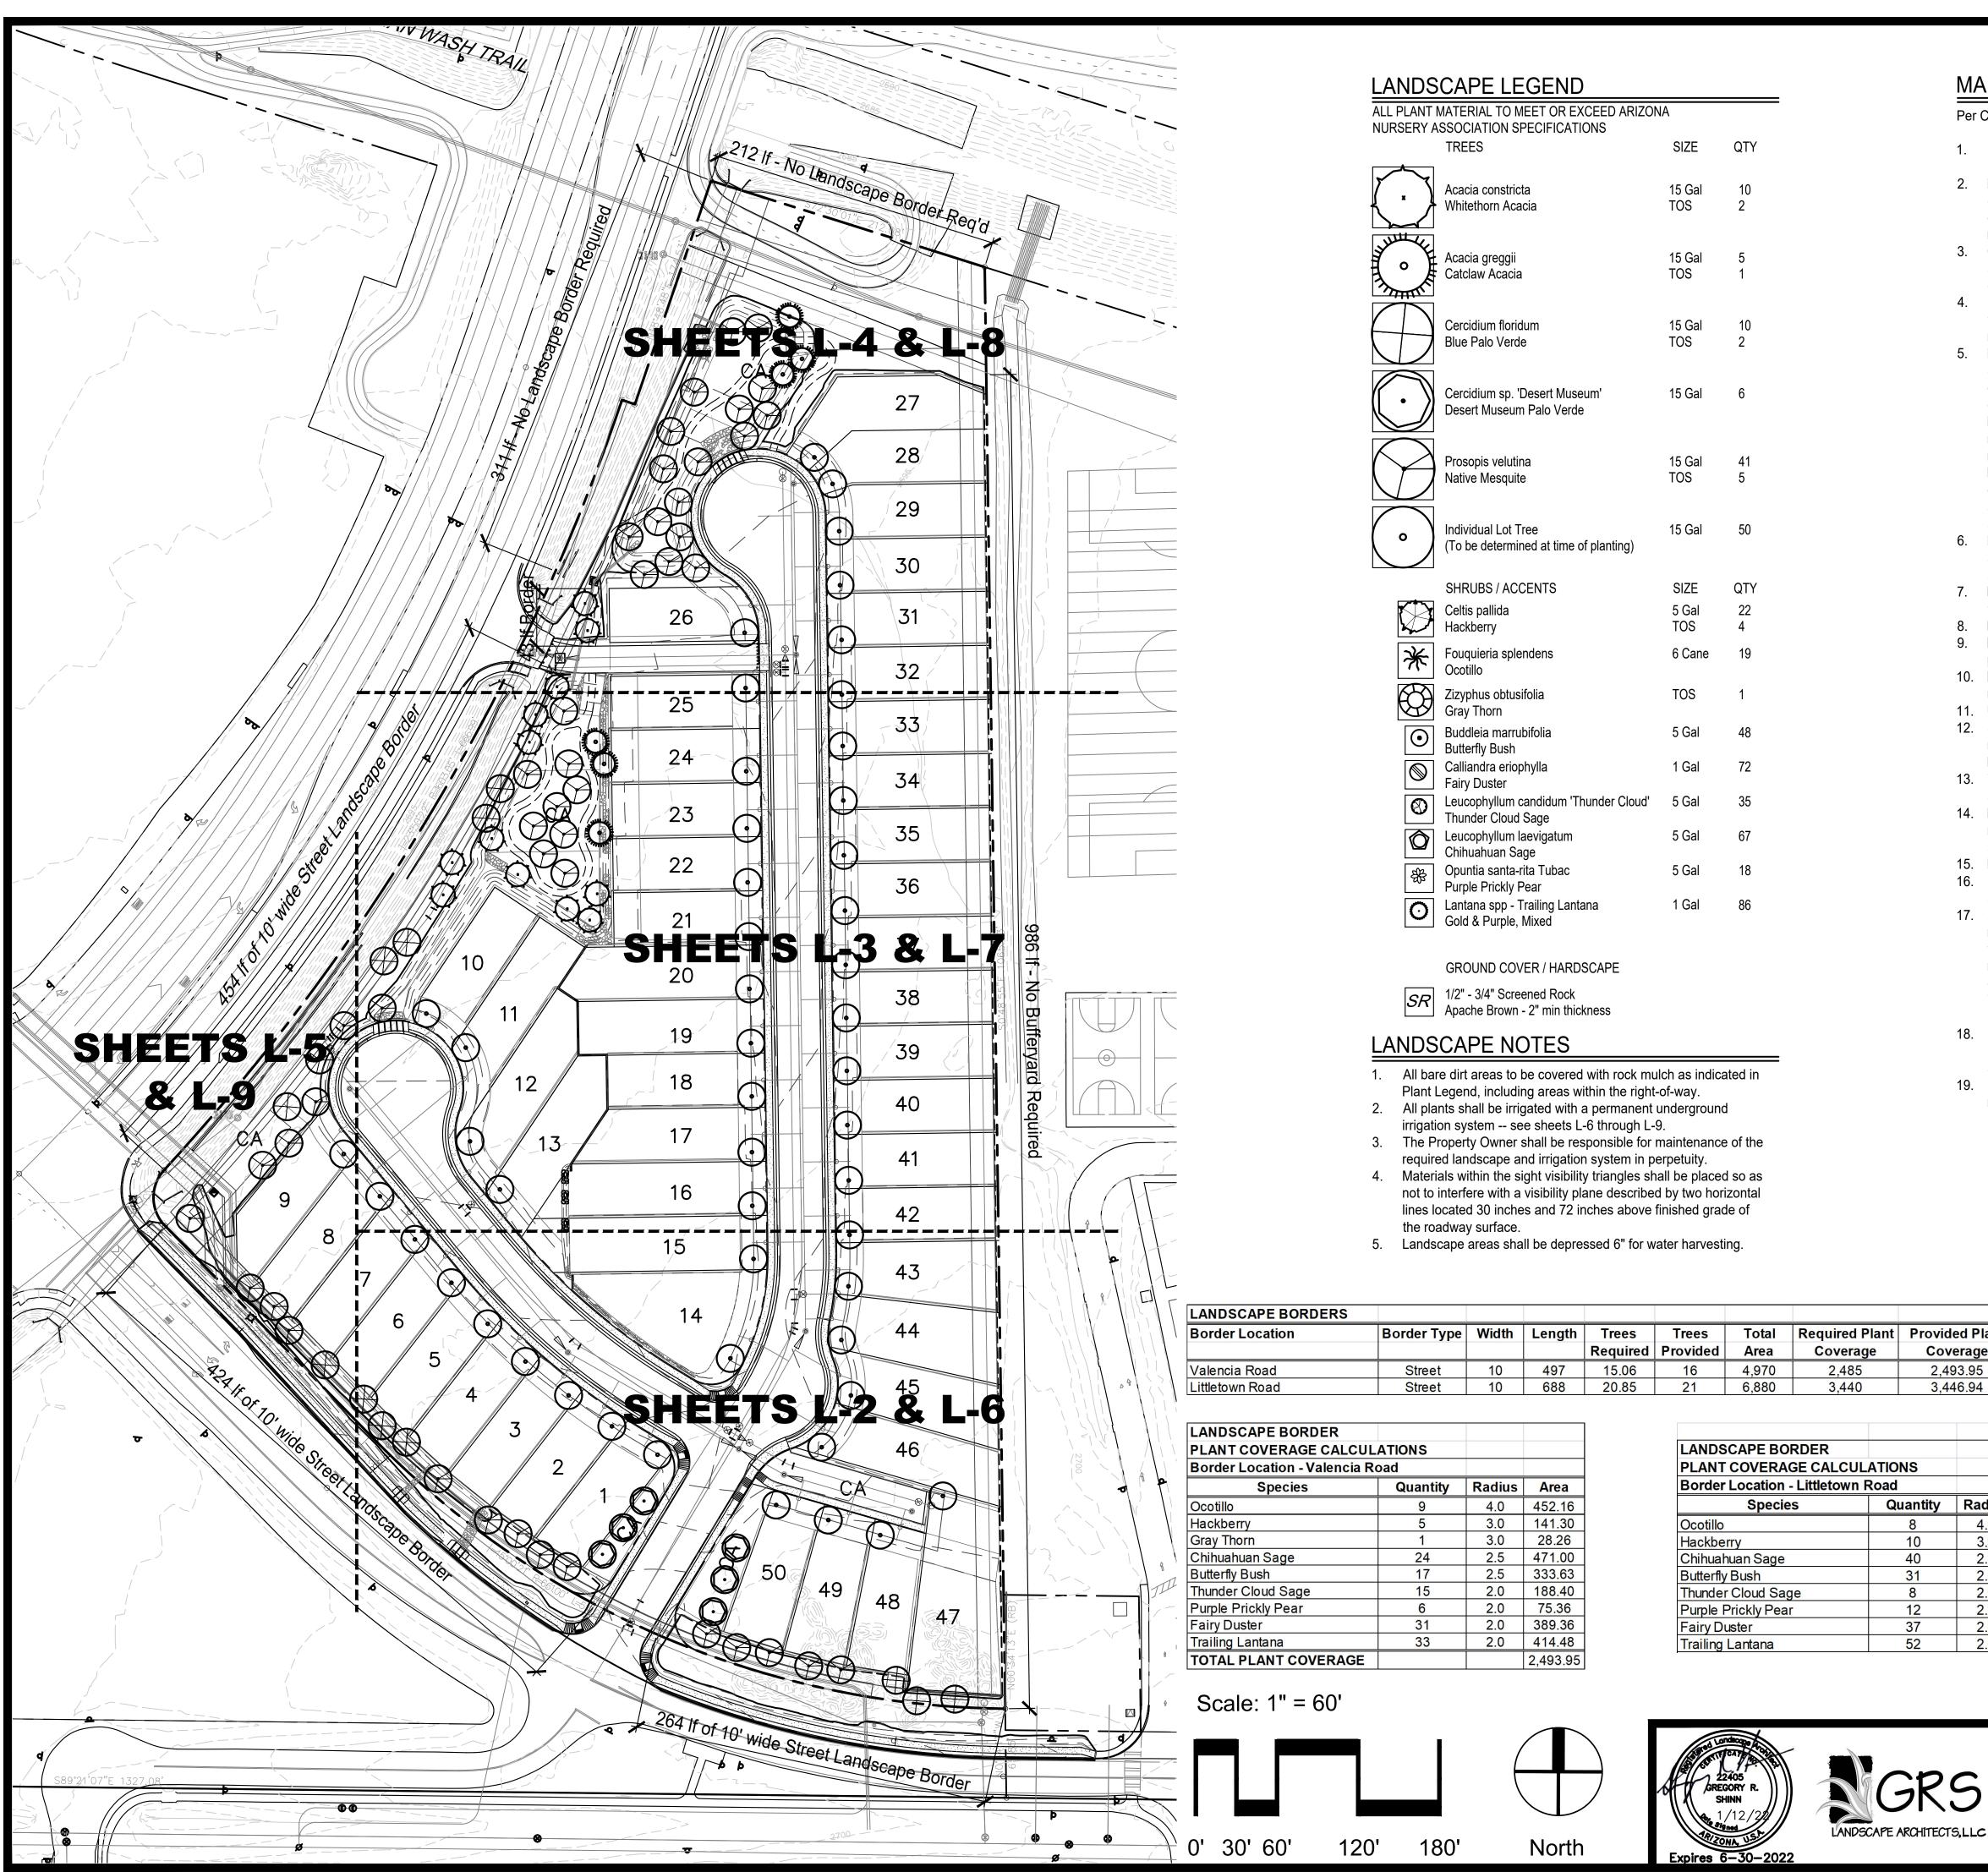

*	Whitethorn Acacia	TOS	2
	Acacia greggii Catclaw Acacia	15 Gal TOS	5 1
E	Cercidium floridum Blue Palo Verde	15 Gal TOS	10 2
	Cercidium sp. 'Desert Museum' Desert Museum Palo Verde	15 Gal	6
\mathcal{E}	Prosopis velutina Native Mesquite	15 Gal TOS	41 5
0	Individual Lot Tree (To be determined at time of planting)	15 Gal	50
	, 		
	SHRUBS / ACCENTS	SIZE	QTY
	SHRUBS / ACCENTS Celtis pallida Hackberry	SIZE 5 Gal TOS	QTY 22 4
	Celtis pallida	5 Gal	22
	Celtis pallida Hackberry Fouquieria splendens	5 Gal TOS	22 4
	 Celtis pallida Hackberry Fouquieria splendens Ocotillo Zizyphus obtusifolia Gray Thorn Buddleia marrubifolia 	5 Gal TOS 6 Cane	22 4 19
	 Celtis pallida Hackberry Fouquieria splendens Ocotillo Zizyphus obtusifolia Gray Thorn Buddleia marrubifolia Butterfly Bush Calliandra eriophylla 	5 Gal TOS 6 Cane TOS	22 4 19 1
	 Celtis pallida Hackberry Fouquieria splendens Ocotillo Zizyphus obtusifolia Gray Thorn Buddleia marrubifolia Butterfly Bush Calliandra eriophylla Fairy Duster Leucophyllum candidum 'Thunder Cloud' 	5 Gal TOS 6 Cane TOS 5 Gal	22 4 19 1 48
	 Celtis pallida Hackberry Fouquieria splendens Ocotillo Zizyphus obtusifolia Gray Thorn Buddleia marrubifolia Butterfly Bush Calliandra eriophylla Fairy Duster Leucophyllum candidum 'Thunder Cloud' Thunder Cloud Sage Leucophyllum laevigatum 	5 Gal TOS 6 Cane TOS 5 Gal 1 Gal	22 4 19 1 48 72
	 Celtis pallida Hackberry Fouquieria splendens Ocotillo Zizyphus obtusifolia Gray Thorn Buddleia marrubifolia Butterfly Bush Calliandra eriophylla Fairy Duster Leucophyllum candidum 'Thunder Cloud' Thunder Cloud Sage Leucophyllum laevigatum Chihuahuan Sage 	5 Gal TOS 6 Cane TOS 5 Gal 1 Gal 5 Gal	22 4 19 1 48 72 35

LANDSCAPE BORDERS								
Border Location	Border Type	Width	Length	Trees	Trees	Total	Required Plant	Provide
				Required	Provided	Area	Coverage	Cover
Valencia Road	Street	10	497	15.06	16	4,970	2,485	2,493
Littletown Road	Street	10	688	20.85	21	6,880	3,440	3,446

LANDSCAPE BORDER			
PLANT COVERAGE CALCUL	ATIONS		
Border Location - Valencia Ro	oad		
Species	Quantity	Radius	Area
Ocotillo	9	4.0	452.16
Hackberry	5	3.0	141.30
Gray Thorn	1	3.0	28.26
Chihuahuan Sage	24	2.5	471.00
Butterfly Bush	17	2.5	333.63
Thunder Cloud Sage	15	2.0	188.40
Purple Prickly Pear	6	2.0	75.36
Fairy Duster	31	2.0	389.36
Trailing Lantana	33	2.0	414.48
TOTAL PLANT COVERAGE			2,493.95

LANDSCAPE BORDER					
PLANT COVERAGE CAL	CULATIONS				
Border Location - Littletown Road					
Species	Quantity				
Ocotillo	8				
Hackberry	10				
Chihuahuan Sage	40				
Butterfly Bush	31				
Thunder Cloud Sage	8				
Purple Prickly Pear	12				
Fairy Duster	37				
Trailing Lantana	52				

MAINTENANCE SCHEDULE

Per COT Maintenance Standards UDC 7.6.8:

- 1. Any plant material in areas of required landscaping that does not survive must be replaced with an equivalent size and species within thirty (30) days.
- 2. Plant material must be pruned as necessary to control size but not to disrupt the natural growth pattern or characteristic form of the plant, except as necessary to achieve height clearance for visibility and pedestrian passage or to achieve a continuous opaque hedge if required. Pruning plant material into balls or other geometric shapes is discouraged.
- Clipping and pruning of trees is required to allow maximum shading while preserving surveillance opportunities and preventing obstructive overhang into walks, curb areas, drives and line of sight triangles as required by the Unified Development Code.
- 4. All dead or removed plant material must be replaced with plant material acceptable under the standards of the xeriscape landscaping standards. Replacement material must be a minimum fifteen (15) gallon size for trees and five (5) gallon size for shrubs. Regular landscape maintenance shall include:
- a. Irrigation System maintenance shall include, but not be limited to checking emitters, checking and repairing leaks, cleaning filters, replacing malfunctioning equipment and other activities as necessary for the proper and water efficient operation of the system. b. Weeding and Litter Removal shall include removal of weeds, preferably by mechanical means and not by inorganic chemicals, removing leaf litter, trash and other accumulated material. This operation shall be performed as necessary to maintain a weed free landscape. It will require more frequency during monsoon and winter rainy seasons. c. Turf Maintenance shall include, but not be limited to mowing, weed control, irrigating, aerating and dethatching as well as fertilizing and other activities necessary for the healthy appearance and growth of lawn areas.
- Exterior improvements, such as benches, walls or ramadas, must be of durable materials appropriate to the desert climate. Material with integral coloring or stucco is preferred for seating fixtures and other permanent improvements.
- Inert materials used in landscape areas must be of a nature to withstand the extremes of 7. the desert climate and minimize heat gain or reflected heat.
- Inert materials must be replaced as needed due to displacement or erosion. Inert materials must be used in inaccessible, narrow or hard to maintain sections of the planting areas.
- 10. Landscape areas must be kept free of trash, weeds, debris and dead plant material and must be maintained in a clean and neat fashion.
- 11. Use of river rock is discouraged adjacent to building windows.
- 12. Substantial modifications, as determined by the PDSD Director, and/or removal of plant materials or other landscape elements shall require review and approval of a revised landscape plan by PDSD.
- 13. The removal or destruction of landscape material that has been installed according to an approved landscape plan and not replaced constitutes a violation of the UDC.
- 14. Minor modifications of the landscaping occurring as a result of routing maintenance, necessary replacement of elements because of damage or disease, or other causes is not subject to review by PDSD.
- 15. Paint and stucco must be renewed on the surfaces of fences and walls as needed. 16. Wooden slats in chain link fences must be replaced as needed to retain the opacity of the
- screen. 17. Any screening device that has deteriorated to the point where it does not serve as a screen must be replaced by the property owner. Vegetation used to meet the screening standards that has been growing for more than two years may only be replaced with vegetation meeting the screening size at the time of replacement. Replacement can be with another option for screening, such as a fence or a wall, in order to achieve an immediate screen. This standard does not apply to the occasional replacement of single plants within a vegetative screen.
- 18. Automatic Irrigation Controllers are recommended to be reset a minimum of four times a year (spring, summer, fall and winter) to adjust for plant water requirements that vary according to the season.
- 19. Whenever possible, repair of irrigation equipment must be done with the originally specified materials or their equivalent.


ed Plant erage		Screening		
93.95	5'	High Lot Walls		
16.94		High Lot Walls		
Radius	Area			
4.0	401.92		DP22	$-\mathbf{x}\mathbf{x}\mathbf{x}$
3.0	282.60			
2.5	785.00			
2.5	608.38		LANDSCAPE PLAN	
2.0	100.48			
2.0	150.72		The Reserve at Valencia Cross	ing
2.0 2.0	464.72 653.12		Lots 1-50 & Common Areas "A-1"-"A-X" (Landscape, Grading, D)rainage
2.0	000.12	l 	and Utilities), "B-1"-B-X" (Recreation, Landscape, Grading, Drain Utilities) & "C-1" (Drainage) A Portion of the East Half of Section 11, T-15-S, R-14-E, G&SRM, Tucson, Pin	nage and
3	35974 S	. Desert Sun Dr	rive Date: 1/12/22 Design Review	_1

,	Tucson, AZ 85739
	(520) 909-4678
5	gregs@grslandscapearchitects.com

Date:	1/12/22	
Drawn by:	KVP/LMW	
Checked by:	GRS	

Construction Documents | L - / Agency Submittal **Construction Set** Not for Construction

12 of *22*

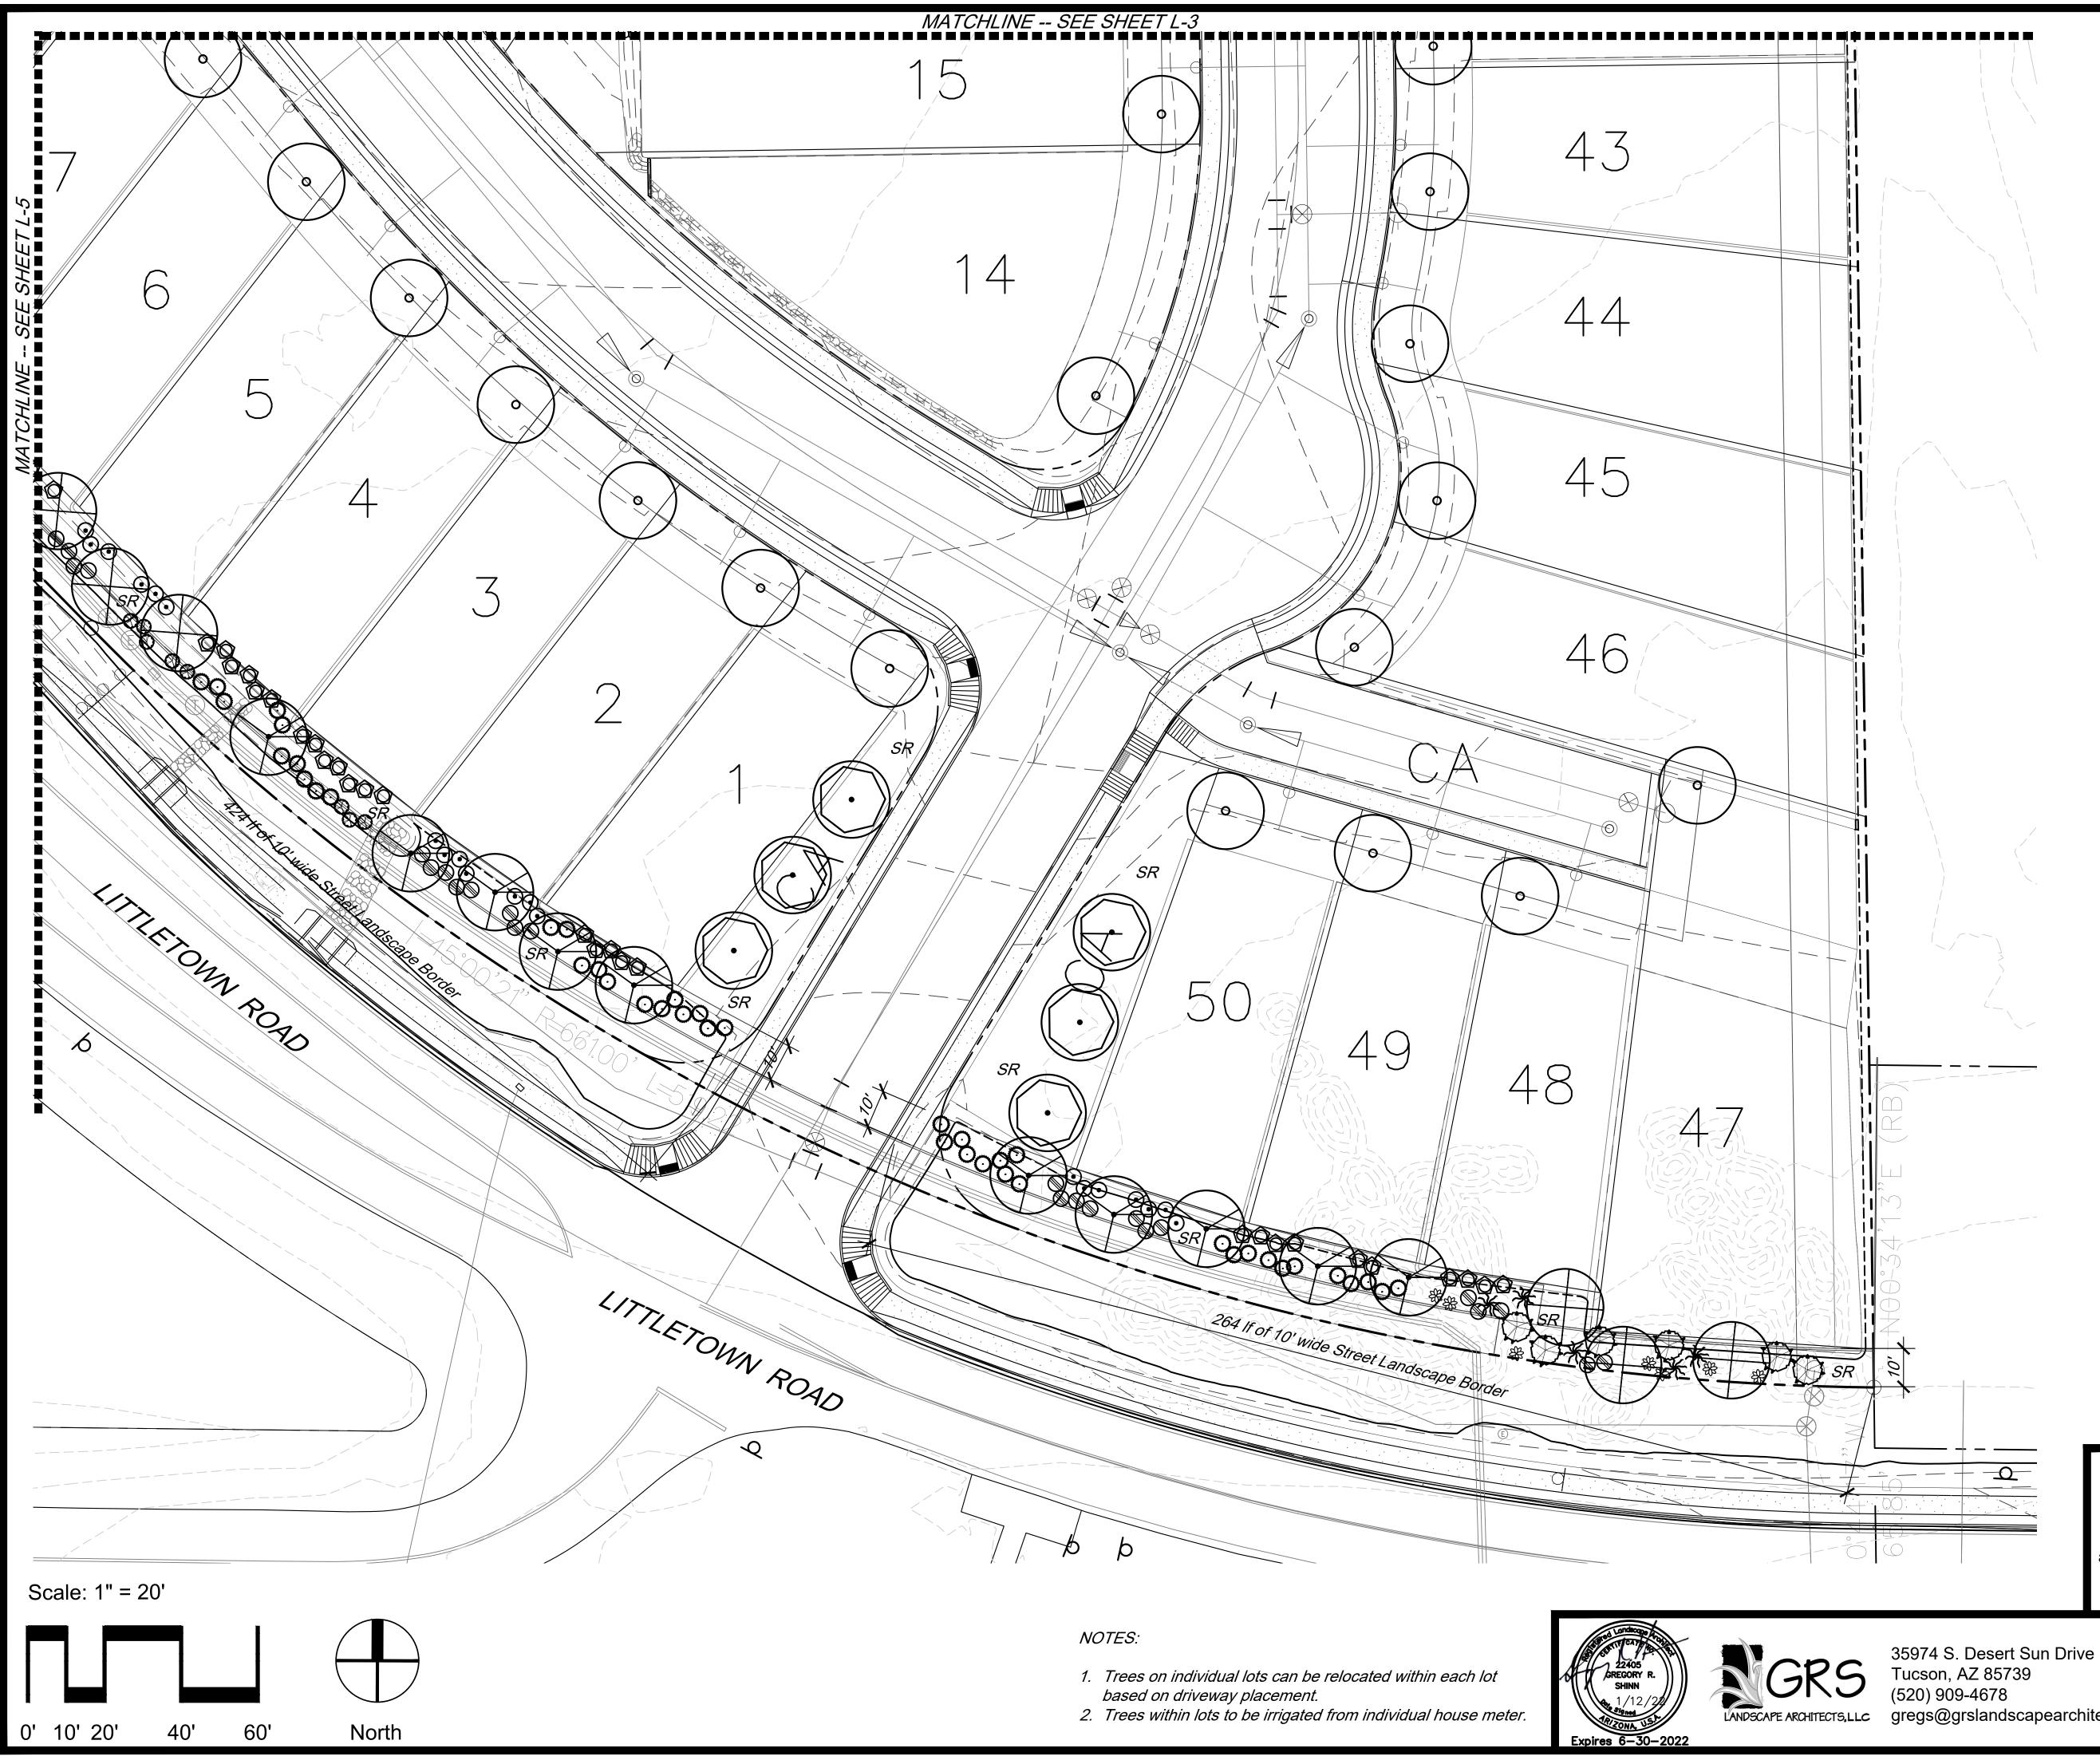

LANDS	CAPE LEGEND		
	MATERIAL TO MEET OR EXCEED ARIZON	IA	
	TREES	SIZE	QTY
	Acacia constricta Whitethorn Acacia	15 Gal TOS	10 2
ALL OF	Acacia greggii Catclaw Acacia	15 Gal TOS	5 1
\bigcirc	Cercidium floridum Blue Palo Verde	15 Gal TOS	10 2
\bigcirc	Cercidium sp. 'Desert Museum' Desert Museum Palo Verde	15 Gal	6
\bigcirc	Prosopis velutina Native Mesquite	15 Gal TOS	41 5
o	Individual Lot Tree (To be determined at time of planting)	15 Gal	50
	SHRUBS / ACCENTS	SIZE	QTY
\bigcirc	Celtis pallida Hackberry	5 Gal TOS	22 4
⋇	Fouquieria splendens Ocotillo	6 Cane	19
(\mathfrak{O})	Zizyphus obtusifolia Gray Thorn	TOS	1
$\overline{\bigcirc}$	Buddleia marrubifolia Butterfly Bush	5 Gal	48
$\overline{\texttt{O}}$	Calliandra eriophylla Fairy Duster	1 Gal	72
$\overline{\textcircled{0}}$	Leucophyllum candidum 'Thunder Cloud' Thunder Cloud Sage	5 Gal	35
	Leucophyllum laevigatum Chihuahuan Sage	5 Gal	67
	Opuntia santa-rita Tubac	5 Gal	18
Ō	Purple Prickly Pear Lantana spp - Trailing Lantana Gold & Purple, Mixed	1 Gal	86

GROUND COVER / HARDSCAPE



SR 1/2" - 3/4" Screened Rock Apache Brown - 2" min thickness

LANDSCAPE NOTES

- 1. All bare dirt areas to be covered with rock mulch as indicated in
- Plant Legend, including areas within the right-of-way. 2. All plants shall be irrigated with a permanent underground
- irrigation system -- see sheets L-6 through L-9. The Property Owner shall be responsible for maintenance of the 3.
- required landscape and irrigation system in perpetuity. Materials within the sight visibility triangles shall be placed so as not to interfere with a visibility plane described by two horizontal lines located 30 inches and 72 inches above finished grade of 4. the roadway surface.
- 5. Landscape areas shall be depressed 6" for water harvesting.

D	P2	2	—	X	X	X
υ	ΓZ	. 2	_	Х	X	X

LANDSCAPE PLAN The Reserve at Valencia Crossing

Lots 1-50 & Common Areas "A-1"-"A-X" (Landscape, Grading, Drainage and Utilities), "B-1"-B-X" (Recreation, Landscape, Grading, Drainage and

Utilities) & "C-1" (Drainage) A Portion of the East Half of Section 11, T-15-S, R-14-E, G&SRM, Tucson, Pima Co, AZ


gregs@grslandscapearchitects.com

– 🗆 Design Review 1/12/22 \Box Construction Documents Drawn by: KVP/LMW Agency Submittal


GRS 🛛 Not for Construction

L-2 13of22

Checked by:

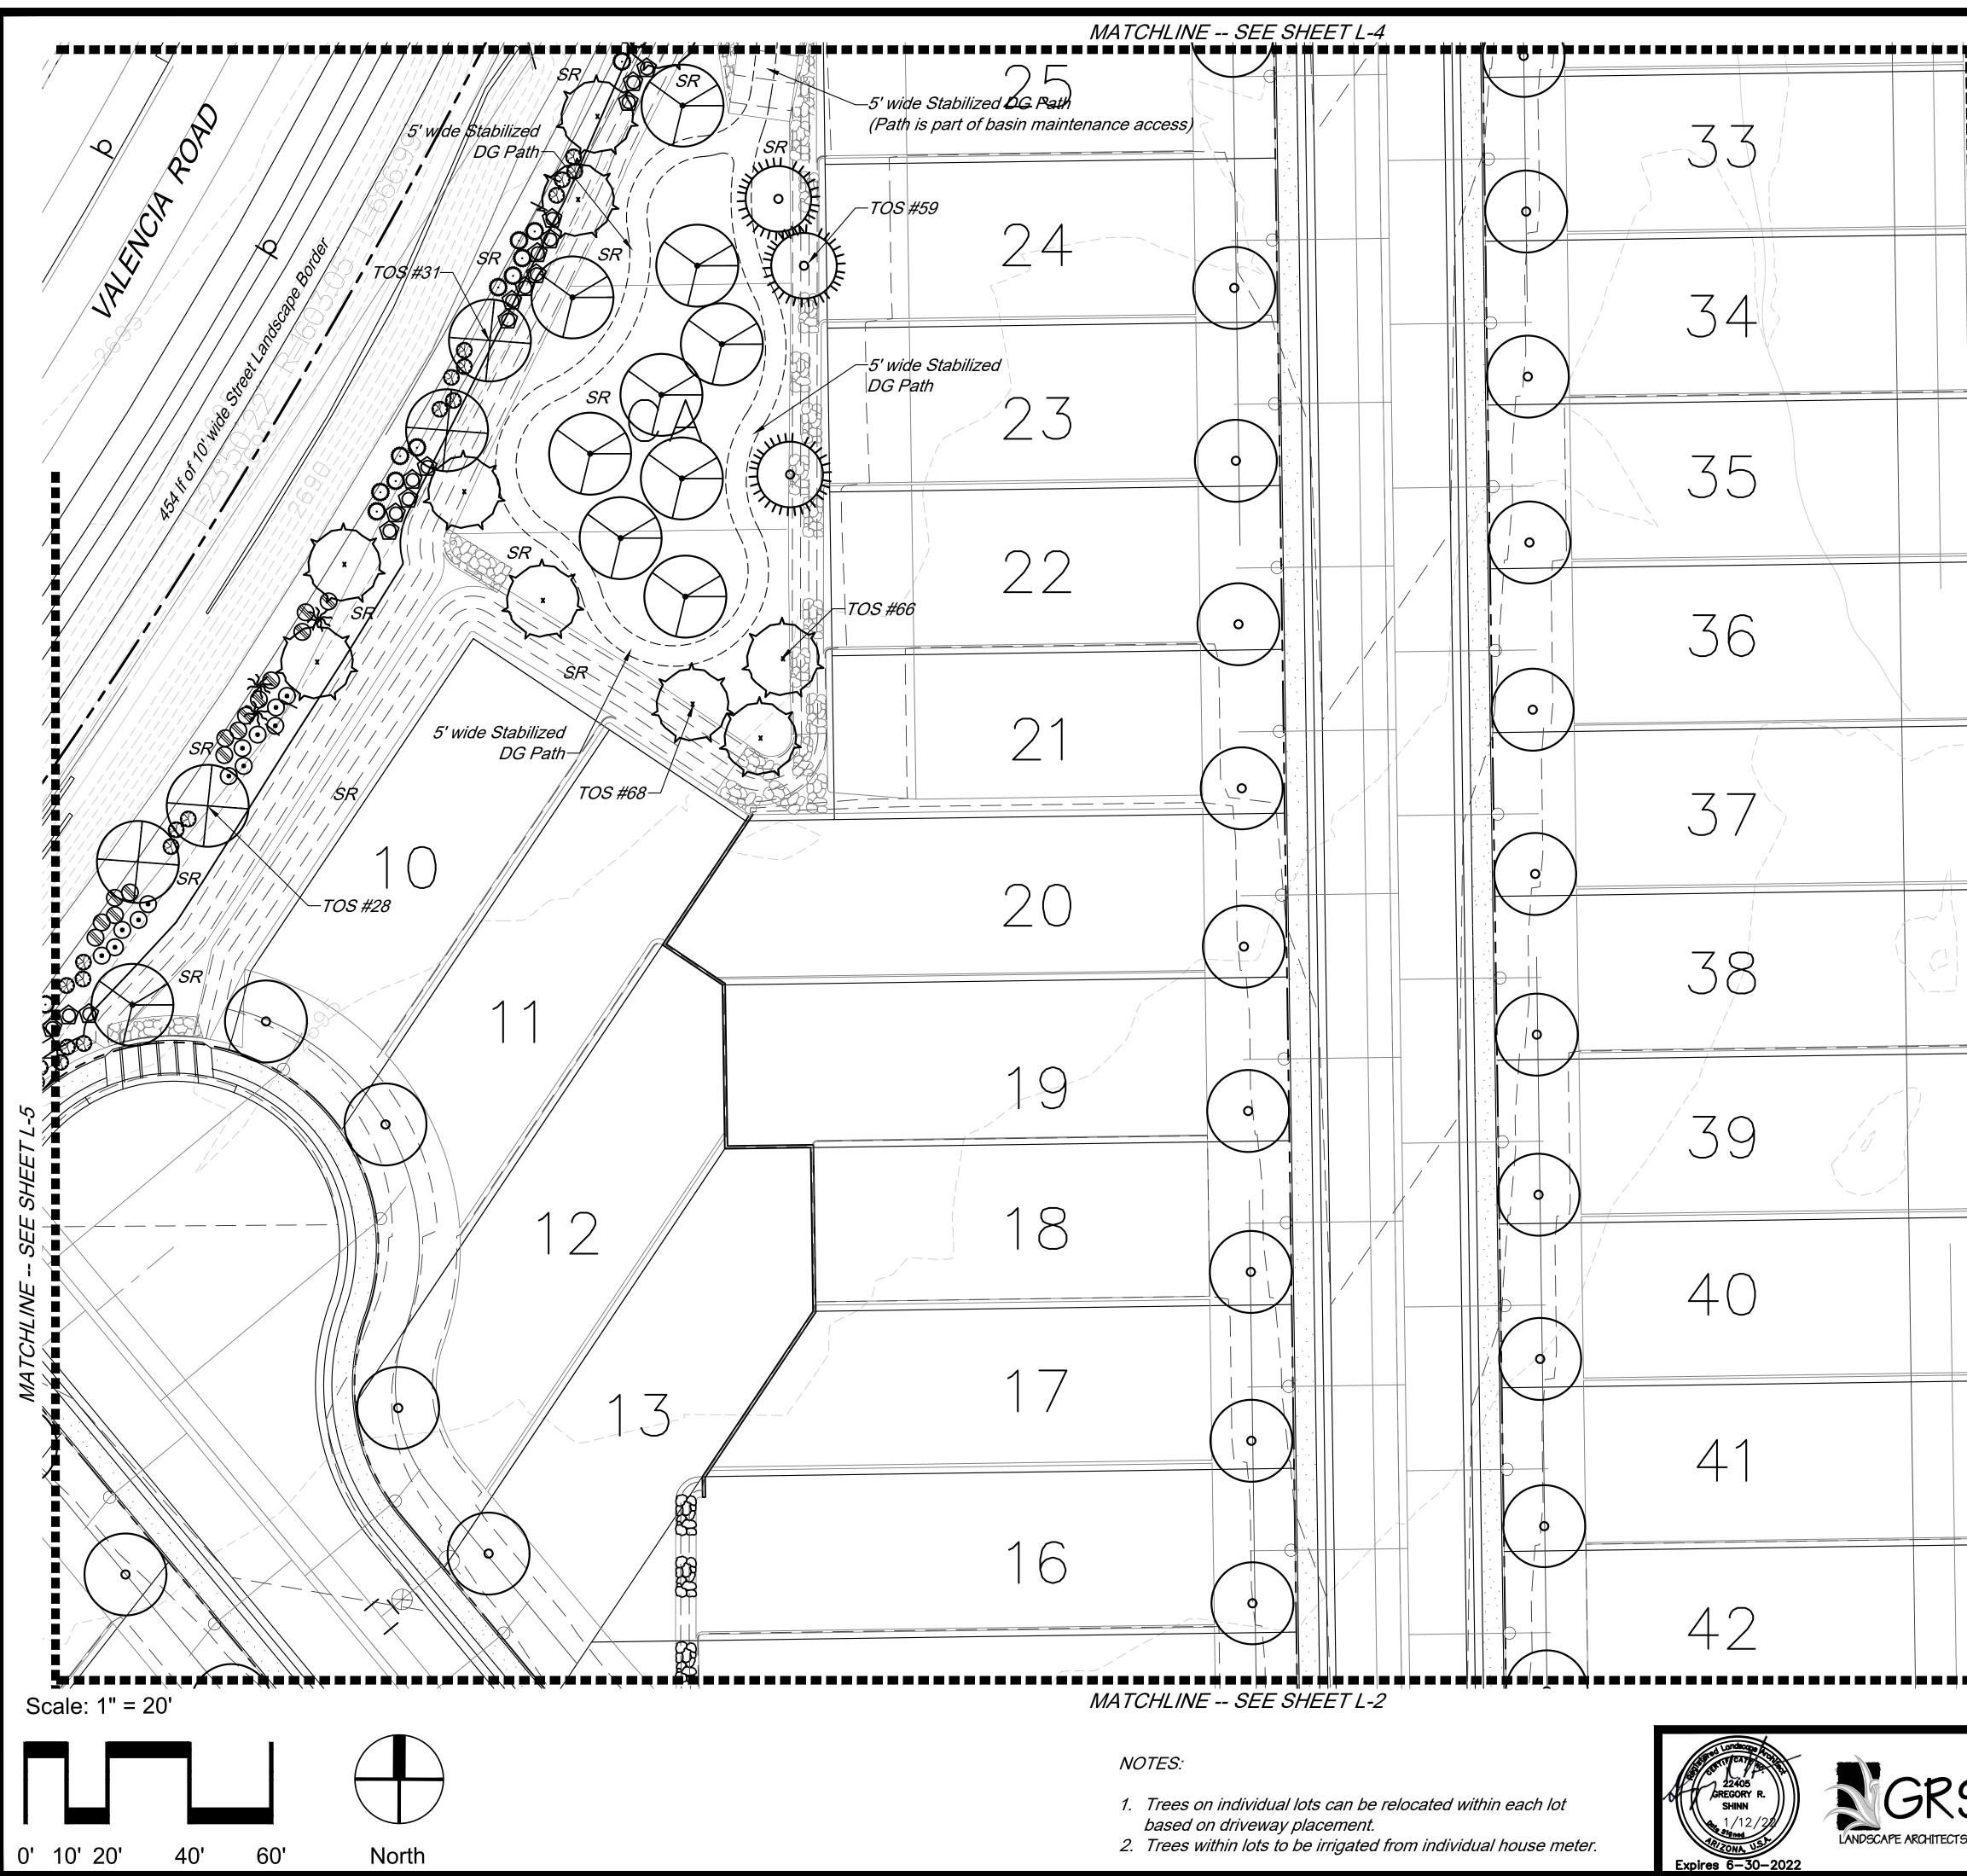

	LANDSCAPE LEGEND ALL PLANT MATERIAL TO MEET OR EXCEED ARIZONA	
	NURSERY ASSOCIATION SPECIFICATIONS	QTY
	Acacia constricta 15 Gal Whitethorn Acacia TOS	10 2
	Acacia greggii 15 Gal Catclaw Acacia TOS	5 1
	Cercidium floridum 15 Gal Blue Palo Verde TOS	10 2
	Cercidium sp. 'Desert Museum' 15 Gal Desert Museum Palo Verde	6
	Prosopis velutina 15 Gal Native Mesquite TOS	41 5
	Individual Lot Tree 15 Gal (To be determined at time of planting)	50
	SHRUBS / ACCENTS SIZE	QTY
	Celtis pallida 5 Gal Hackberry TOS	22 4
	Fouquieria splendens 6 Cane Ocotillo	19
	Zizyphus obtusifolia TOS Gray Thorn	1
	Buddleia marrubifolia 5 Gal Butterfly Bush	48
	Calliandra eriophylla 1 Gal Fairy Duster	72
	Leucophyllum candidum 'Thunder Cloud' 5 Gal Thunder Cloud Sage	35
	Leucophyllum laevigatum 5 Gal Chihuahuan Sage	67
	Opuntia santa-rita Tubac 5 Gal	18
	Lantana spp - Trailing Lantana 1 Gal Gold & Purple, Mixed	86
	GROUND COVER / HARDSCAPE	
	<i>SR</i> 1/2" - 3/4" Screened Rock Apache Brown - 2" min thickness	
	LANDSCAPE NOTES	
	 All bare dirt areas to be covered with rock mulch as indic Plant Legend, including areas within the right-of-way. All plants shall be irrigated with a permanent undergroun irrigation system see sheets L-6 through L-9. The Property Owner shall be responsible for maintenanc required landscape and irrigation system in perpetuity. Materials within the sight visibility triangles shall be place not to interfere with a visibility plane described by two ho lines located 30 inches and 72 inches above finished gra the roadway surface. Landscape areas shall be depressed 6" for water harves 	ed so as rizontal ide of
		DP22-xx
	LANDSCAPE PLAN	
	The Reserve at Valencia C	•
	Lots 1-50 & Common Areas "A-1"-"A-X" (Landscape, and Utilities), "B-1"-B-X" (Recreation, Landscape, Grad Utilities) & "C-1" (Drainage) A Portion of the East Half of Section 11, T-15-S, R-14-E, G&SRM,	ding, Drainage ar
35974 S. Desert Sun Dri	ve Date: 1/12/22 Design Review	ments L-3
5 Tucson, AZ 85739 (520) 909-4678	Drawn by: KVP/LMW Agency Submittal	
rs,∟∟c gregs@grslandscapearc	hitects.com Checked by: GRS 🛛 Not for Constructi	ion 14of22

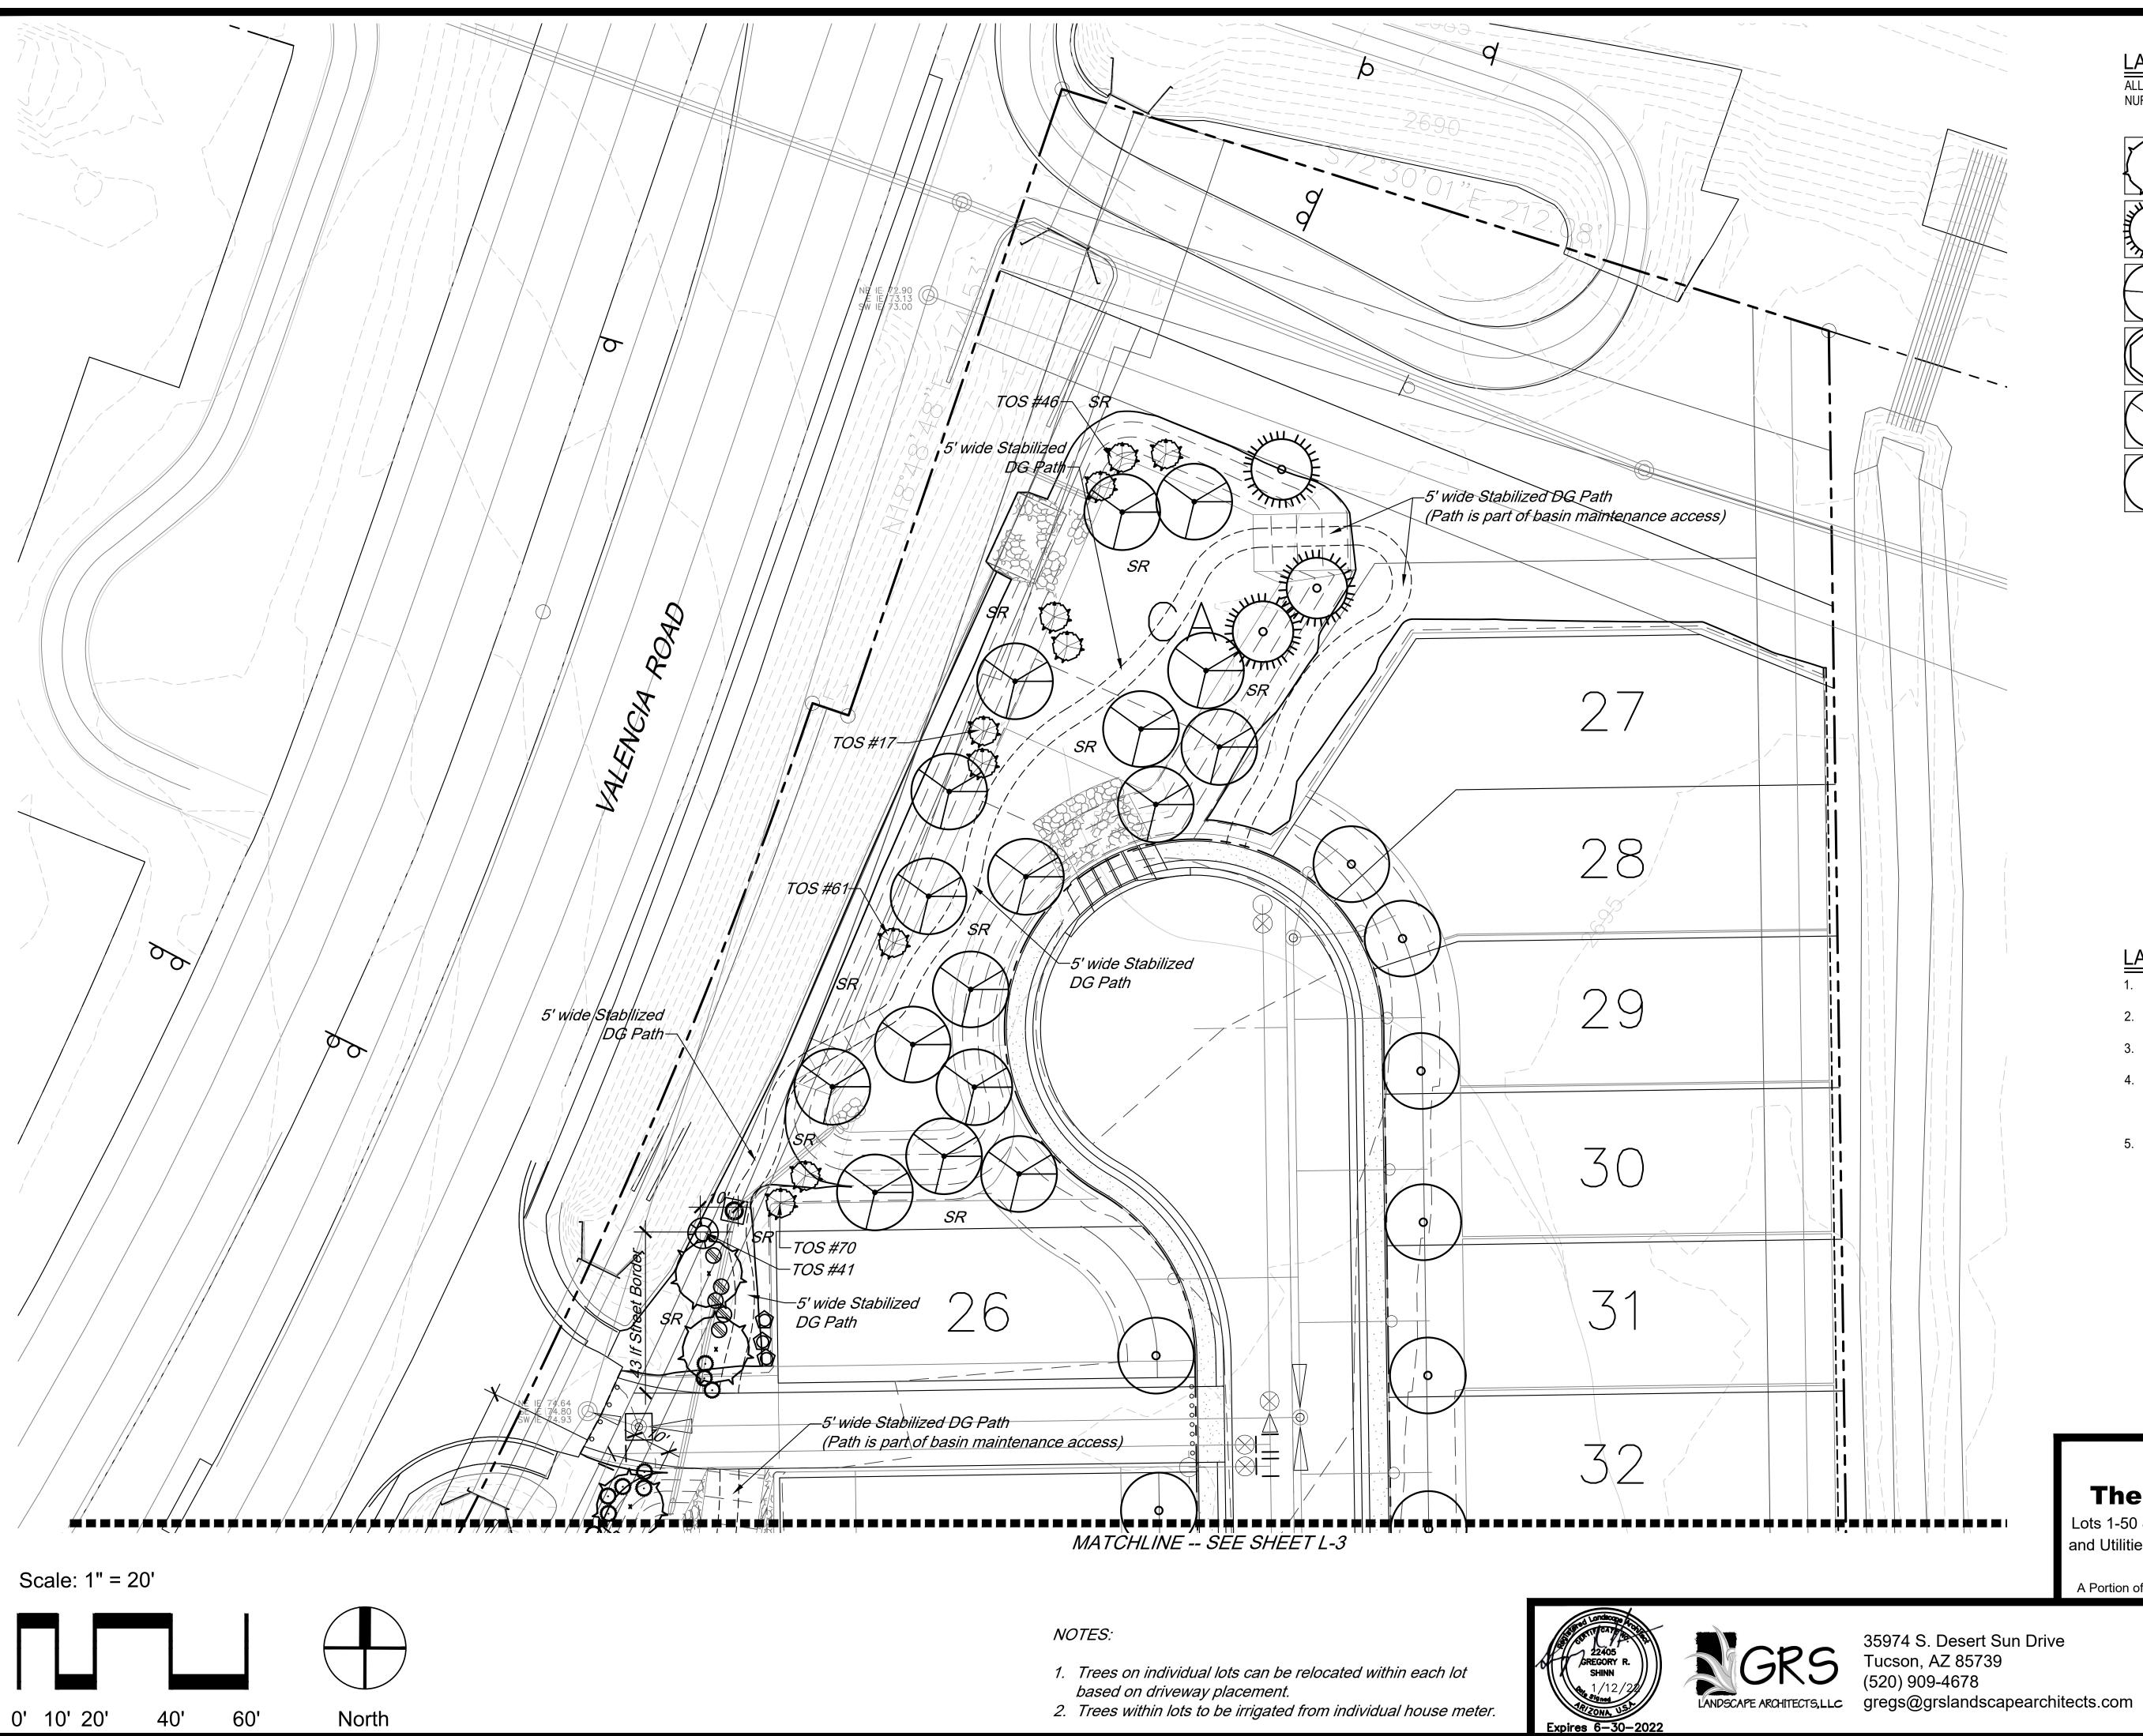

LANDS	CAPE LEGEND		
	MATERIAL TO MEET OR EXCEED ARIZON ASSOCIATION SPECIFICATIONS	IA	
	TREES	SIZE	QTY
×	Acacia constricta Whitethorn Acacia	15 Gal TOS	10 2
NO RE	Acacia greggii Catclaw Acacia	15 Gal TOS	5 1
\bigcirc	Cercidium floridum Blue Palo Verde	15 Gal TOS	10 2
\bigcirc	Cercidium sp. 'Desert Museum' Desert Museum Palo Verde	15 Gal	6
	Prosopis velutina Native Mesquite	15 Gal TOS	41 5
o	Individual Lot Tree (To be determined at time of planting)	15 Gal	50
	SHRUBS / ACCENTS	SIZE	QTY
\bigcirc	Celtis pallida Hackberry	5 Gal TOS	22 4
⋇	Fouquieria splendens Ocotillo	6 Cane	19
\bigcirc	Zizyphus obtusifolia Gray Thorn	TOS	1
$\overline{\bigcirc}$	Buddleia marrubifolia Butterfly Bush	5 Gal	48
	Calliandra eriophylla Fairy Duster	1 Gal	72
0	Leucophyllum candidum 'Thunder Cloud' Thunder Cloud Sage	5 Gal	35
	Leucophyllum laevigatum Chihuahuan Sage	5 Gal	67
- R	Opuntia santa-rita Tubac Purple Prickly Pear	5 Gal	18
\bigcirc	Lantana spp - Trailing Lantana Gold & Purple, Mixed	1 Gal	86

GROUND COVER / HARDSCAPE



SR 1/2" - 3/4" Screened Rock Apache Brown - 2" min thickness

LANDSCAPE NOTES

- 1. All bare dirt areas to be covered with rock mulch as indicated in
- Plant Legend, including areas within the right-of-way. 2. All plants shall be irrigated with a permanent underground
- irrigation system -- see sheets L-6 through L-9.
- 3. The Property Owner shall be responsible for maintenance of the
- required landscape and irrigation system in perpetuity. Materials within the sight visibility triangles shall be placed so as not to interfere with a visibility plane described by two horizontal 4. lines located 30 inches and 72 inches above finished grade of the roadway surface.
- 5. Landscape areas shall be depressed 6" for water harvesting.

DP22-xxx

LANDSCAPE PLAN The Reserve at Valencia Crossing


Lots 1-50 & Common Areas "A-1"-"A-X" (Landscape, Grading, Drainage and Utilities), "B-1"-B-X" (Recreation, Landscape, Grading, Drainage and

Utilities) & "C-1" (Drainage) A Portion of the East Half of Section 11, T-15-S, R-14-E, G&SRM, Tucson, Pima Co, AZ

> — 🗆 Design Review 1/12/22
> Construction Documents Drawn by: KVP/LMW Agency Submittal Checked by:

GRS 🖾 Not for Construction

L-4 15of*22*

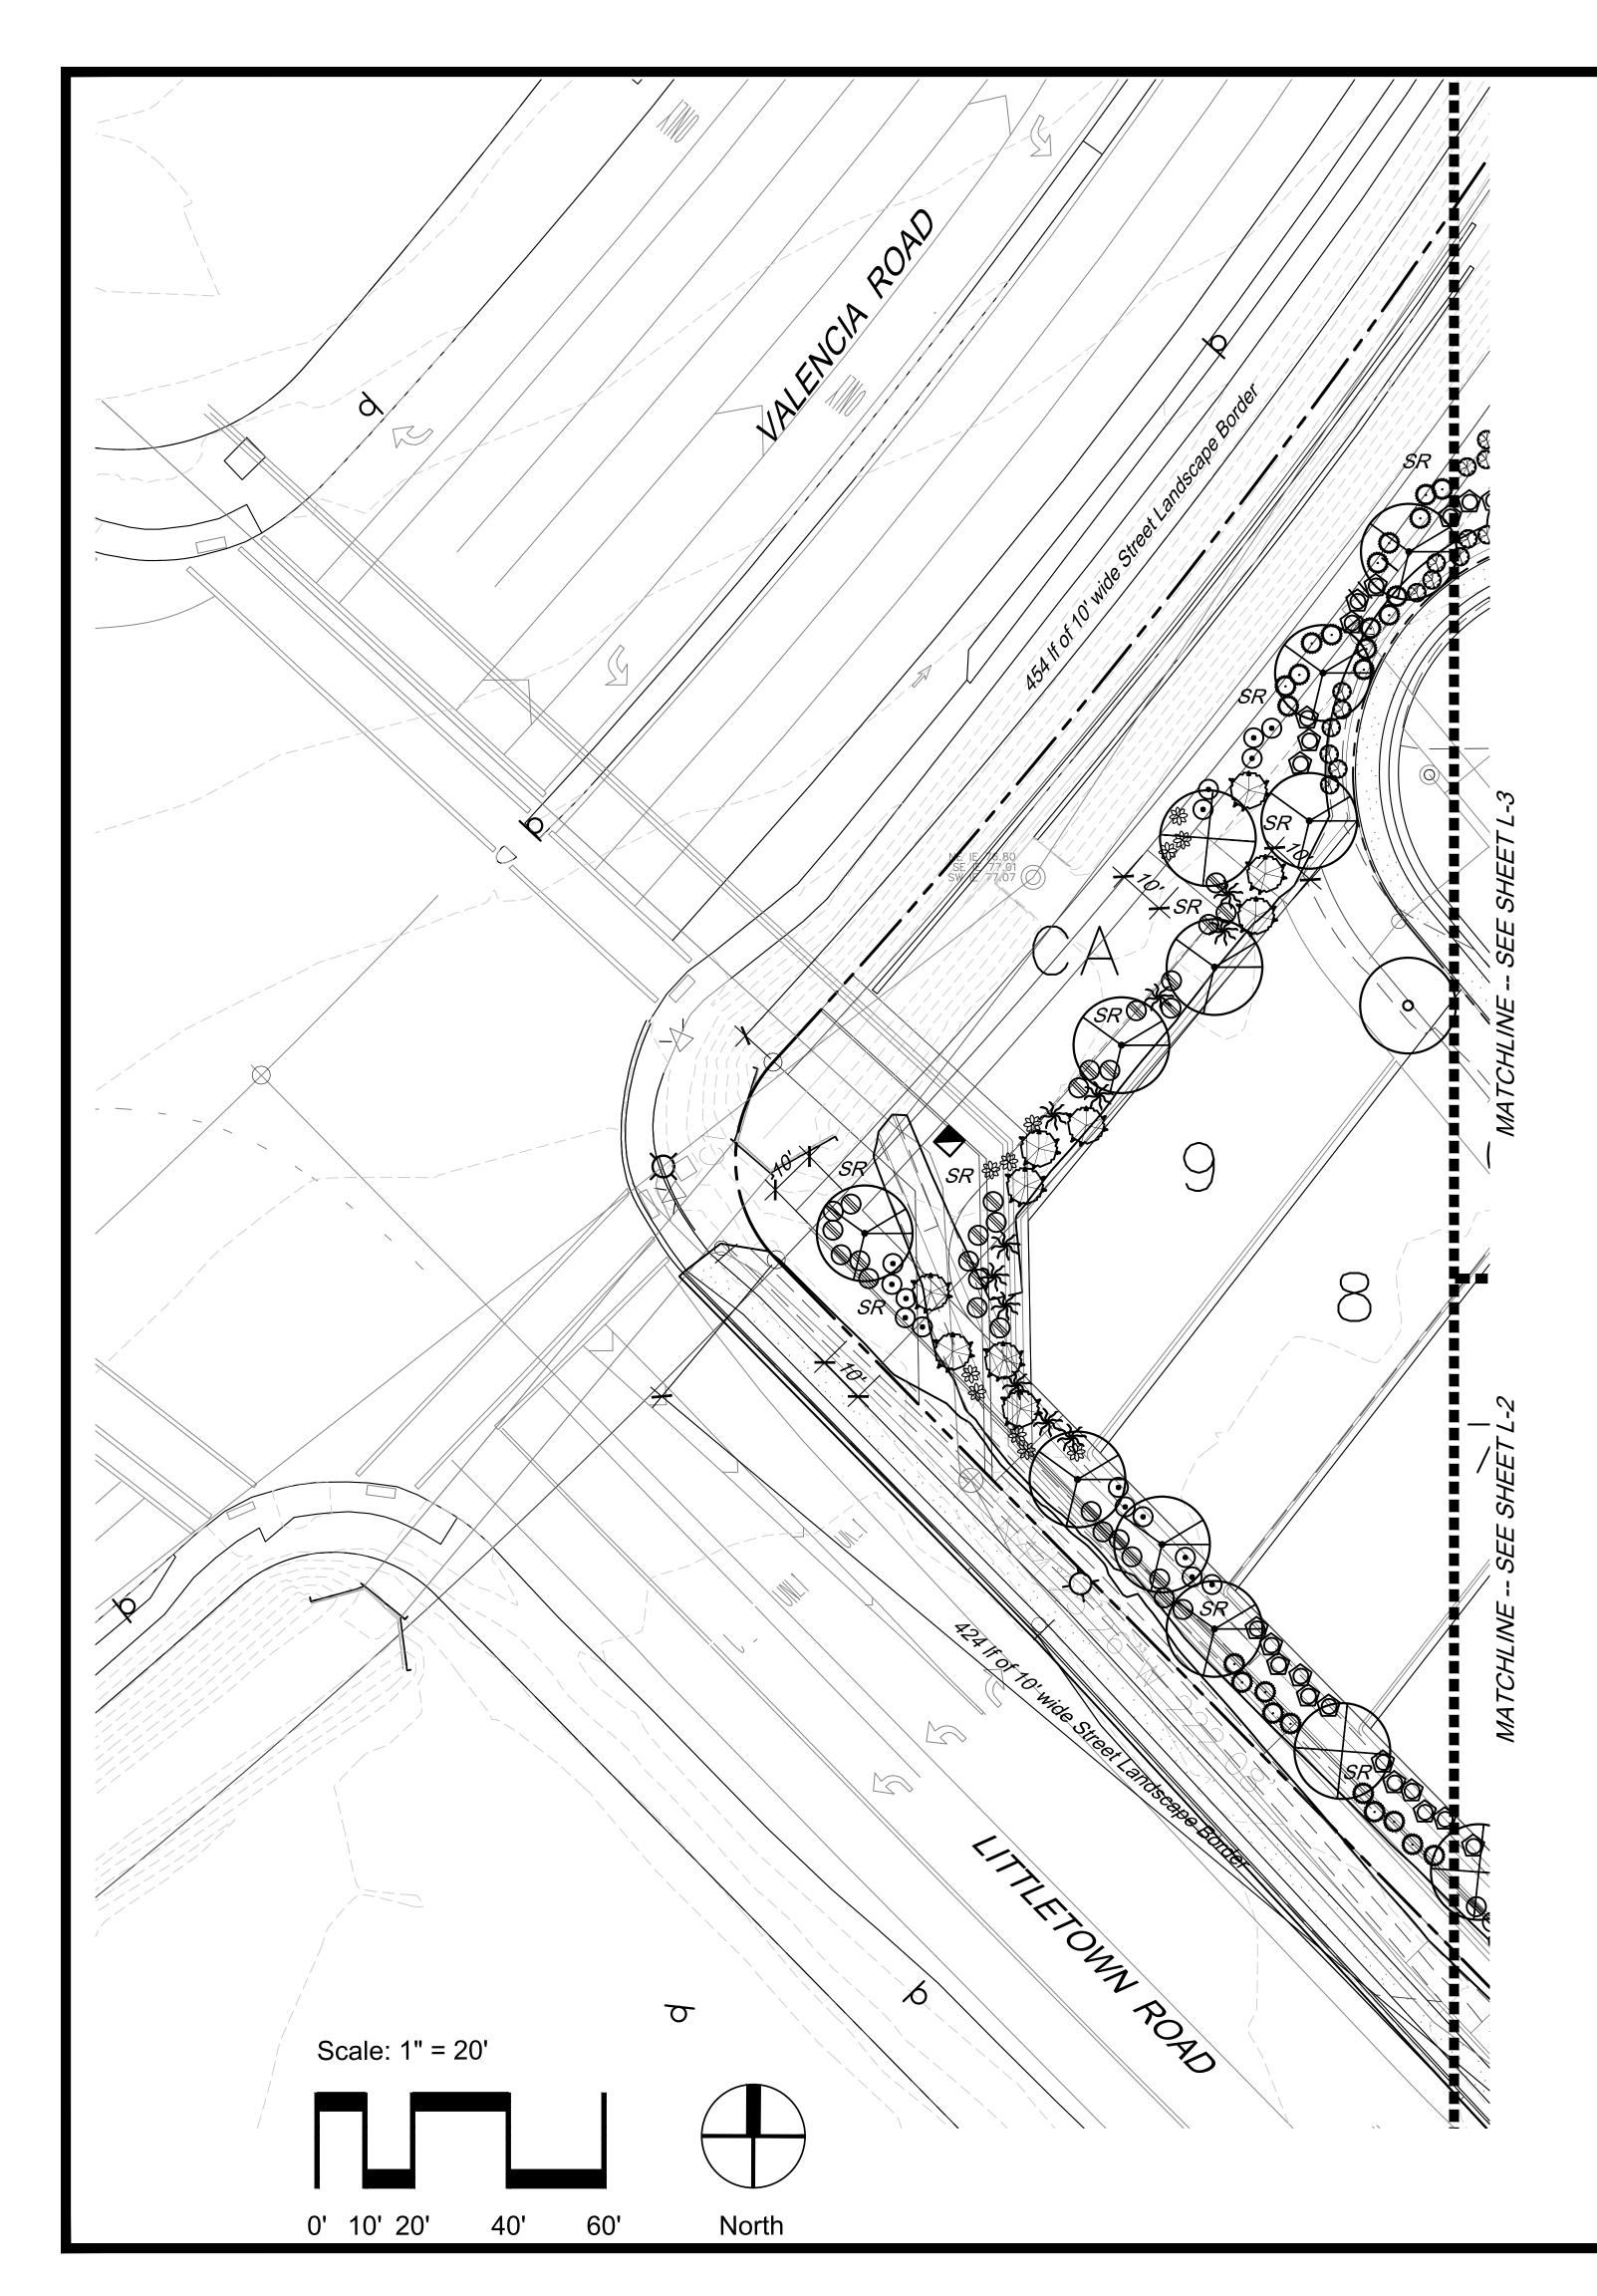

LANDSCAPE LEGEND

<u> AIND2</u>	CAPE LEGEND		
	MATERIAL TO MEET OR EXCEED ARIZON	IA	
JRSERT A	SSOCIATION SPECIFICATIONS TREES	SIZE	QTY
		0	~
	Acacia constricta	15 Gal	10
	Whitethorn Acacia	TOS	2
o J	Acacia greggii Catclaw Acacia	15 Gal TOS	5 1
	Calciaw Acacia	103	I
\square	Cercidium floridum	15 Gal	10
+	Blue Palo Verde	TOS	2
	Cercidium sp. 'Desert Museum'	15 Gal	6
	Desert Museum Palo Verde		
\searrow	Prosopis velutina	15 Gal	41
\square	Native Mesquite	TOS	5
\frown			50
•)	Individual Lot Tree (To be determined at time of planting)	15 Gal	50
	(10)		
	SHRUBS / ACCENTS	SIZE	QTY
	Celtis pallida	5 Gal	22
	Hackberry	TOS	4
 *	Fouquieria splendens Ocotillo	6 Cane	19
5	Zizyphus obtusifolia	TOS	1
	Gray Thorn	- - ·	15
\odot	Buddleia marrubifolia Butterfly Bush	5 Gal	48
$\overline{\bigcirc}$	Calliandra eriophylla	1 Gal	72
	Fairy Duster Leucophyllum candidum 'Thunder Cloud'	5 Gal	35
\odot	Thunder Cloud Sage		
$\hat{\mathbf{O}}$	Leucophyllum laevigatum Chihuahuan Sage	5 Gal	67
	Opuntia santa-rita Tubac	5 Gal	18
	Purple Prickly Pear	10-1	00
0	Lantana spp - Trailing Lantana Gold & Purple, Mixed	1 Gal	86
	• •		

GROUND COVER / HARDSCAPE

SR 1/2" - 3/4" Screened Rock Apache Brown - 2" min thickness

LANDSCAPE NOTES

- 1. All bare dirt areas to be covered with rock mulch as indicated in
- Plant Legend, including areas within the right-of-way.
- All plants shall be irrigated with a permanent underground irrigation system -- see sheets L-6 through L-9.
 The Property Owner shall be responsible for maintenance of the
- The Property Owner shall be responsible for maintenance of the required landscape and irrigation system in perpetuity.
 Materials within the sight visibility triangles shall be placed so as not to interfere with a visibility plane described by two horizontal lines located 30 inches and 72 inches above finished grade of the roadway surface.
- 5. Landscape areas shall be depressed 6" for water harvesting.

NOTES:

- 1. Trees on individual lots can be relocated within each lot based on driveway placement.
- 2. Trees within lots to be irrigated from individual house meter.



DP22-xxx

LANDSCAPE PLAN The Reserve at Valencia Crossing

Lots 1-50 & Common Areas "A-1"-"A-X" (Landscape, Grading, Drainage and Utilities), "B-1"-B-X" (Recreation, Landscape, Grading, Drainage and

Utilities) & "C-1" (Drainage)


A Portion of the East Half of Section 11, T-15-S, R-14-E, G&SRM, Tucson, Pima Co, AZ

35974 S. Desert Sun Drive Tucson, AZ 85739 (520) 909-4678 gregs@grslandscapearchitects.com

— 🗆 Design Review 1/12/22 \Box Construction Documents Drawn by: KVP/LMW Agency Submittal Checked by:

GRS 🖾 Not for Construction

L-5 16of*22*

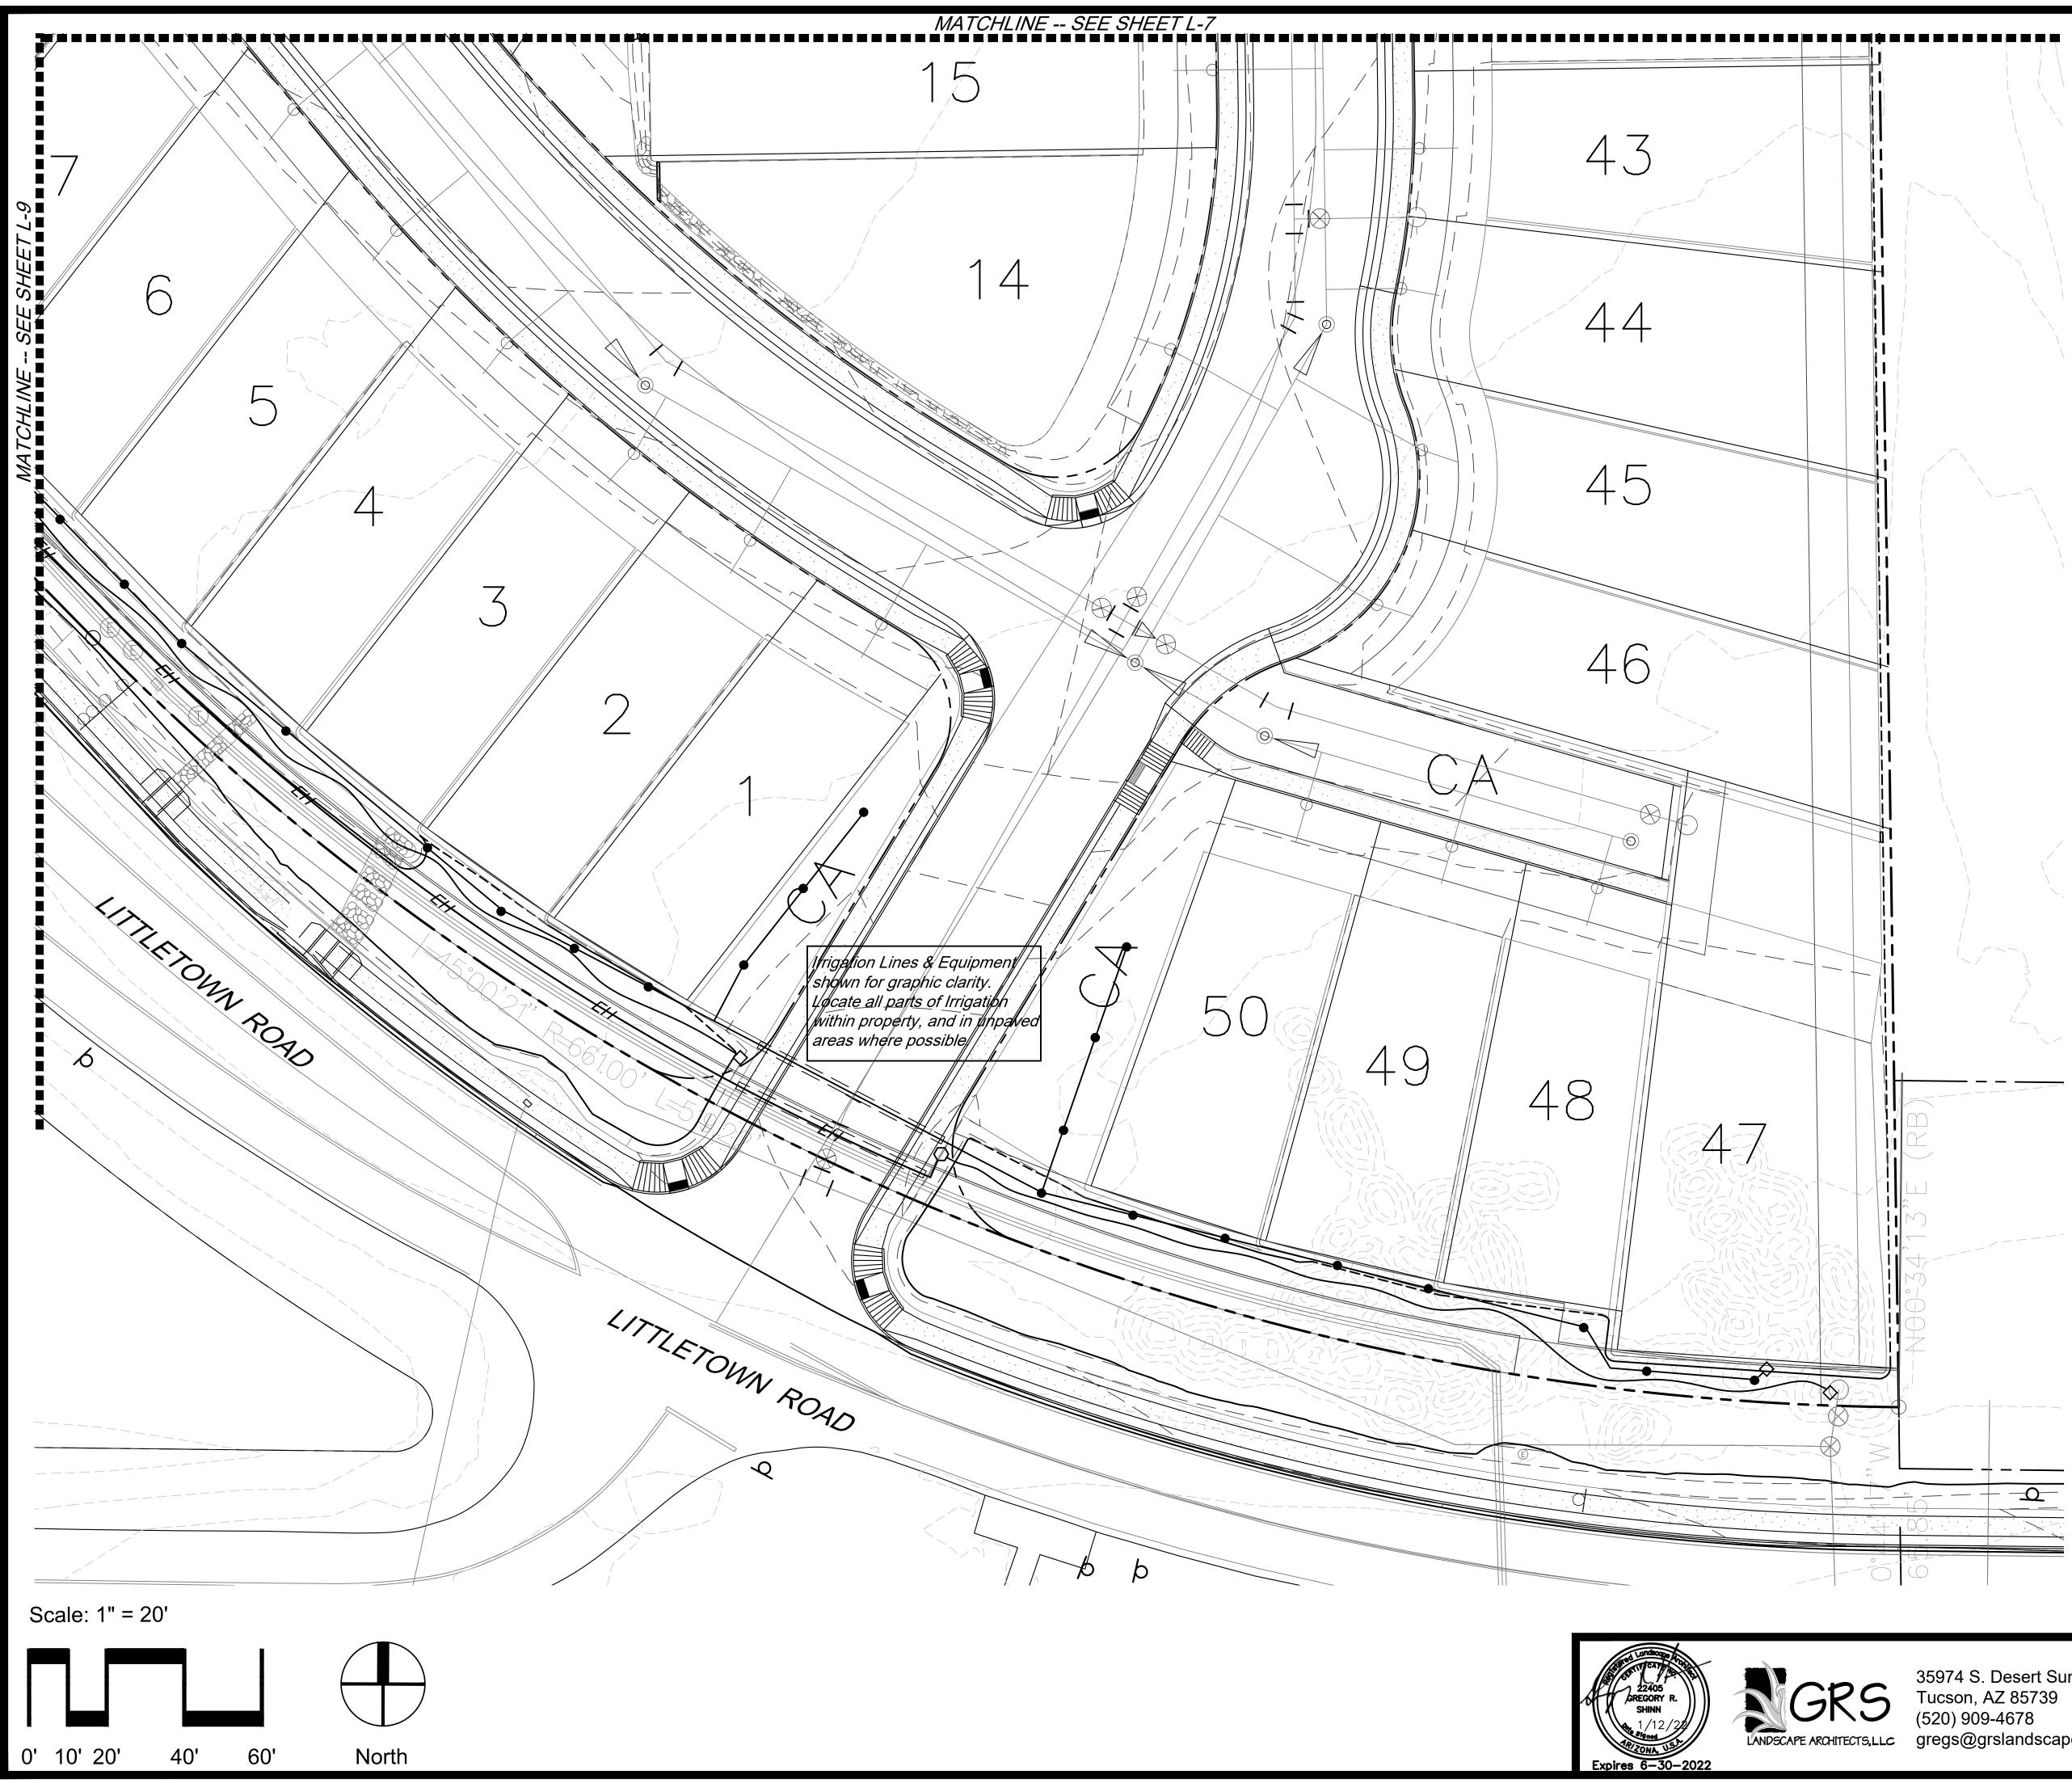

Ζ	Reduced Pressure Backflow Preventer, Mainline Size
//	Mainline - Schedule 40 PVC 1" unless otherwise noted
	Remote Control Valve - 1" - Rainbird 100 PEB and Rainbird RBY-100C Filter
_EH	Emitter Header - Schedule 40 PVC 1" unless otherwise noted
\bigcirc	Pressure Regulator - Fixed Outlet Pressure @ 40 psi - flow as required
\sim	Poly line580 poly line
	Emitter Line (Trees) - Class 200 PVC - 3/4" unless otherwise noted
•	Multiport Emitter - Rainbird XBT-10-6
	Sleeves - Schedule 40 PVC - 2" unless otherwise noted
A-1	Valve ID
A	Controller - Rainbird ESP-SMT with weather sensor. Contractor to coordinate electric for the controller.
\diamond	Hose End Caps

IRRIGATION NOTES

- 1. Contractor shall coordinate electrical power supply for irrigation controller. Contractor shall provide sleeves for remote control valve wires.
- 2. Irrigation plans are schematic. Locate lines and equipment in unpaved areas wherever possible.
- 3. Locate weather sensor so it is unimpeded by any structural elements.
- 4. Shrubs shall have (1) 1-gph emitter per 1 gallon plant and
 (2) 1-gph emitters per 5 gallon plant. Emitters shall be Rainbird Rainbug or approved equal.
- 5. Irrigation is designed at a minimum pressure of 50 PSI after the backflow preventer, and a minimum available flow of 5 gpm.



DP22-xxx

IRRIGATION PLAN

The Reserve at Valencia Crossing Lots 1-50 & Common Areas "A-1"-"A-X" (Landscape, Grading, Drainage and Utilities), "B-1"-B-X" (Recreation, Landscape, Grading, Drainage and

Utilities) & "C-1" (Drainage)

A Portion of the East Half of Section 11, T-15-S, R-14-E, G&SRM, Tucson, Pima Co, AZ


35974 S. Desert Sun Drive Tucson, AZ 85739 (520) 909-4678 gregs@grslandscapearchitects.com

9

		Design Review
Date:		□ Construction [
Drawn by:	KVP/LMW	X Agency Submi
Checked by:		Construction S
UNGUNGU Dy.		

Construction Documents Agency Submittal Construction Set GRS 🛛 Not for Construction

L-6 17of*22*

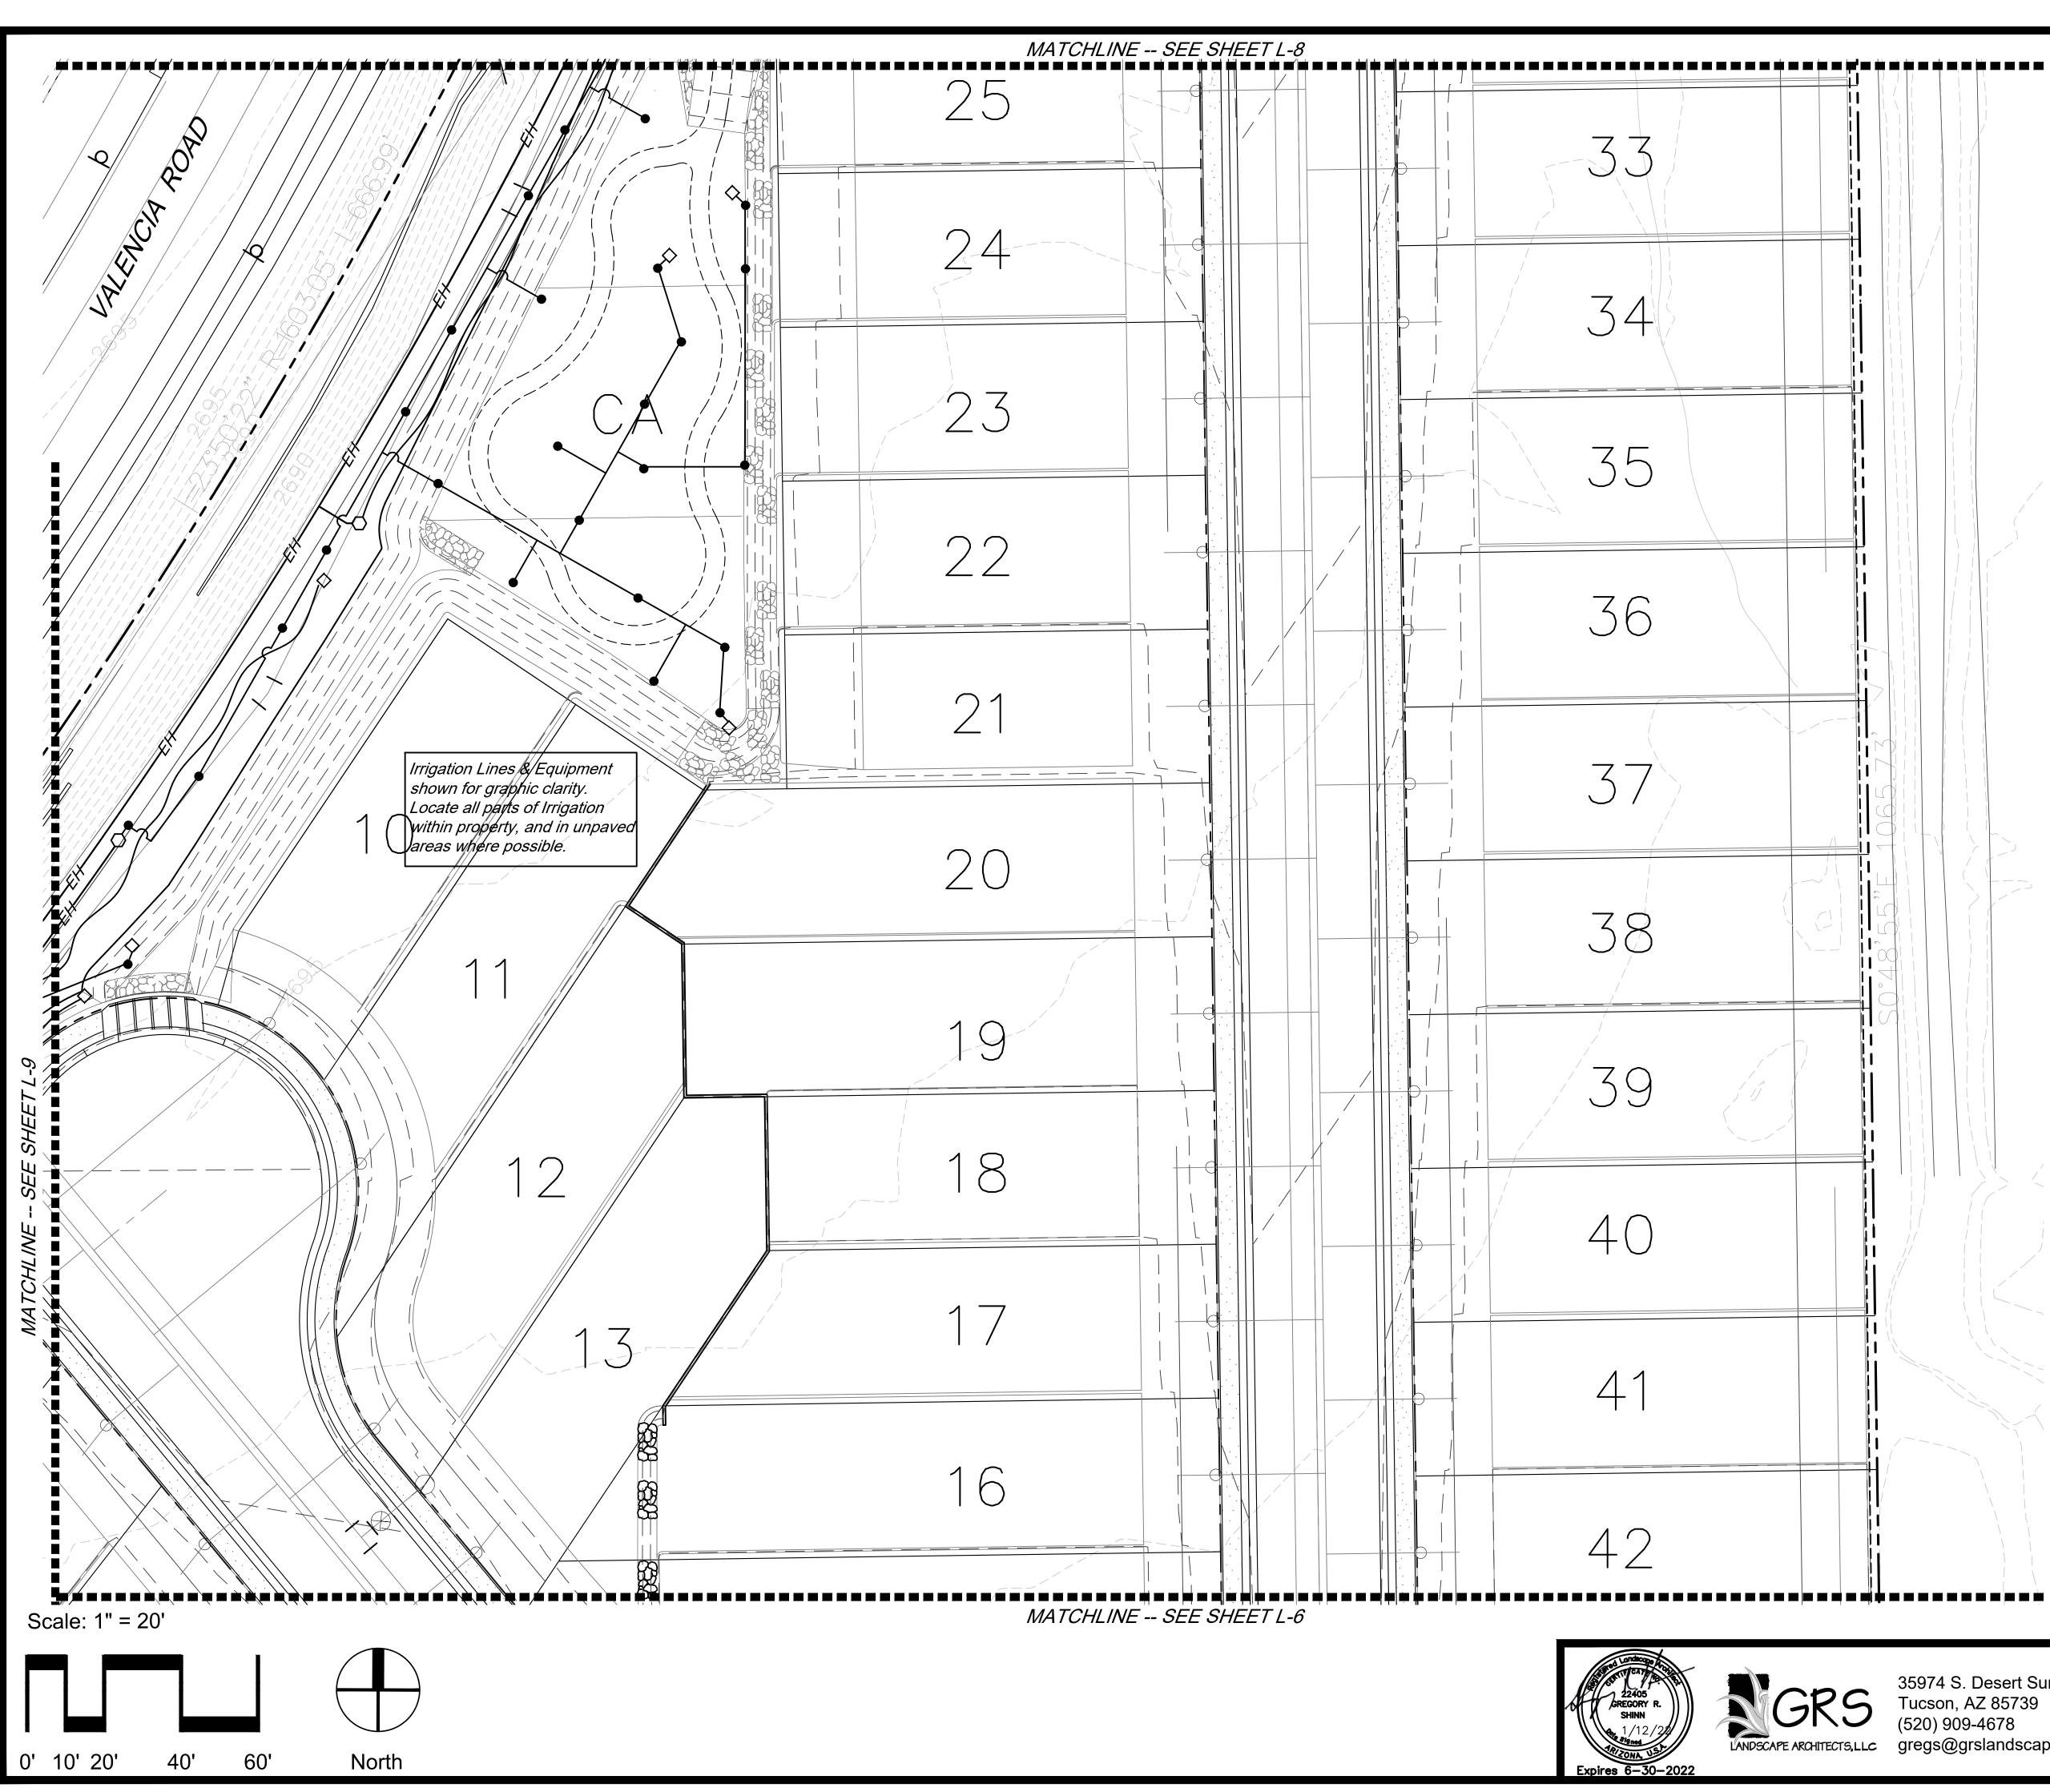

Ζ

 \bullet

ΞH

 \bigcirc

A-1

A

 \diamond



Reduced Pressure Backflow Preventer, Mainline Size Mainline - Schedule 40 PVC 1" unless otherwise noted Remote Control Valve - 1" - Rainbird 100 PEB and Rainbird RBY-100C Filter Emitter Header - Schedule 40 PVC 1" unless otherwise noted Pressure Regulator - Fixed Outlet Pressure @ 40 psi - flow as required Poly line - .580 poly line Emitter Line (Trees) - Class 200 PVC - 3/4" unless otherwise noted Multiport Emitter - Rainbird XBT-10-6 Sleeves - Schedule 40 PVC - 2" unless otherwise noted Valve ID Controller - Rainbird ESP-SMT with weather sensor. Contractor to coordinate electric for the controller.

IRRIGATION NOTES

Hose End Caps

- 1. Contractor shall coordinate electrical power supply for irrigation controller. Contractor shall provide sleeves for remote control valve wires.
- 2. Irrigation plans are schematic. Locate lines and equipment in unpaved areas wherever possible.
- 3. Locate weather sensor so it is unimpeded by any structural elements.
- 4. Shrubs shall have (1) 1-gph emitter per 1 gallon plant and (2) 1-gph emitters per 5 gallon plant. Emitters shall be Rainbird Rainbug or approved equal.
- 5. Irrigation is designed at a minimum pressure of 50 PSI after the backflow preventer, and a minimum available flow of 5 gpm.

DP22-xxx

IRRIGATION PLAN The Reserve at Valencia Crossing

Lots 1-50 & Common Areas "A-1"-"A-X" (Landscape, Grading, Drainage and Utilities), "B-1"-B-X" (Recreation, Landscape, Grading, Drainage and

Utilities) & "C-1" (Drainage) A Portion of the East Half of Section 11, T-15-S, R-14-E, G&SRM, Tucson, Pima Co, AZ


35974 S. Desert Sun Drive Tucson, AZ 85739 (520) 909-4678 gregs@grslandscapearchitects.com

		Design Review
ote:	1/12/22	□ Construction [
awn by:	KVP/LMW	🛛 Agency Submi

Checked by:

Construction Documents Agency Submittal □ Construction Set GRS 🛛 Not for Construction

L-7 18of22

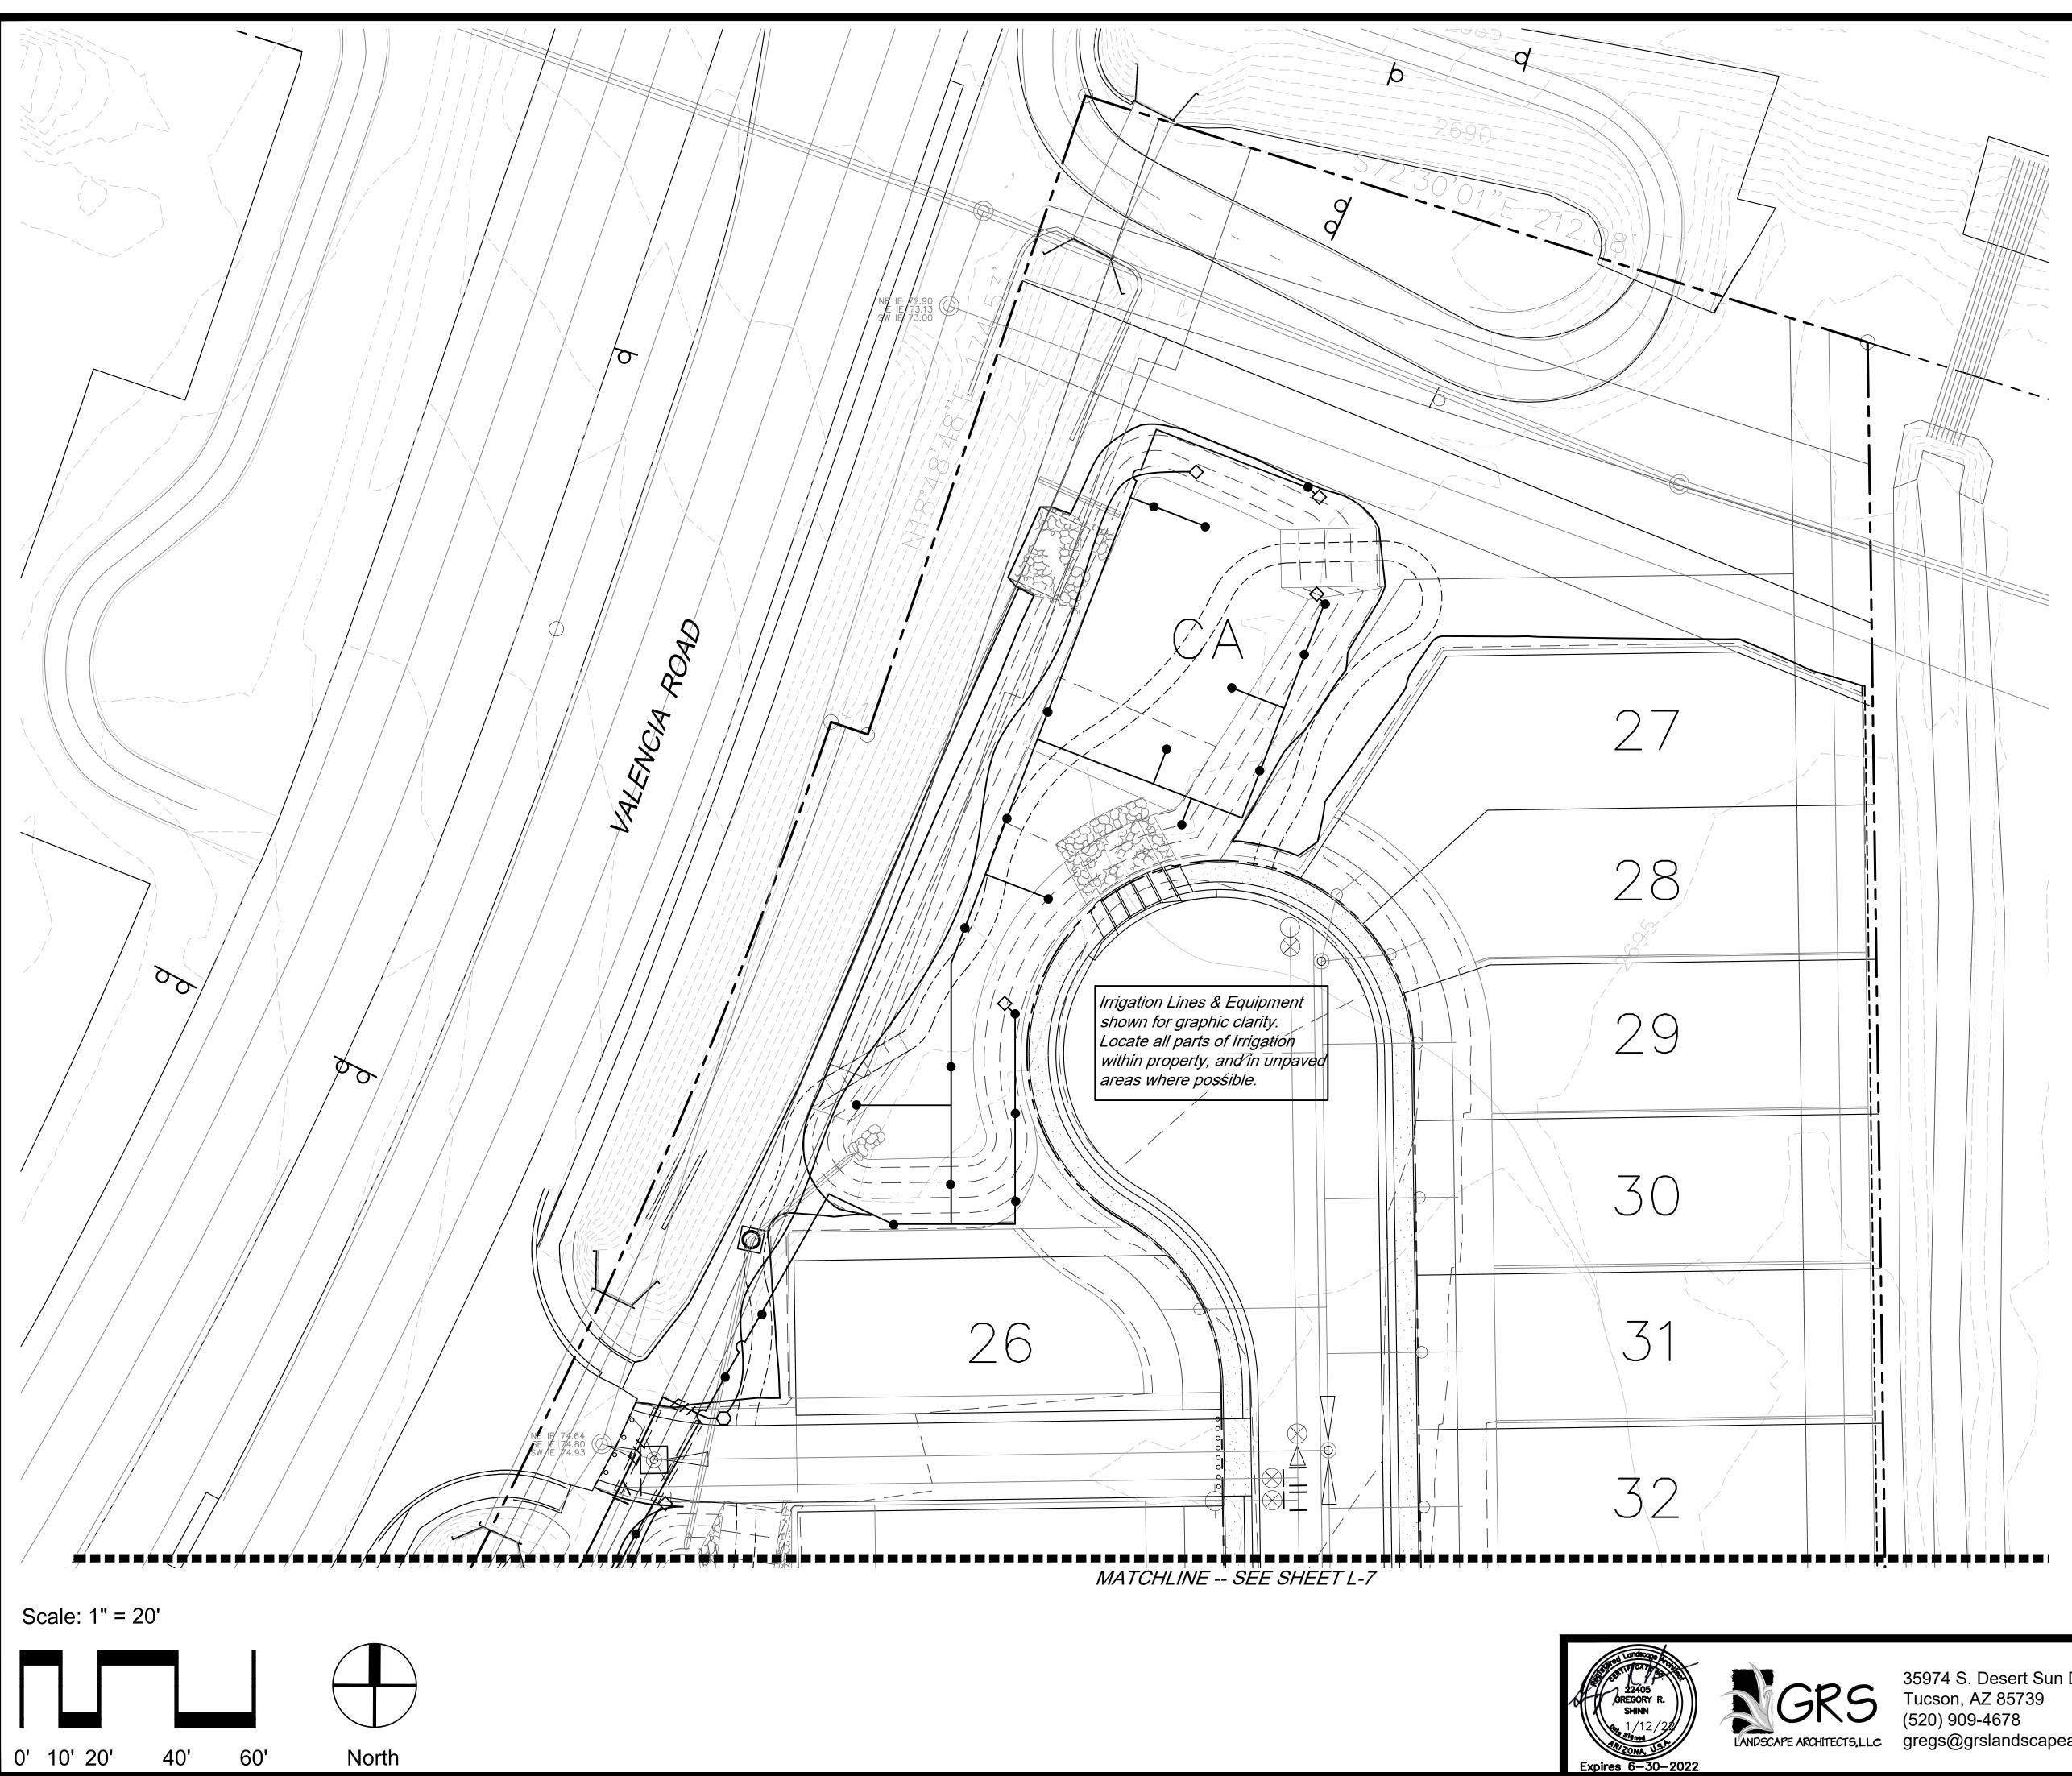

Ζ	Reduced Pressure Backflow Preventer, Mainline Size
//	Mainline - Schedule 40 PVC 1" unless otherwise noted
\bigcirc	Remote Control Valve - 1" - Rainbird 100 PEB and Rainbird RBY-100C Filter
EH	Emitter Header - Schedule 40 PVC 1" unless otherwise noted
\bigcirc	Pressure Regulator - Fixed Outlet Pressure @ 40 psi - flow as required
\sim	Poly line580 poly line
	Emitter Line (Trees) - Class 200 PVC - 3/4" unless otherwise noted
•	Multiport Emitter - Rainbird XBT-10-6
	Sleeves - Schedule 40 PVC - 2" unless otherwise noted
A-1	Valve ID
A	Controller - Rainbird ESP-SMT with weather sensor. Contractor to coordinate electric for the controller.
\Diamond	Hose End Caps

IRRIGATION NOTES

- Contractor shall coordinate electrical power supply for irrigation controller. Contractor shall provide sleeves for remote control valve wires.
- 2. Irrigation plans are schematic. Locate lines and equipment in unpaved areas wherever possible.
- 3. Locate weather sensor so it is unimpeded by any structural elements.
- 4. Shrubs shall have (1) 1-gph emitter per 1 gallon plant and (2) 1-gph emitters per 5 gallon plant. Emitters shall be Rainbird Rainbug or approved equal.
- Irrigation is designed at a minimum pressure of 50 PSI after the backflow preventer, and a minimum available flow of 5 gpm.

DP22-xxx

IRRIGATION PLAN The Reserve at Valencia Crossing

Lots 1-50 & Common Areas "A-1"-"A-X" (Landscape, Grading, Drainage and Utilities), "B-1"-B-X" (Recreation, Landscape, Grading, Drainage and

Utilities) & "C-1" (Drainage)


A Portion of the East Half of Section 11, T-15-S, R-14-E, G&SRM, Tucson, Pima Co, AZ

35974 S. Desert Sun Drive
Tucson, AZ 85739
(520) 909-4678
gregs@grslandscapearchitects.com

ite:		🗆 Design Review
		□ Construction D
awn by:	KVP/LMW	Agency Submit
acked by		L Construction S

onstruction Documents gency Submittal onstruction Set GRS 🛛 Not for Construction

L-8 19of*22*

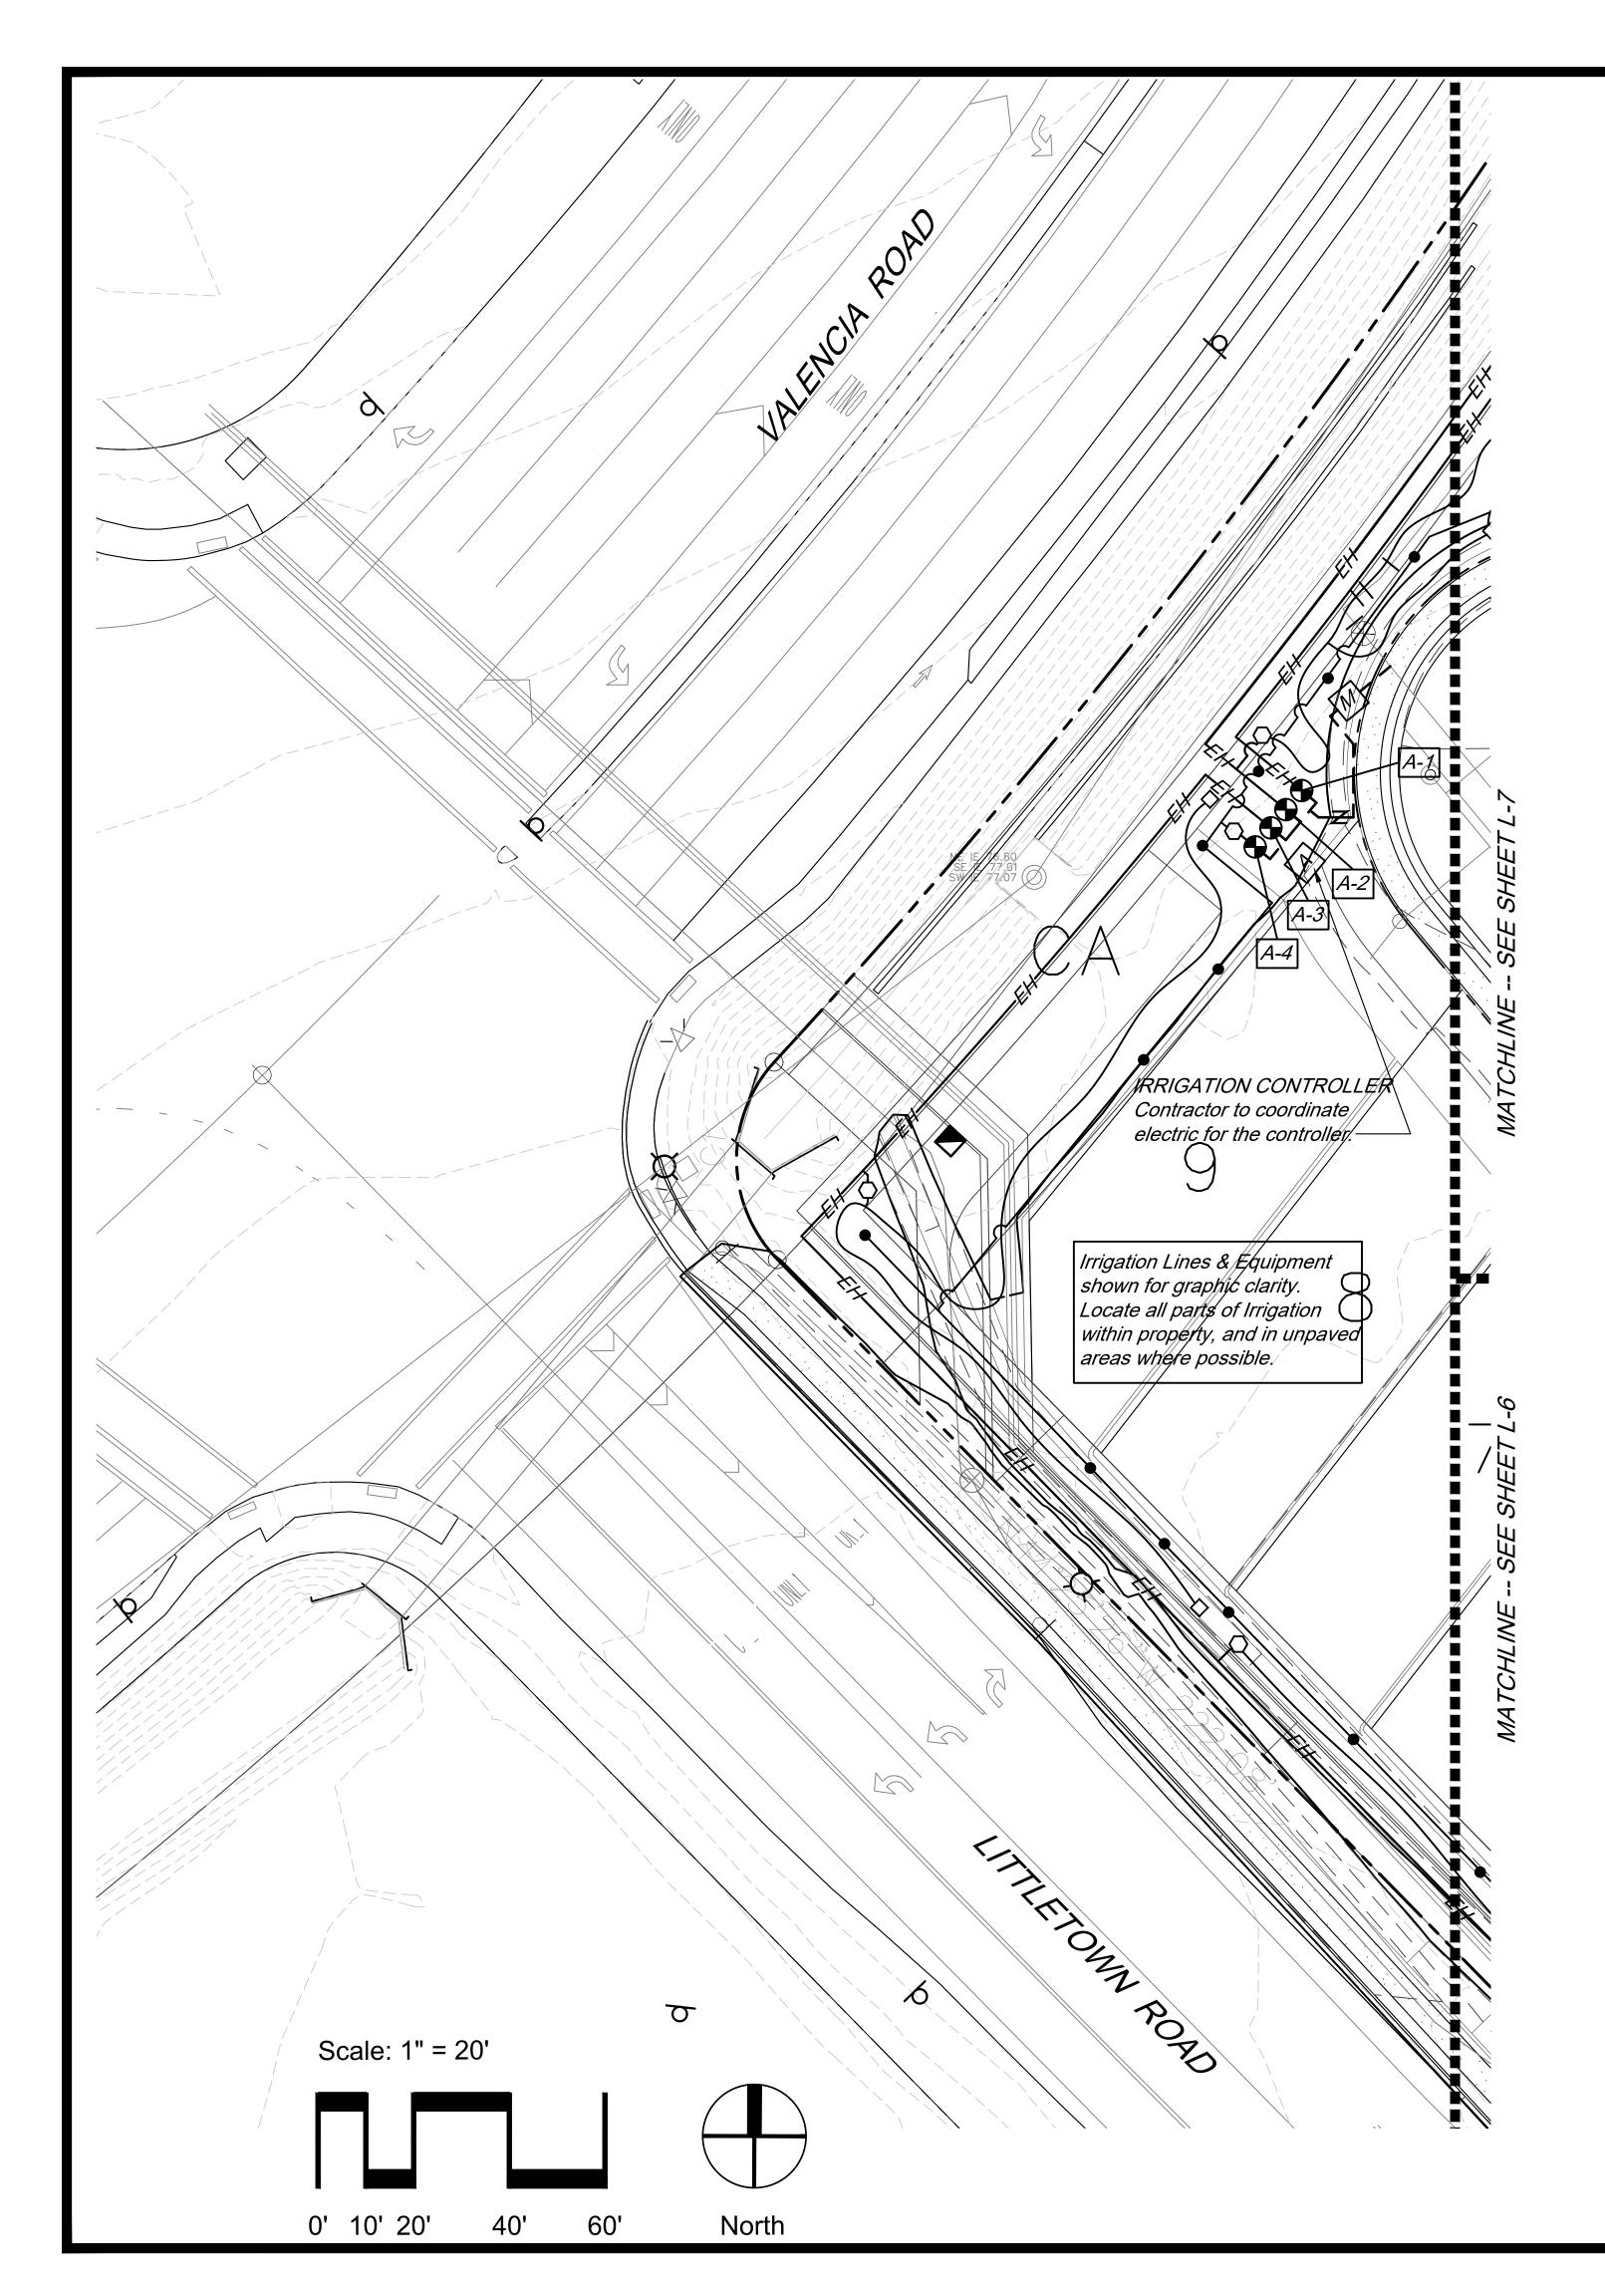

Z	Reduced Pressure Backflow Preventer, Mainline Size
//	Mainline - Schedule 40 PVC 1" unless otherwise noted
	Remote Control Valve - 1" - Rainbird 100 PEB and Rainbird RBY-100C Filter
EH	Emitter Header - Schedule 40 PVC 1" unless otherwise noted
\bigcirc	Pressure Regulator - Fixed Outlet Pressure @ 40 psi - flow as required
\sim	Poly line580 poly line
	Emitter Line (Trees) - Class 200 PVC - 3/4" unless otherwise noted
•	Multiport Emitter - Rainbird XBT-10-6
	Sleeves - Schedule 40 PVC - 2" unless otherwise noted
A-1	Valve ID
A	Controller - Rainbird ESP-SMT with weather sensor. Contractor to coordinate electric for the controller.
\diamond	Hose End Caps

IRRIGATION NOTES

- 1. Contractor shall coordinate electrical power supply for irrigation controller. Contractor shall provide sleeves for remote control valve wires.
- 2. Irrigation plans are schematic. Locate lines and equipment in unpaved areas wherever possible.
- 3. Locate weather sensor so it is unimpeded by any structural elements.
- 4. Shrubs shall have (1) 1-gph emitter per 1 gallon plant and (2) 1-gph emitters per 5 gallon plant. Emitters shall be Rainbird Rainbug or approved equal.
- Irrigation is designed at a minimum pressure of 50 PSI after the backflow preventer, and a minimum available flow of 5 gpm.



DP22-xxx

IRRIGATION PLAN The Reserve at Valencia Crossing

Lots 1-50 & Common Areas "A-1"-"A-X" (Landscape, Grading, Drainage and Utilities), "B-1"-B-X" (Recreation, Landscape, Grading, Drainage and

Utilities) & "C-1" (Drainage)


A Portion of the East Half of Section 11, T-15-S, R-14-E, G&SRM, Tucson, Pima Co, AZ


35974 S. Desert Sun Drive Tucson, AZ 85739 (520) 909-4678 gregs@grslandscapearchitects.com


– 🗆 Design Review 1/12/22 \Box Construction Documents Drawn by: KVP/LMW Agency Submittal Checked by:


GRS 🛛 Not for Construction


L-9 *20* of *22*

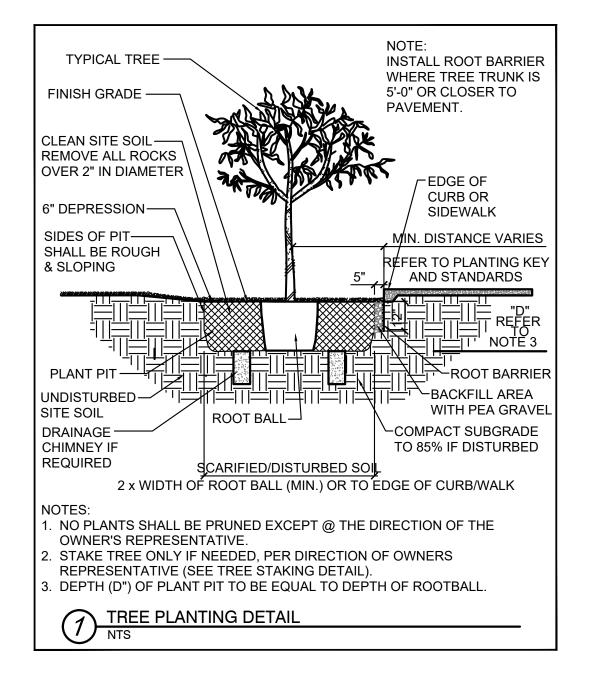


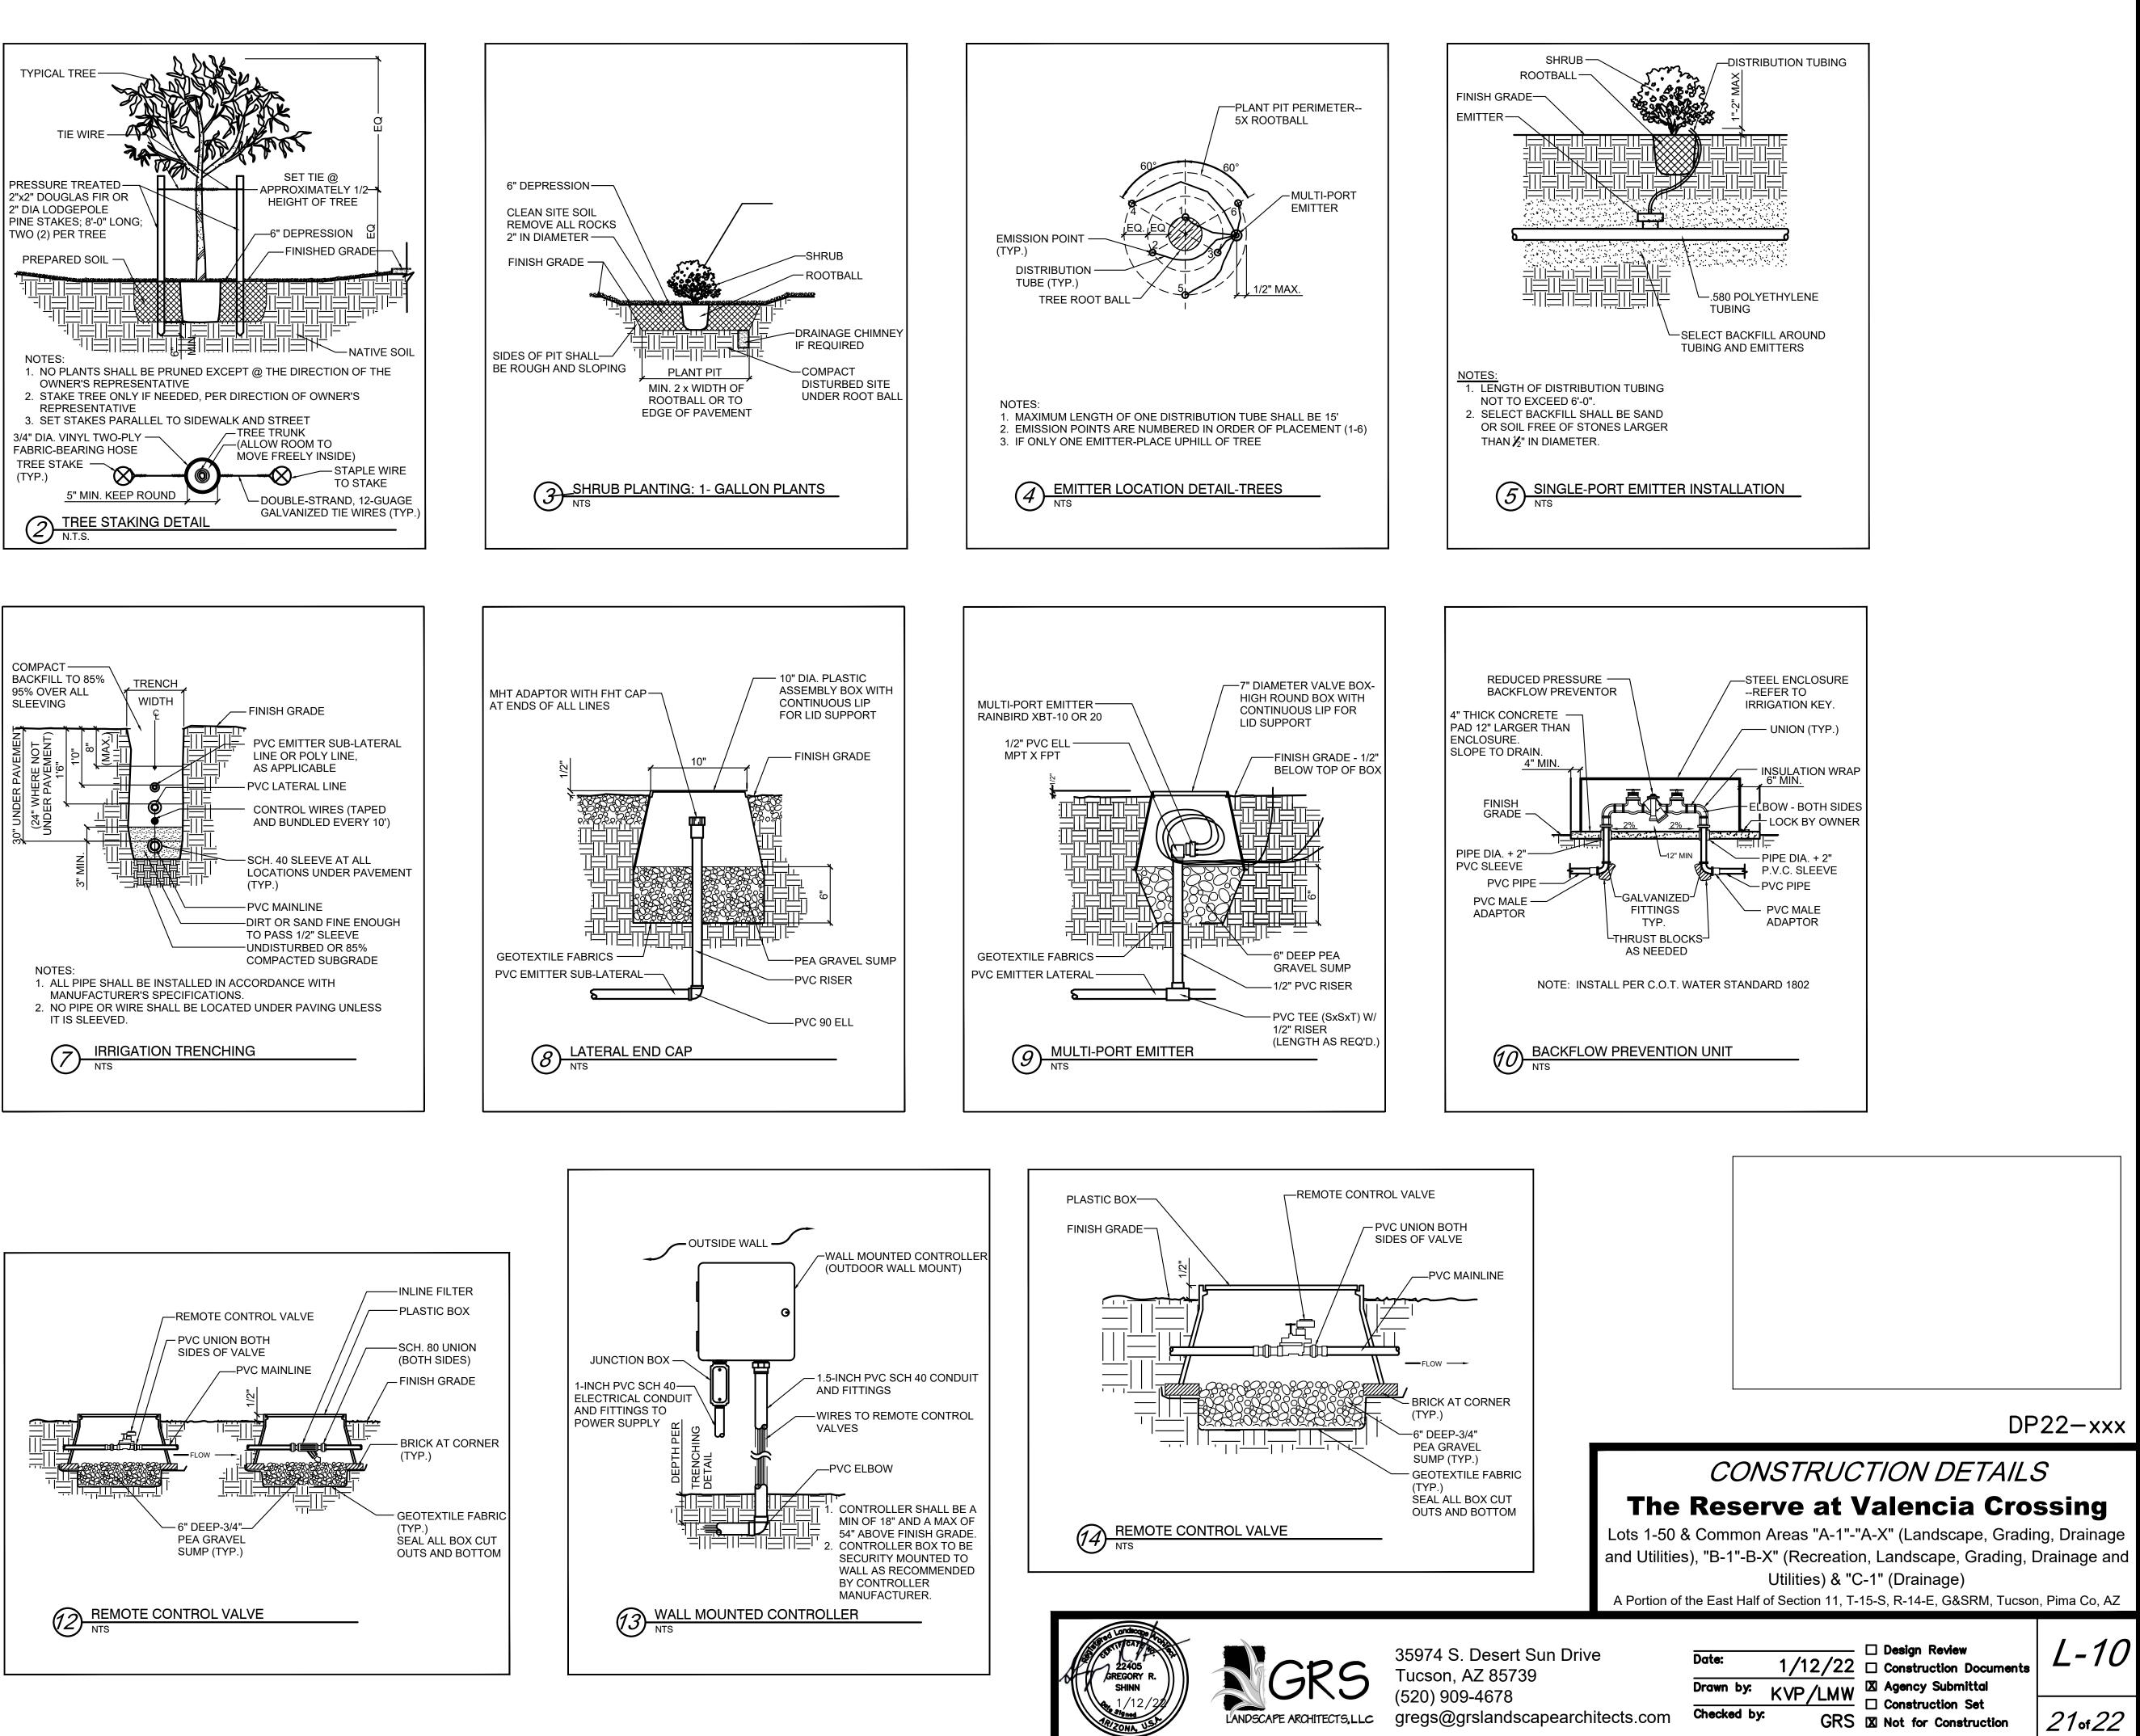

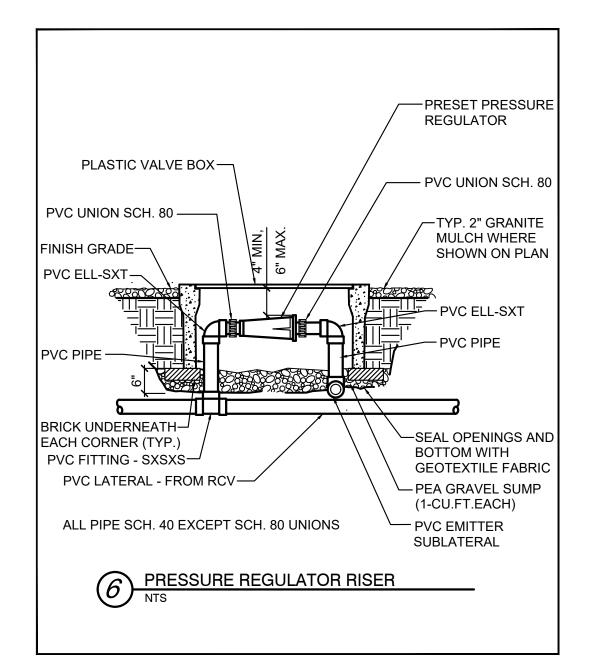


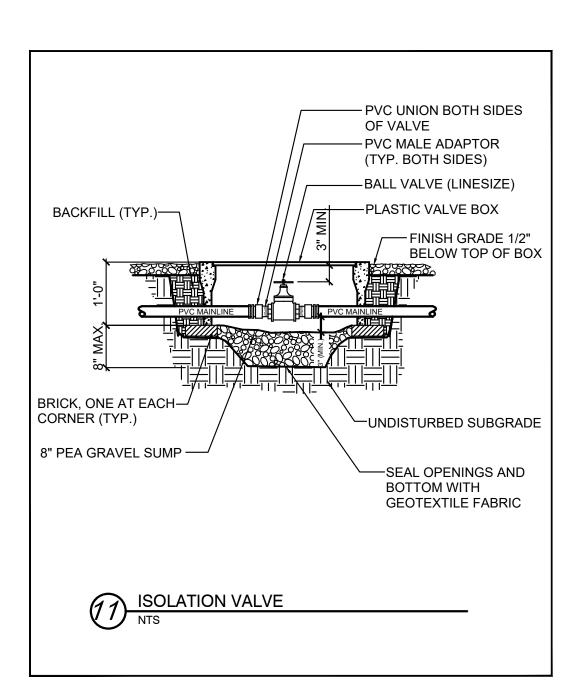

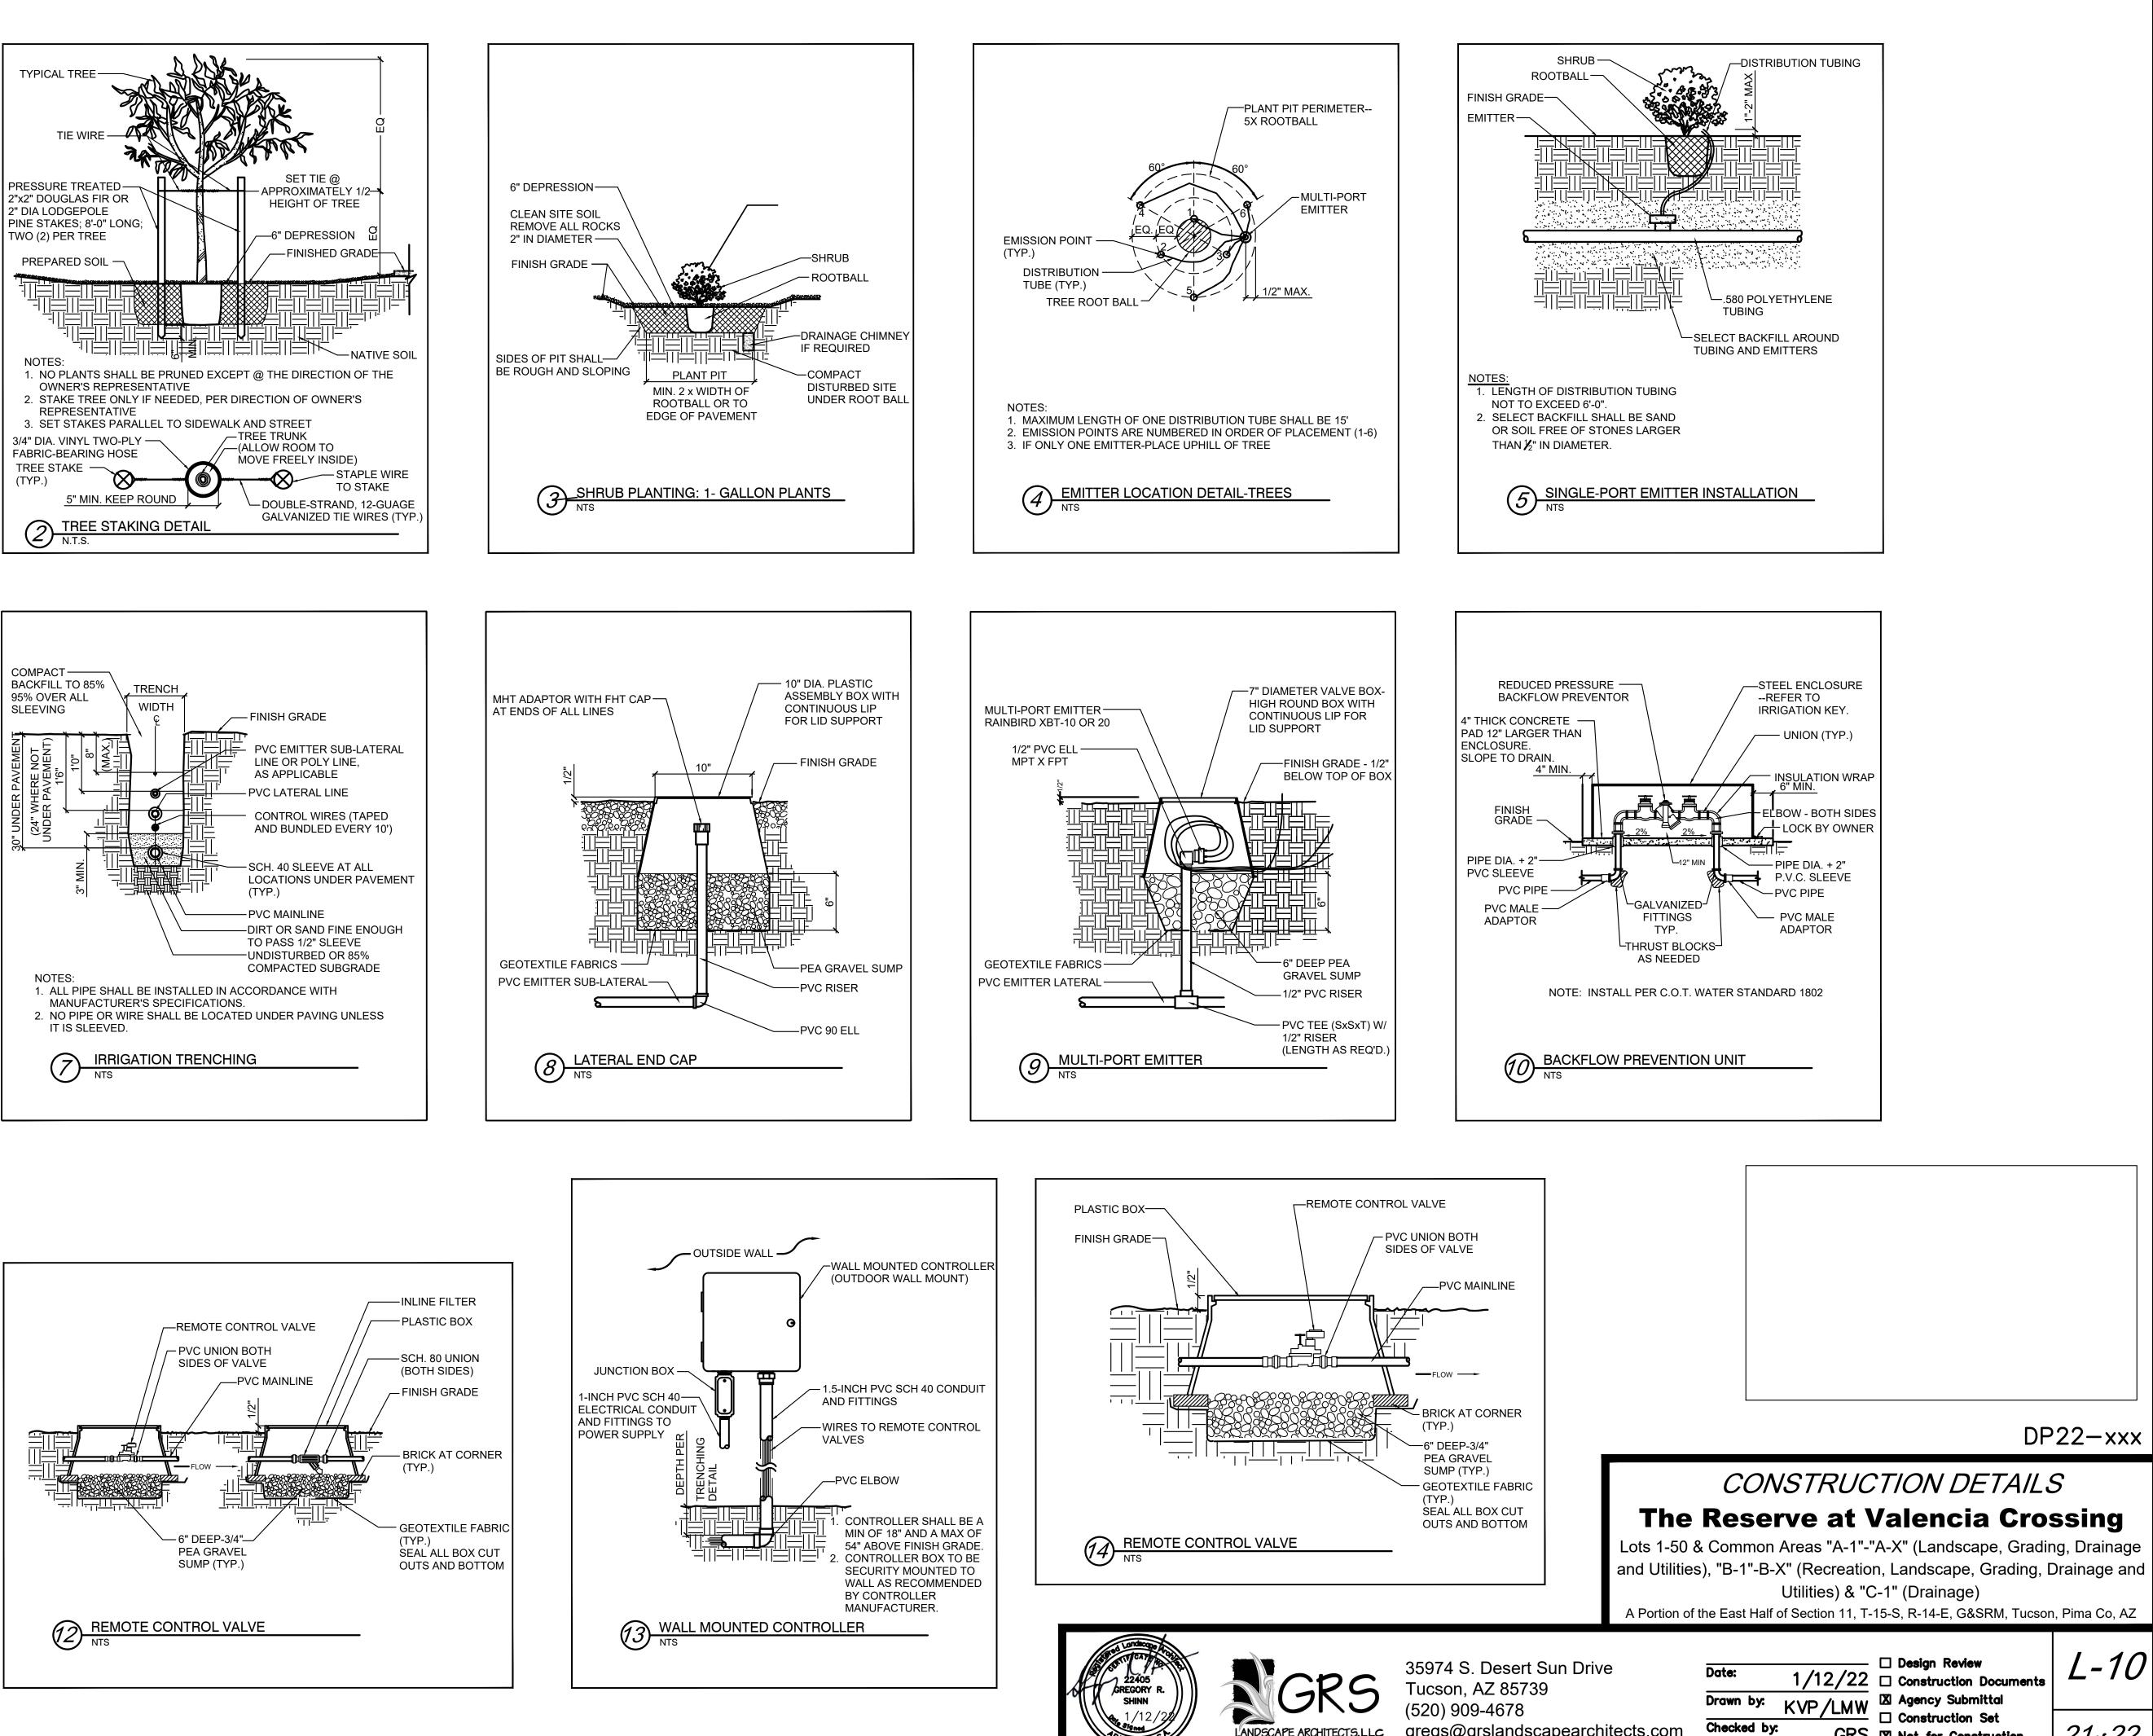

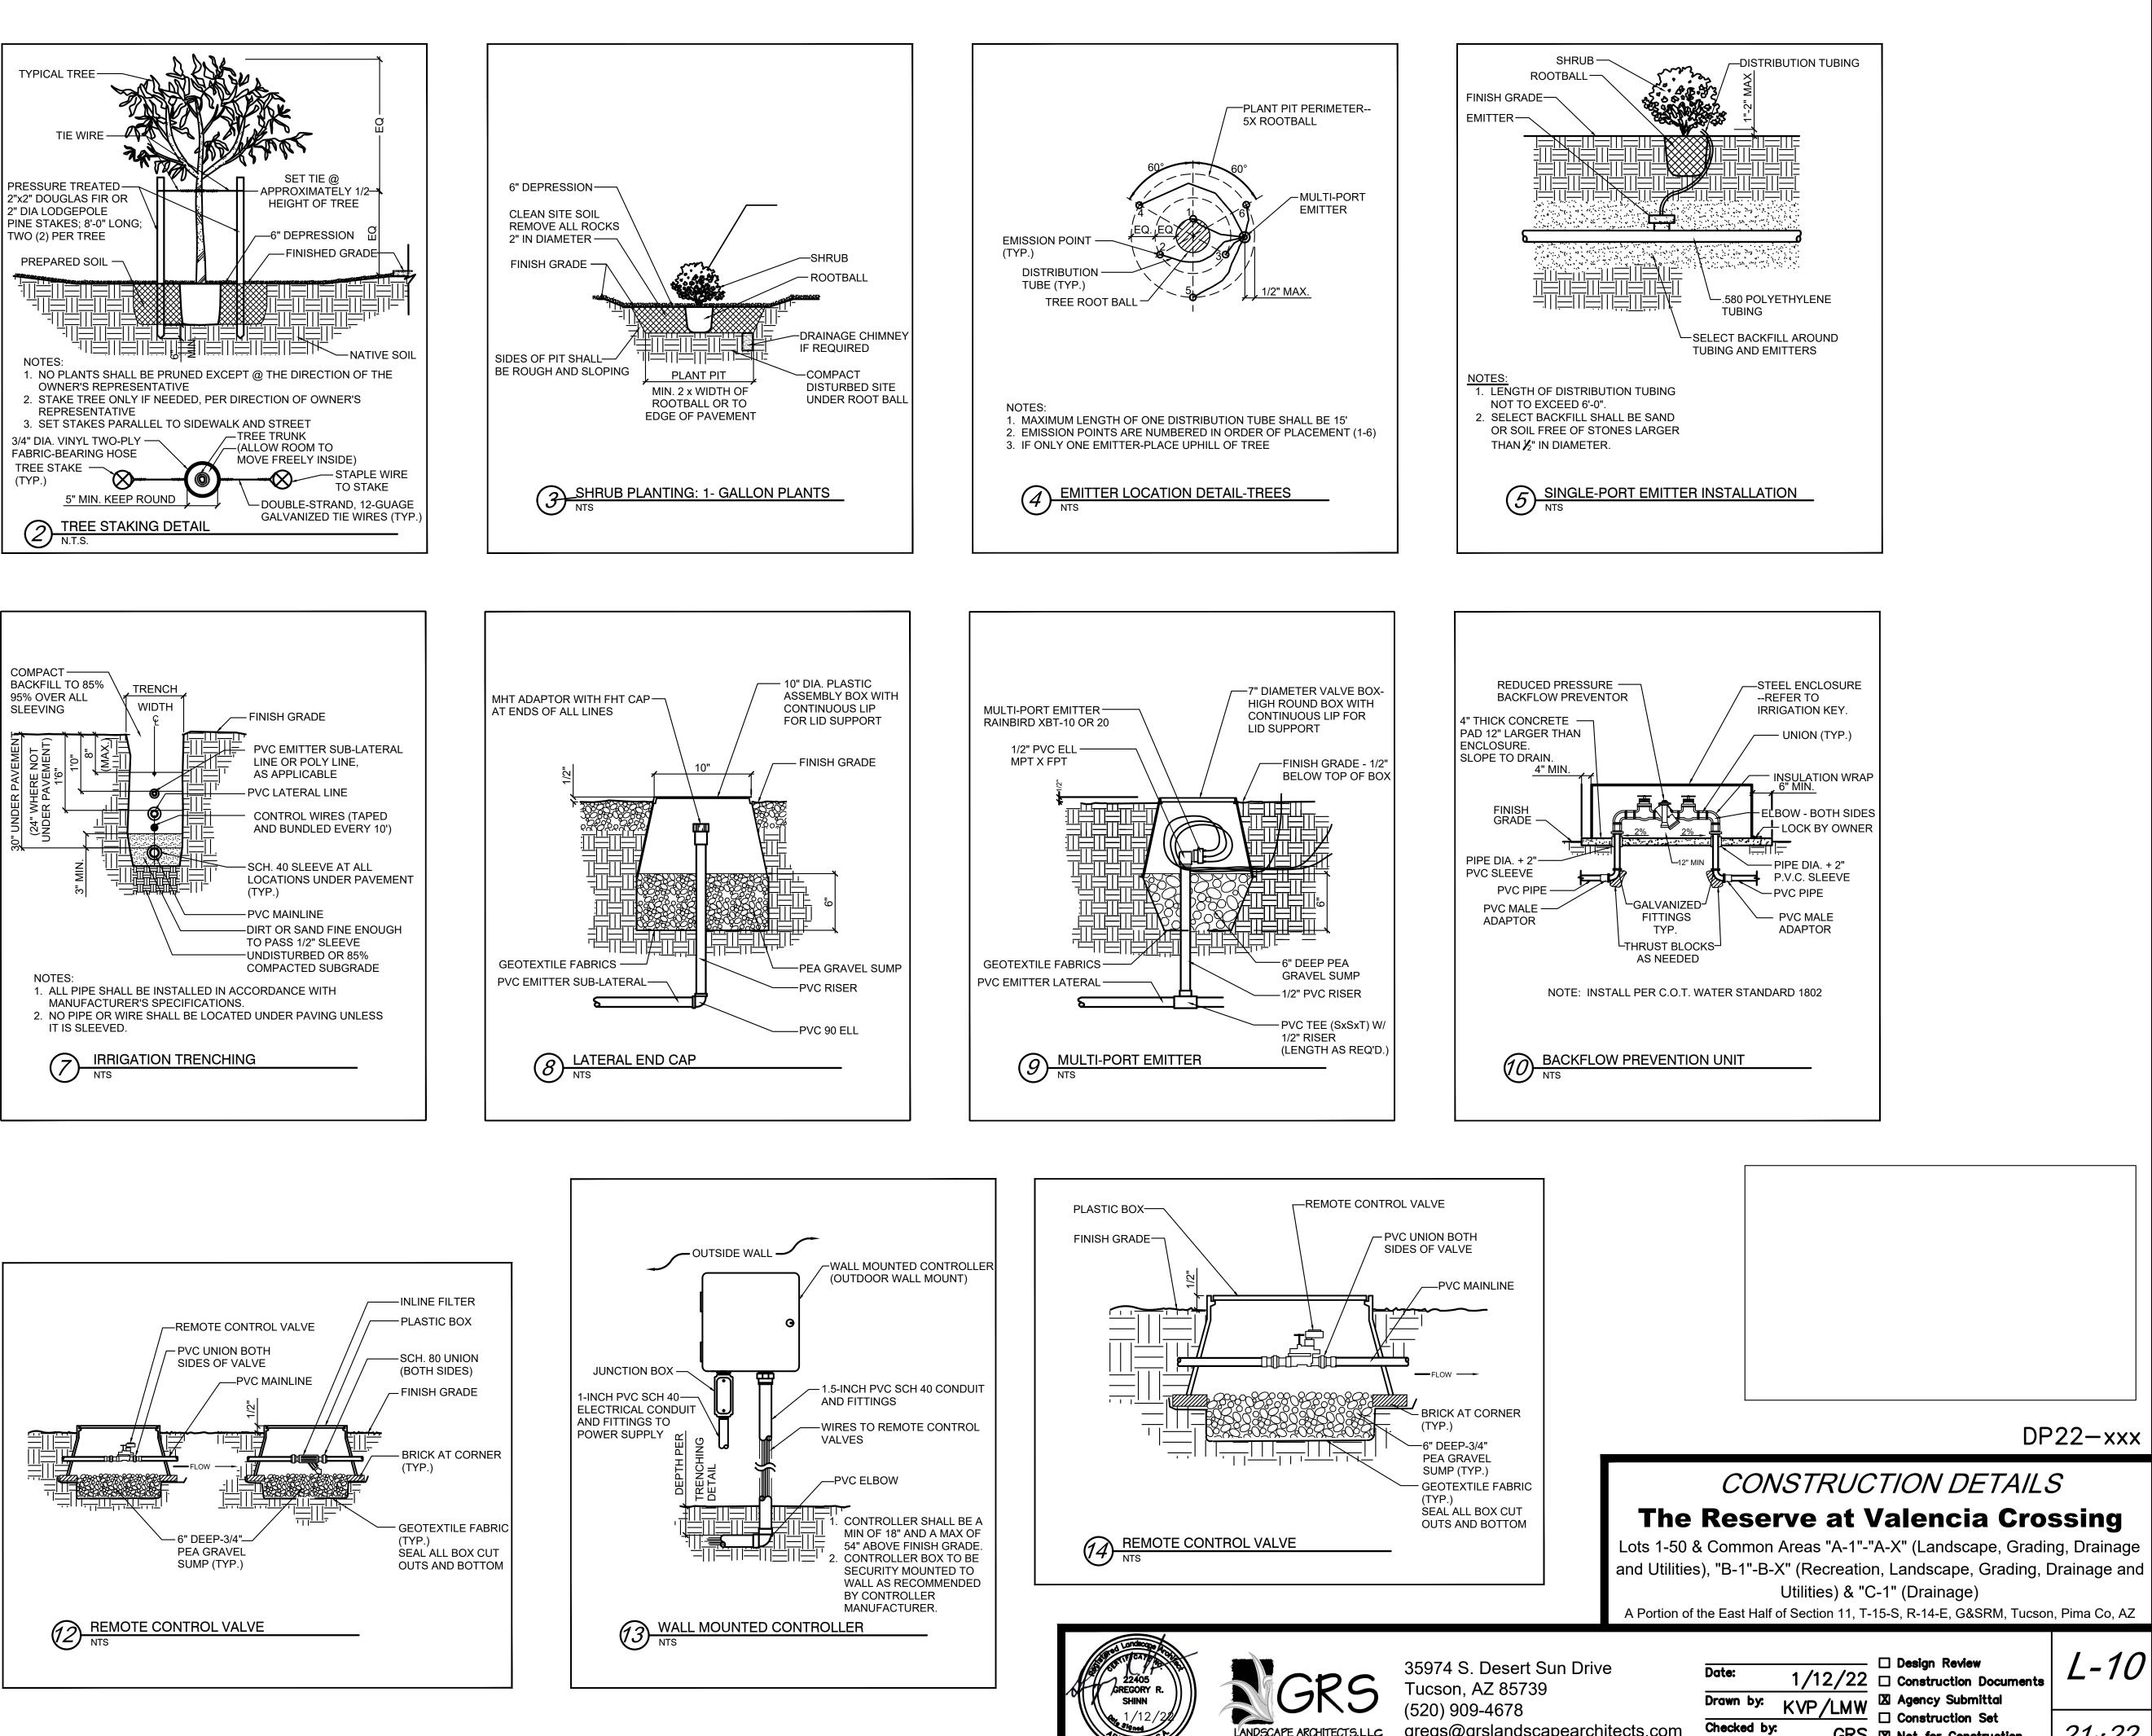


Expires 6-30-2022

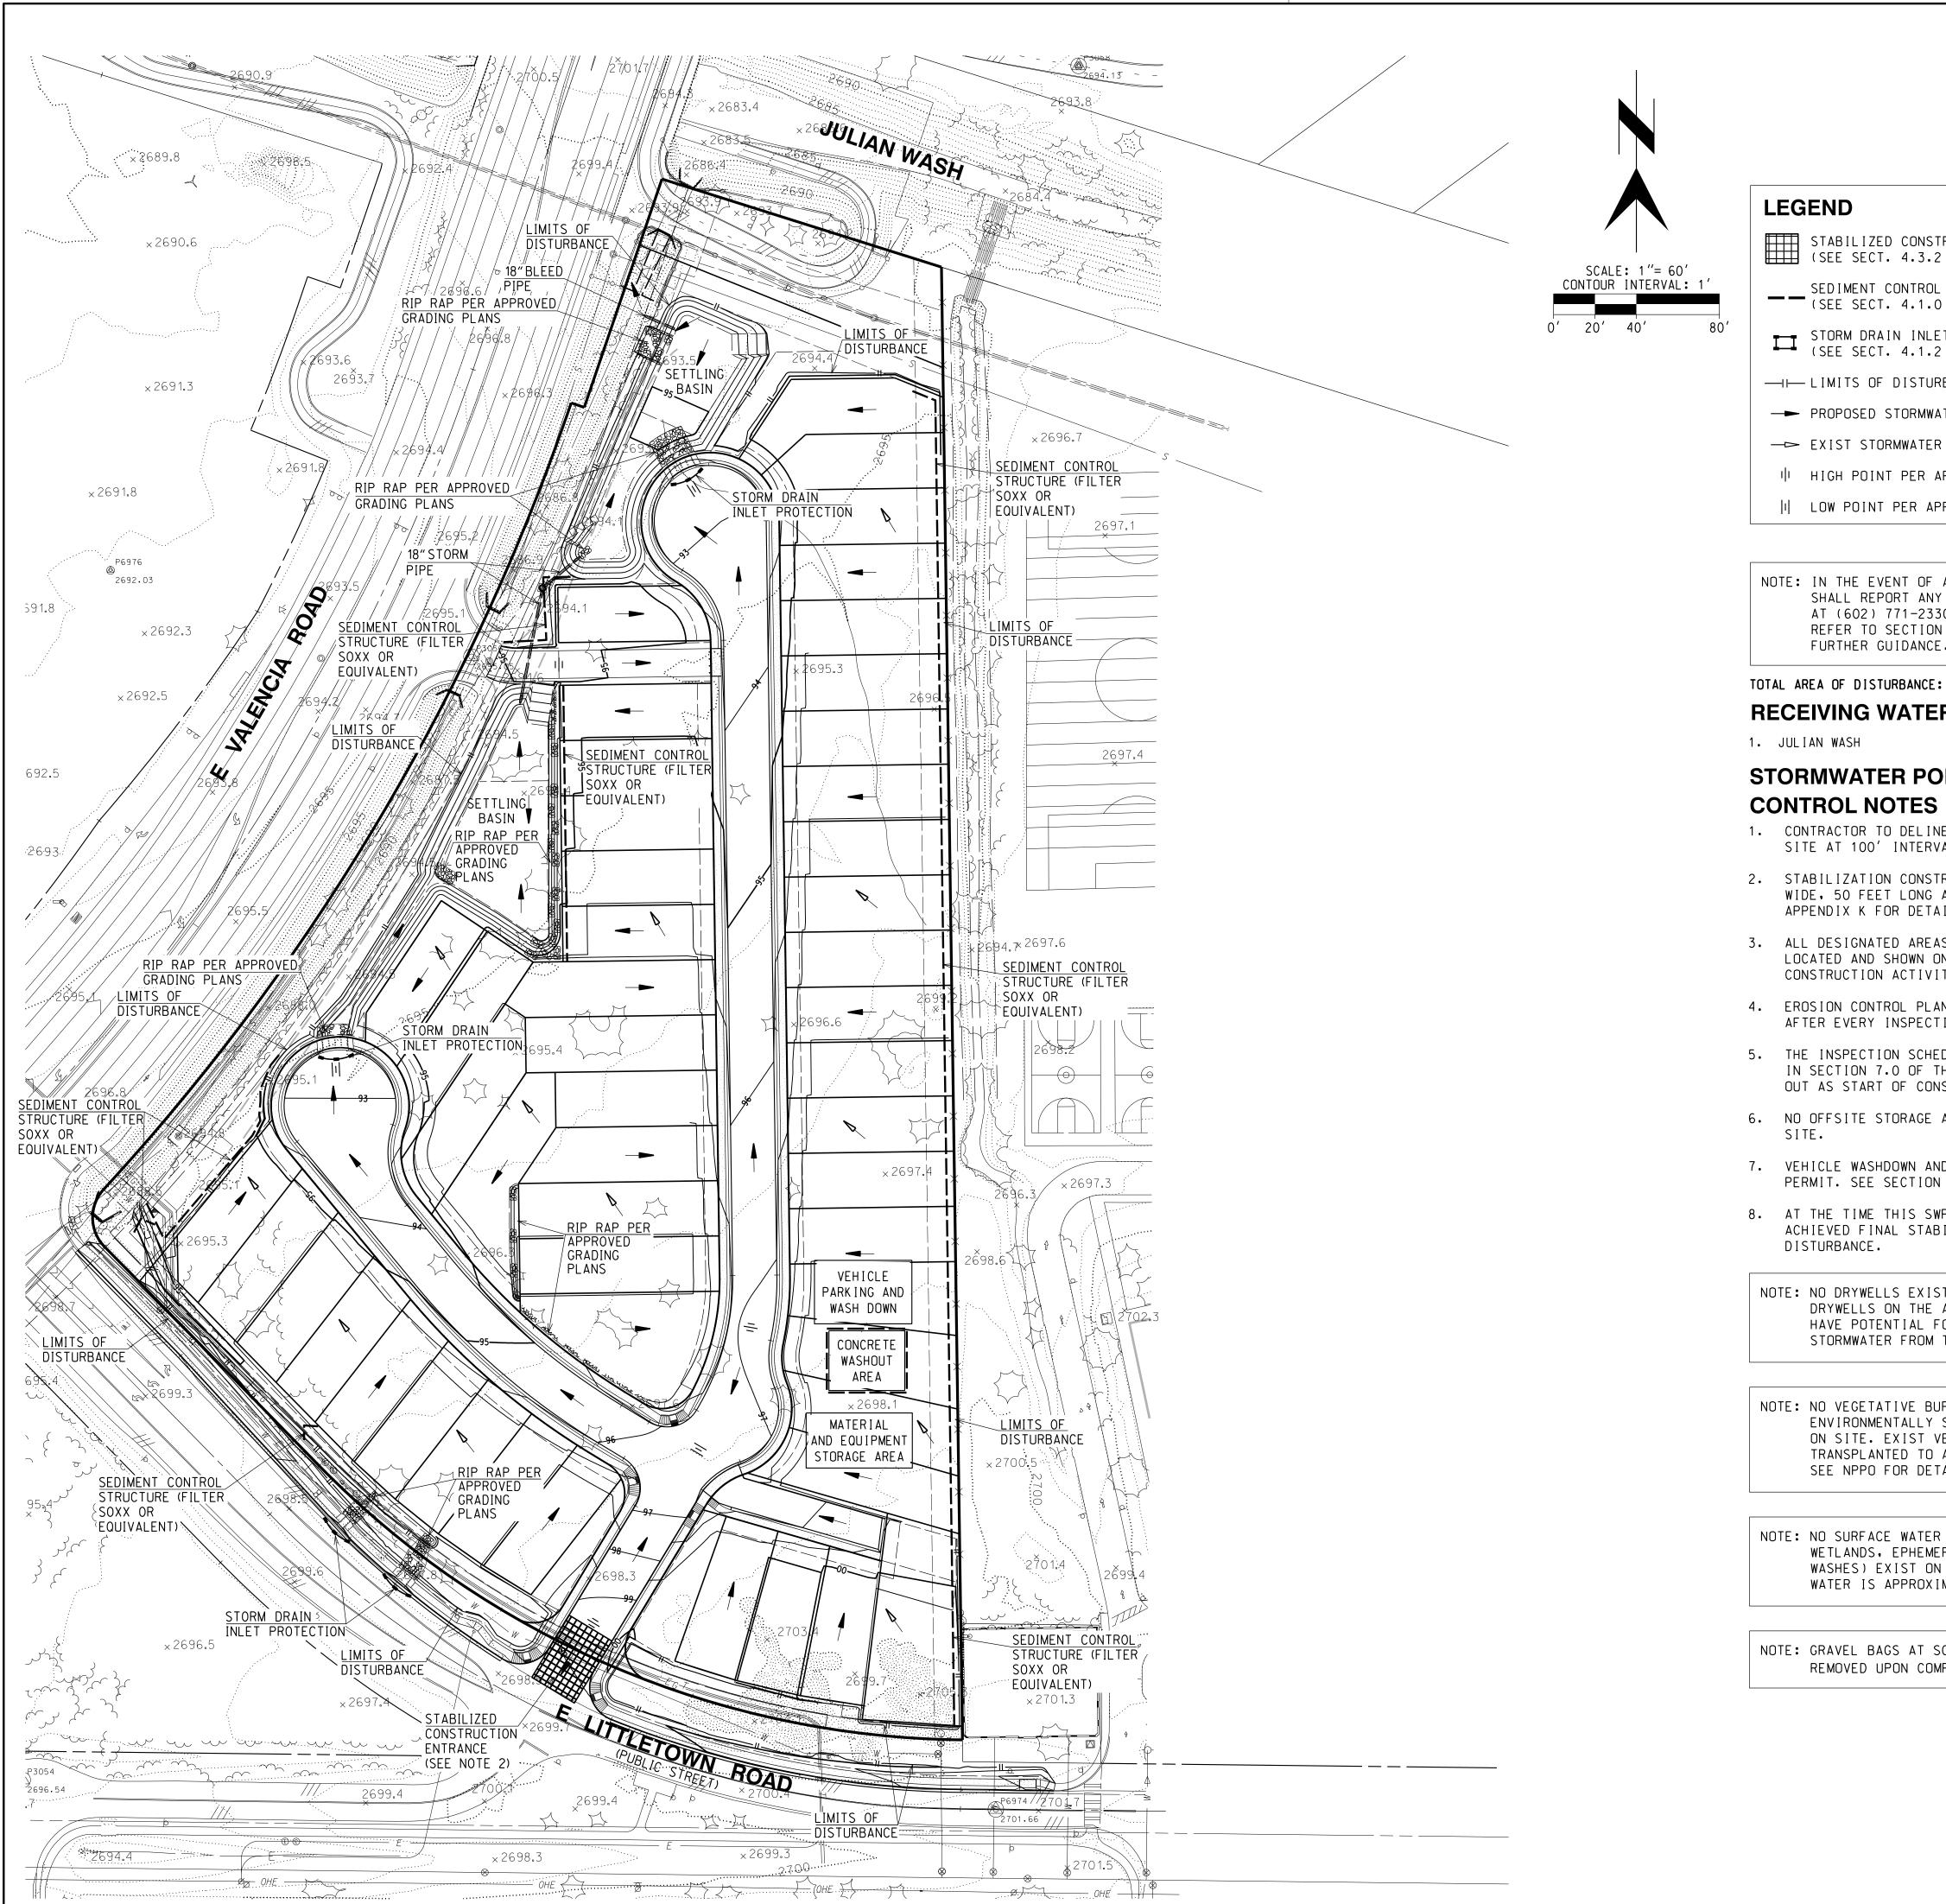

C:\RICK\Projects\T_TUC_F\Valencia_Crossing\5141_Littletown_Parcel\Civil\TUC_CorpStds_2005.dscript

		APPR DATE
	SCALE: 3" = 1 MILE THIS PROJECT	
TRUCTION ENTRANCE 2 & APPENDIX I) L STRUCTURE O - 4.1.2, & APPENDIX I) ET PROTECTION 2 & APPENDIX I) RBANCE	PROJECT 10 11 C.O.T. 15 14 PIMA VALENC COUNTY 59-92 55-51 LOCATION MAP SECTION 11, T 15 S, R 14 E G & SRM CITY OF TUCSON WARD #5 PIMA COUNTY, ARIZONA	REVISION
ATER FLOW R FLOW APPROVED GRADING PLANS PPROVED GRADING PLANS		NO. BY DATE
A SPILL, THE OPERATOR Y NONCOMPLIANCE TO ADEQ 30 OR FAX (602) 771-4505. N 7 OF THE REPORT FOR E.		PAUL J. S. M. M. J. S. M. M. J. S. M. M. M. S. M.
E: 9.1 AC ERS		J-5141B gineering.com Phoenix - Denver : 12/21
OLLUTION S NEATE GRADING LIMITS BY FLAGGIN VALS.	G	ITE 111 rickengi p. San Luis Obispo - Pł PJI DATE: PJI DATE:
TRUCTION ENTRANCE SHALL BE 30 F AND 6 INCHES DEEP. (SEE AILS.)	Т	FORT LOWELL ROAD - SUITE 111 AZ 85712 000
AS SUBJECT TO CHANGE ARE TO BE ON FIGURE 4-1 BEFORE START OF ITY.		EAST FORT LOV DN, AZ 85712 95-1000 30 - Riverside - C
AN, FIGURE 4-1, SHALL BE UPDATE TION. EDULE TO BE FOLLOWED IS LOCATED THE SWPPP, AND SHOULD BE FILLED NSTRUCTION ACTIVITIES. AREAS ARE REQUIRED FOR THIS		IOUN 3945 EAST TUCSON, J TUCSON, J INEERING COMPANY 520-795-10 San Diego - San Diego - VED BY: BNC DATE: I BY: RSM DATE: 12/21
ND CONCRETE WASHOUT PER SEPARAT N 4.3 & APPENDICES C & D. WPPP WAS PREPARED, NO AREAS HAV		P ENGINER Tucson DESIGNED DRAWN BY
BILIZATION WITHIN THE LIMITS OF ST ON SITE, AND NO ADJACENT PROPERTIES FOR RECEIVING THIS SITE.		SWPPP SWPP SWPP SWPP SWPP SWP SWP SWP SW
UFFER ZONES OR SENSITIVE AREAS EXIST VEGETATION WILL BE AN ON SITE LOCATION. TAILS.		ESERVE CRVE AREAS "A" (LANDS D ACCESS), "B-1"-' ALT RIVER MERIDIAN, P
R BODIES (INCLUDING ERAL WATERS, AND DRY N SITE. THE RECEIVING IMATELY 0.0 MILES NORTH.		T PACKAGE T PACKAGE E B B B B C PACKAGE & COMMON AF UTILITIES AND G, DRAINAGE / UC THE EAST HAL I OF THE EAST HAL
SCUPPER INLETS ARE TO BE MPLETION OF THE PAVING.	RELATED CASES: C9-12-03, C15-12-01	DE VEL OPMENT
		$P22AD00XXX$ $P22WS000XX$ $DP22-0XXX$ $S_{C_{A}}$ HORIZ: 1" = 60'
1_Littletown_ParceNCiviN5141Bdp22。		A E VERT : N/A SHEET 22 OF 22 14-JAN-2022 11:50

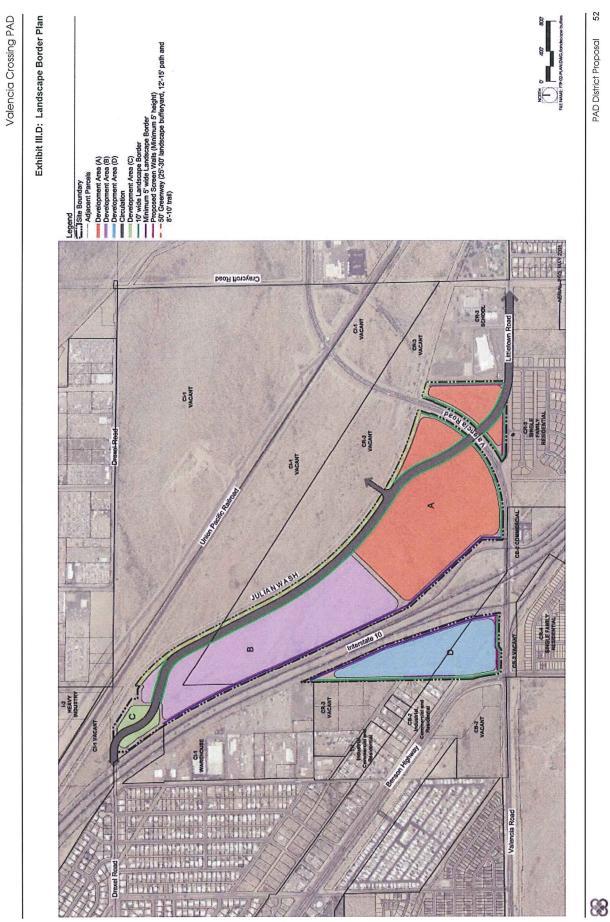

Lexy Wellott

From:	Lee, Kelly <kelee@kbhome.com></kelee@kbhome.com>
Sent:	Friday, December 10, 2021 9:46 AM
То:	Lexy Wellott
Subject:	Fwd: Valencia Crossing Minor PAD Amendment

Get Outlook for iOS




Built on Relationships[•]

From: Anne Warner <Anne.Warner@tucsonaz.gov>
Sent: Friday, December 10, 2021 9:11:31 AM
To: Grslar <Grslar@aol.com>
Cc: Lee, Kelly <kelee@kbhome.com>
Subject: Valencia Crossing Minor PAD Amendment

EXTERNAL EMAIL: Do not click links or open attachments unless you recognize the source of the email.

Greg -

I am in support of your request for a plan amendment because requiring a 10' landscape border on the east boundary would result in a tunnel between the two uses, creating an unsafe situation, disregarding the principals of Safe by Design. (see drawing for illustration). Further, there are existing mature trees on the school's property along most of this boundary that provide visual relief. I recommend that the landscape required for this border be planted in a more appropriate location on the project site, including adding trees to the southeast (blue arrow).

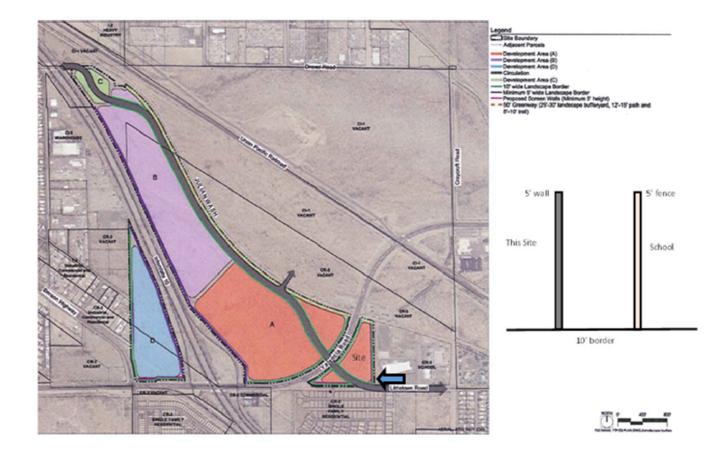

Anne Warner, RLA, MEd., Planner <u>anne.warner@tucsonaz.gov</u> Planning and Development Services City of Tucson February 17, 2022

City of Tucson Planning and Development Services Department 201 North Stone Avenue Tucson, AZ 85701

Subject: Valencia Crossing PAD – Minor Amendment Request Tax Parcels: 140-36-005C

City of Tucson Development Services Department:

As the representative of above-referenced tax parcel, I hereby authorize The Planning Center and KB Home - Tucson to act as our agents throughout the PAD amendment application process.

Sincerely,

Valencia Crossing Long Term Investment Company, LLC By: Desert Parcel 510 Associates, LLC Its: Sole Member

By: Parcel 510, Inc. Its: Authorized Member

Mr. Robert Morken, President

140-36-005C VALENCIA CROSSING LONG TERM INVESTMENT CO LLC ATTN: DESERT PARCEL 510 ASSOCIATES LLC ROBERT MORKEN 2200 E RIVER RD STE 105 TUCSON AZ 85718-6516