

baylor residence

492 S Convent Ave, Tucson, AZ 85701

GENERAL CONDITIONS:

SITE PLAN

SCALE 1:200

TOTAL EXISTING SQ FT: 2322 SQ FT

TOTAL REMAINING EXISTING: 1724 SQ FT

NEW TOTAL SQ FT: 1871 SQ FT

LEGEND:

PROPOSED DEMOLITION OF EXISTING 598 SQ FT

PROPOSED DEMOLITION OF EXISTING 598 SQ FT

REMODEL OF EXISTING ADOBE— BED 371 SQ FT

147 SQ FT

147 SQ FT

286 SQ FT

147 SQ FT

FRAME CONSTRUCTION ADDITION

ADD TOTAL OF NEW ADDITION

FRAME CONSTRUCTION ADDITION

PROPOSED TOTAL REMODEL OF EXISTING ADOBE STRUCTURES NEW KITCHEN=286 SQ FT NEW BATHROOM=147 SQ FT

TOTAL SQ FT OF REMODEL PLUS ADDITION= 804 SQ FT

RELOCATE KITCHEN

NEW CMU BATHROOM

PROPOSED NEW STRUCTURE

- ALL CONSTRUCTION SHALL CONFORM TO I.R.C. 2018 AND APPLICABLE LOCAL CODES AND REGULATIONS AND 2018 I.B.C. FOR ENGINEERED STRUCTURAL
- CONTRACTOR SHALL VERIFY ALL DIMENSIONS AND CONDITIONS AT JOB SITE BEFORE COMMENCING WORK AND SHALL REPORT ANY DISCREPANCIES TO
- 3. OMMISSIONS OR CONFLICTS BETWEEN VARIOUS ELEMENTS OF THE DRAWINGS, NOTES AND DETAILS SHALL BE BROUGHT TO THE ATTENTION OF THE ARCHITECT AND RESOLVED BEFORE PROCEEDING WITH THE WORK.
- DO NOT SCALE DRAWINGS. USE WRITTEN DIMENSIONS, OR WHERE NO DIMENSION IS PROVIDED, CONSULT WITH THE ARCHITECT FOR CLARIFICATION.
- DETAILS SHOWN SHALL BE INCORPORATED INTO THE PROJECT AT ALL APPROPRIATE LOCATIONS WHETHER SPECIFICALLY CALLED OUT OR NOT.
- REFER TO STRUCTURAL, MECHANICAL, PLUMBING AND ELECTRICAL FOR LOCATION AND SIZE OF BLOCK-OUTS, INSERTS AND OPENINGS, CURBS, BASES AND PADS AND DIMENSIONS NOT SHOWN ON ARCHITECTURAL DRAWINGS.
- GENERAL CONTRACTOR/PLUMBING SUBCONTRACTOR TO PROVIDE A COMPLETELY OPERATIONAL PLUMBING SYSTEM WHETHER OR NOT ALL COMPONENTS ARE NOTED IN THESE DRAWINGS AND SHALL BE RESPONSIBLE FOR HAVING SEWER SYSTEM, EJECTION PUMP DESIGNED AND PLANNED TO CONNECT TO EXISTING SEWER SYSTEM AND THUS TO CITY LINES AND OBTAINING ALL REQUIRED APPROVALS AND PERMITS.

PIMA COUNTY CODE

- INTERNATIONAL BUILDING CODE 2018
- INTERNATIONAL RESIDENTIAL CODE 2018 INTERNATIONAL FIRE CODE 2018
- INTERNATIONAL MECHANICAL CODE 2018
- INTERNATIONAL PLUMBING CODE 2018
- FUEL AND GAS CODE 2018 - NATIONAL ELECTRIC CODE 2018

PROJECT DATA:

OWNER:

PROJECT DESCRIPTION: RESIDENTIAL

> BOLEYN BAYLOR & CLAIRE ELISABETH MC LANE 492 S CONVENT AVE TUCSON, AZ 85705-2205

JURISDICTION: CITY OF TUCSON, PIMA COUNTY, ARIZONA

HO-3 ZONING: PARCEL 117-14-2960

BUILDING CONSTRUCTION TYPE: V-PER CODE

LEGAL DESCRIPTION: TUCSON S & W PT OF LOT 4 BLK 241

HISTORIC PROPERTY(POTENTIAL ADDITIONAL TAX) PER ARS 42-12104(A) APPROX. 0.23 ACRES (9,862 SQ FT)

LOT SIZE: PROPOSED DEMO AREA: 598 GROSS SQ FT CONDITIONED

NEW 147 GROSS SQ FT CONDITIONED IS MAX 75% OF 9862 SQ FT=7396.5 SQ FT LOT COVERAGE: EXISTING LOT COVERAGE=2322 SQ FT PROPOSED AND EXISTING LOT COVERAGE

=1724 SQ FT

PROJECT TEAM:

ARCHITECT: DUST ARCHITECTS, PLC. CADE HAYES

TUCSON, ARIZONA 520.270.4205 STRUCTURAL ENGINEER:

SCHNEIDER STRUCTURAL ENGINEERS 435 E 9TH ST TUCSON, ARIZONA 85705 DAVE GIBBENS:DGIBBENS@SASTRUCTURAL.COM 520.360.6809

A2.00 DEMO PLAN & PROPOSED PLAN A3.00 BUILDING ELEVATIONS A4.00 BUILDING SECTIONS A6.00 DOOR AND WINDOW SCHEDULE S1.00 FRAMING AND FOUNDATION PLAN/DETAILS GRID LINE

ELEVATION TAG

S0.01 STRUCTURAL DETAILS E1.00 ELECTRICAL NOTES E1.01 ELECTRICAL & LIGHTING PLAN P1.00 PLUMBING PLAN M1.00 MECHANICAL PLAN

DRAWING LIST:

REVISED PER 03/03/2022 PERMIT REVIEW COMMENTS

A0.00 COVER SHEET

A1.00 SITE PLAN

SHEET NUMBER

SYMBOLS LEGEND

- DRAWING NUMBER INTERIOR ELEVATION D $\begin{pmatrix} x \\ y \end{pmatrix}$ B SHEET NUMBER - GRID NUMBER — DRAWING NUMBER DETAIL SHEET NUMBER (XXX) DOOR NUMBER DOOR X — WINDOW TYPE WINDOW —— PARTITION TYPE PARTITION TYPE DATUM CENTERLINE ALIGN MATCHLINE REVISION ---- REVISION NUMBER 1046 S Euclid Ave, Tucson, AZ 85719


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PERMIT REVIEW REVISION

Keynotes:

Consultants: Tucson, AZ 85705



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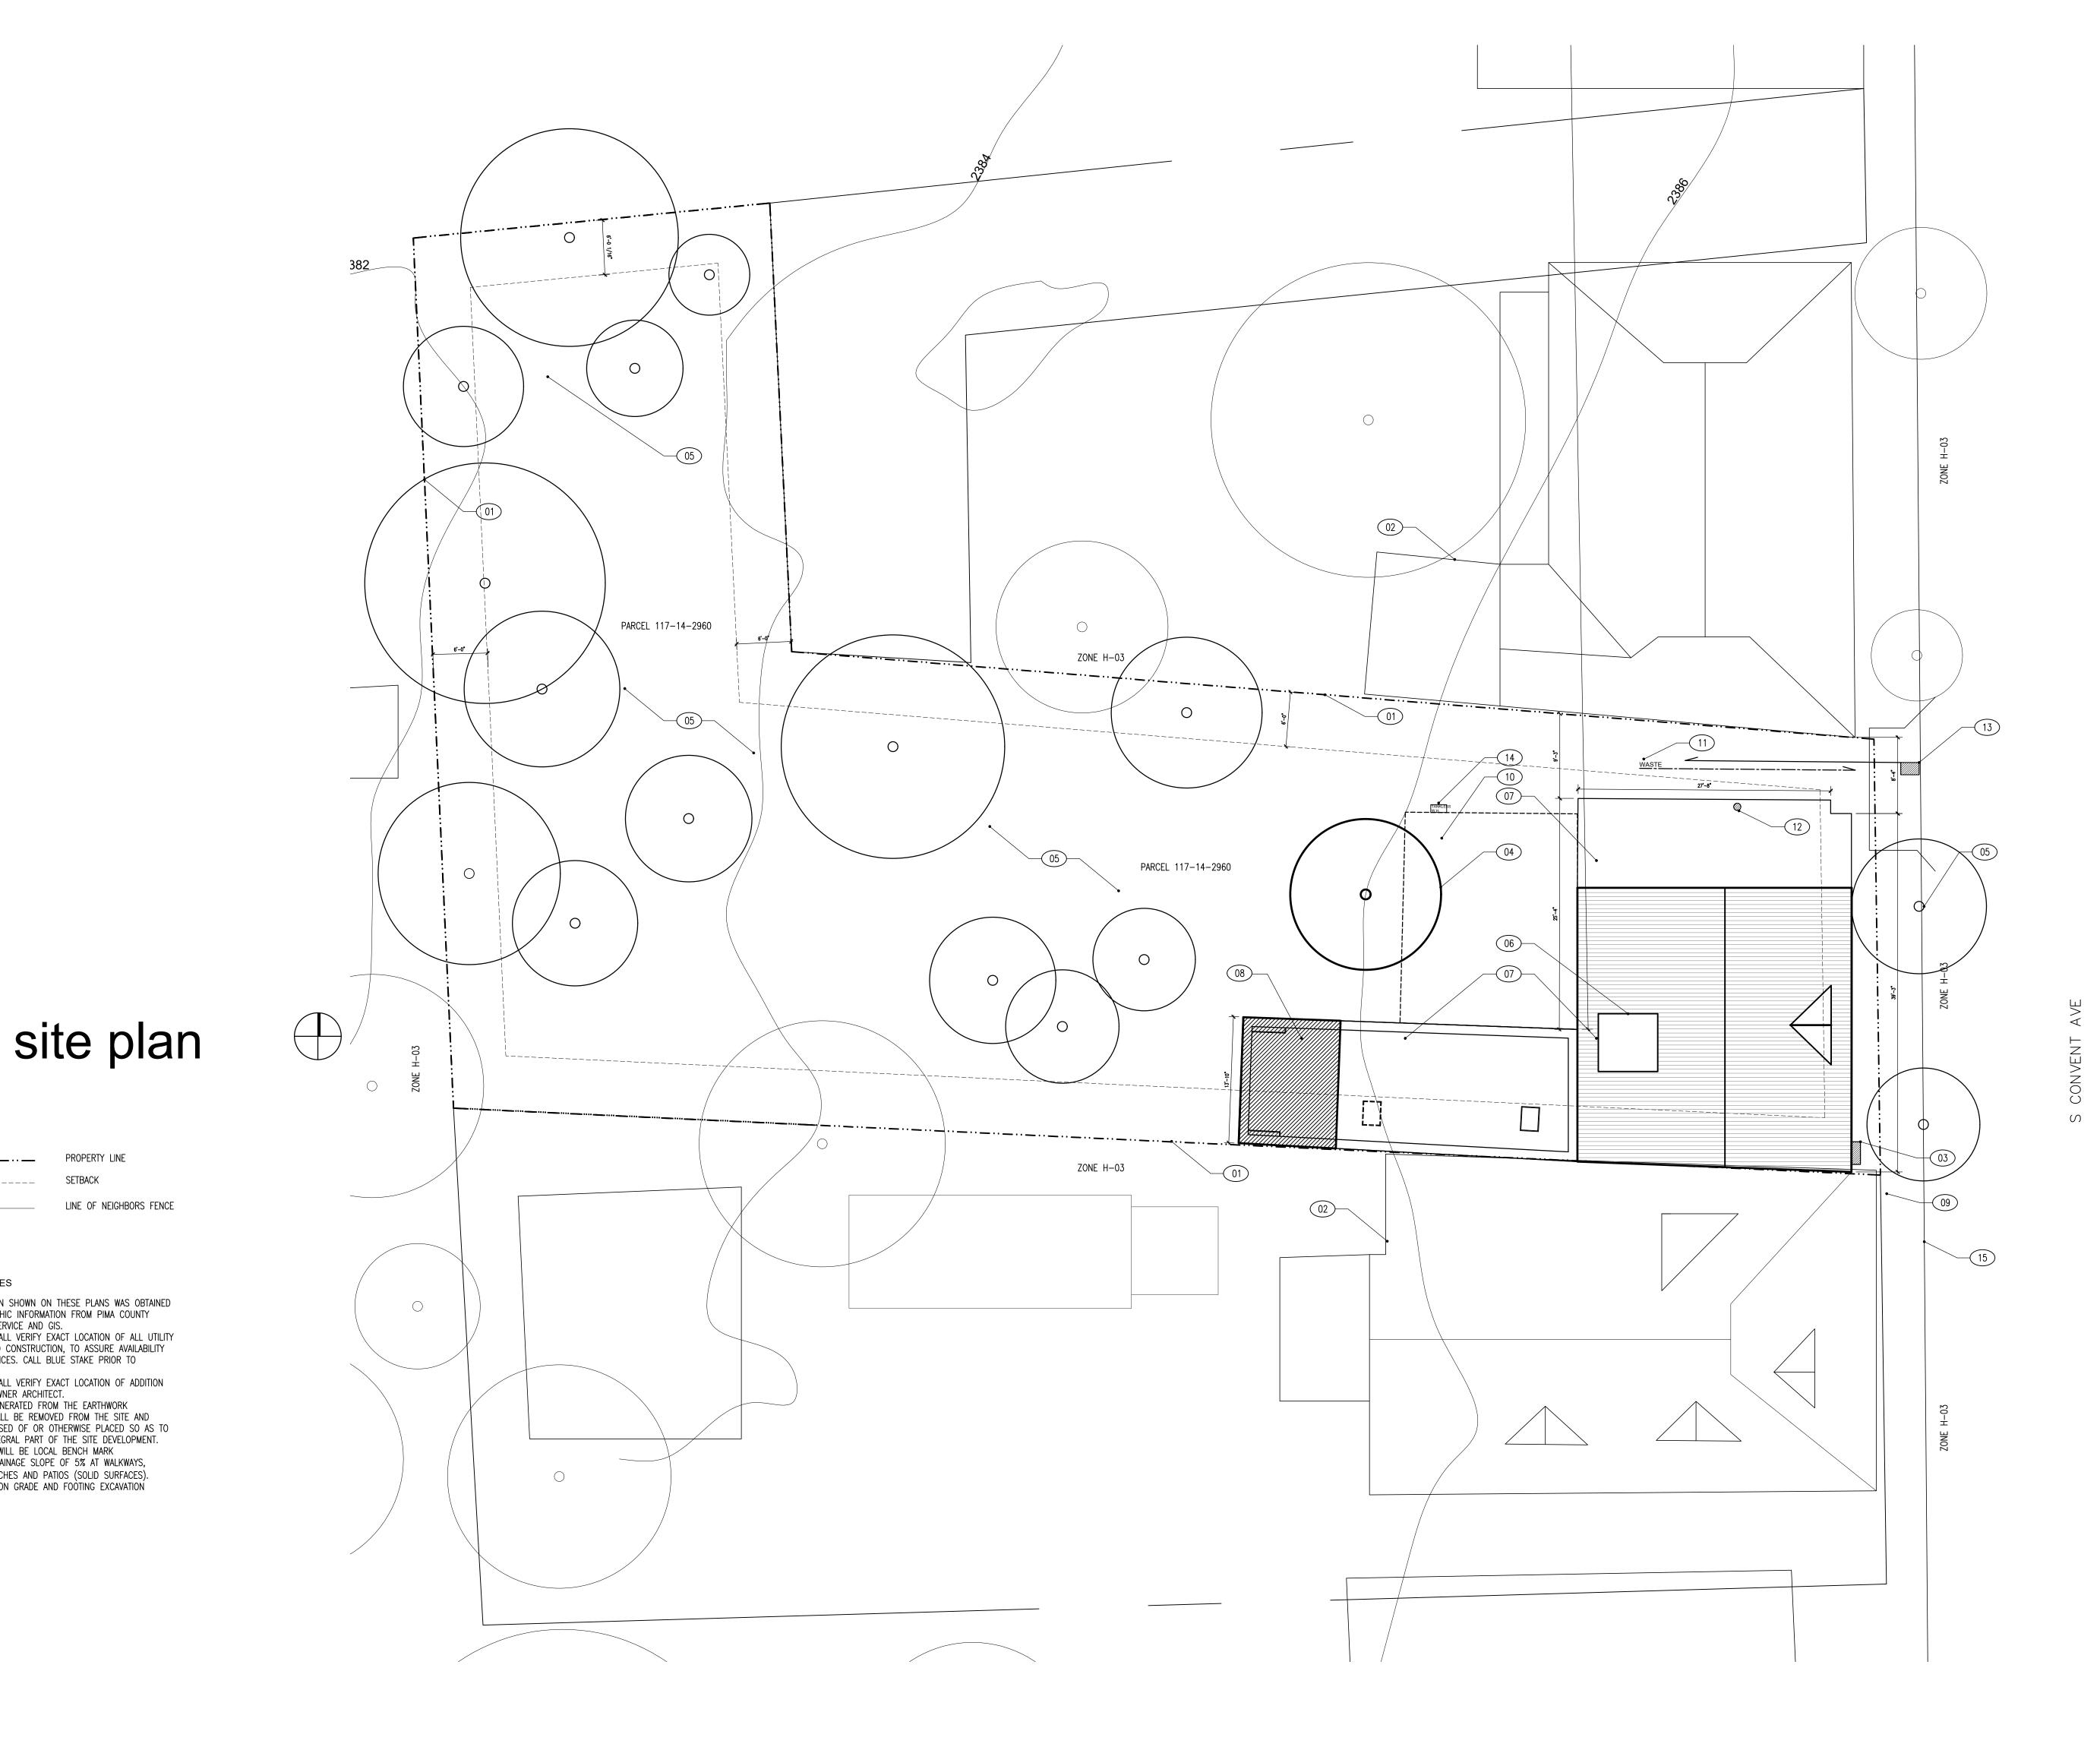
Project Name: Baylor Residence

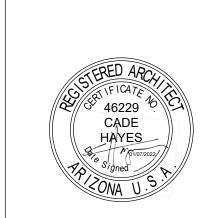1:200

492 S Convent Ave, Tucson, AZ 85701 JANUARY 07 2022 PERMIT Issued For: DUST Drawn By:

Scale: Drawing Title:

COVER SHEET



LEGEND:

__.__

GENERAL SITE NOTES

EXCAVATION.

DEVELOPMENT SERVICE AND GIS.

AT SITE WITH OWNER ARCHITECT.

SETBACK

SITE INFORMATION SHOWN ON THESE PLANS WAS OBTAINED FROM TOPOGRAPHIC INFORMATION FROM PIMA COUNTY

2. CONTRACTOR SHALL VERIFY EXACT LOCATION OF ALL UTILITY STUBS PRIOR TO CONSTRUCTION, TO ASSURE AVAILABILITY OF UTILITY SERVICES. CALL BLUE STAKE PRIOR TO

3. CONTRACTOR SHALL VERIFY EXACT LOCATION OF ADDITION

OPERATIONS SHALL BE REMOVED FROM THE SITE AND

LAWFULLY DISPOSED OF OR OTHERWISE PLACED SO AS TO BECOME AN INTEGRAL PART OF THE SITE DEVELOPMENT.

4. EXCESS SOIL GENERATED FROM THE EARTHWORK

5. EXISTING F.F.E. WILL BE LOCAL BENCH MARK

6. PROVIDE MIN DRAINAGE SLOPE OF 5% AT WALKWAYS, DRIVEWAYS, PORCHES AND PATIOS (SOLID SURFACES).

SSD FOR SLAB ON GRADE AND FOOTING EXCAVATION REQUIREMENTS.

LINE OF NEIGHBORS FENCE

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Revision:

PROPERTY BOUNDARY LINE

02 NEIGHBORS RESIDENCE

03 EXISTING ELECTRIC METER

04 NEW TREE

05 EXISTING TREES

06 EXISTING A.C. UNIT

07 EXISTING HOUSE

PROPOSED ADDITION—
147 SQ FT

09 SIDE WALK

FOOTPRINT OF DEMOLISHED FRAME ADDITION-598 SQ FT

EXISTING WASTE LINT IN YAR

EXISTING GAS LINE

EXISTING WATER SUPPLY

EXISTING HOT WATER HEATER

LINE OF CURB

Consultants: Schneider Structural Engineers 435 E. 9th Street Tucson, AZ 85705 520-429-7080

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Project Name:


Baylor Residence

492 S Convent Ave, Tucson, AZ 85701 JANUARY 07 2022

PERMIT Issued For:

DUST Drawn By: 1/8"=1'

Drawing Title: SITE PLAN

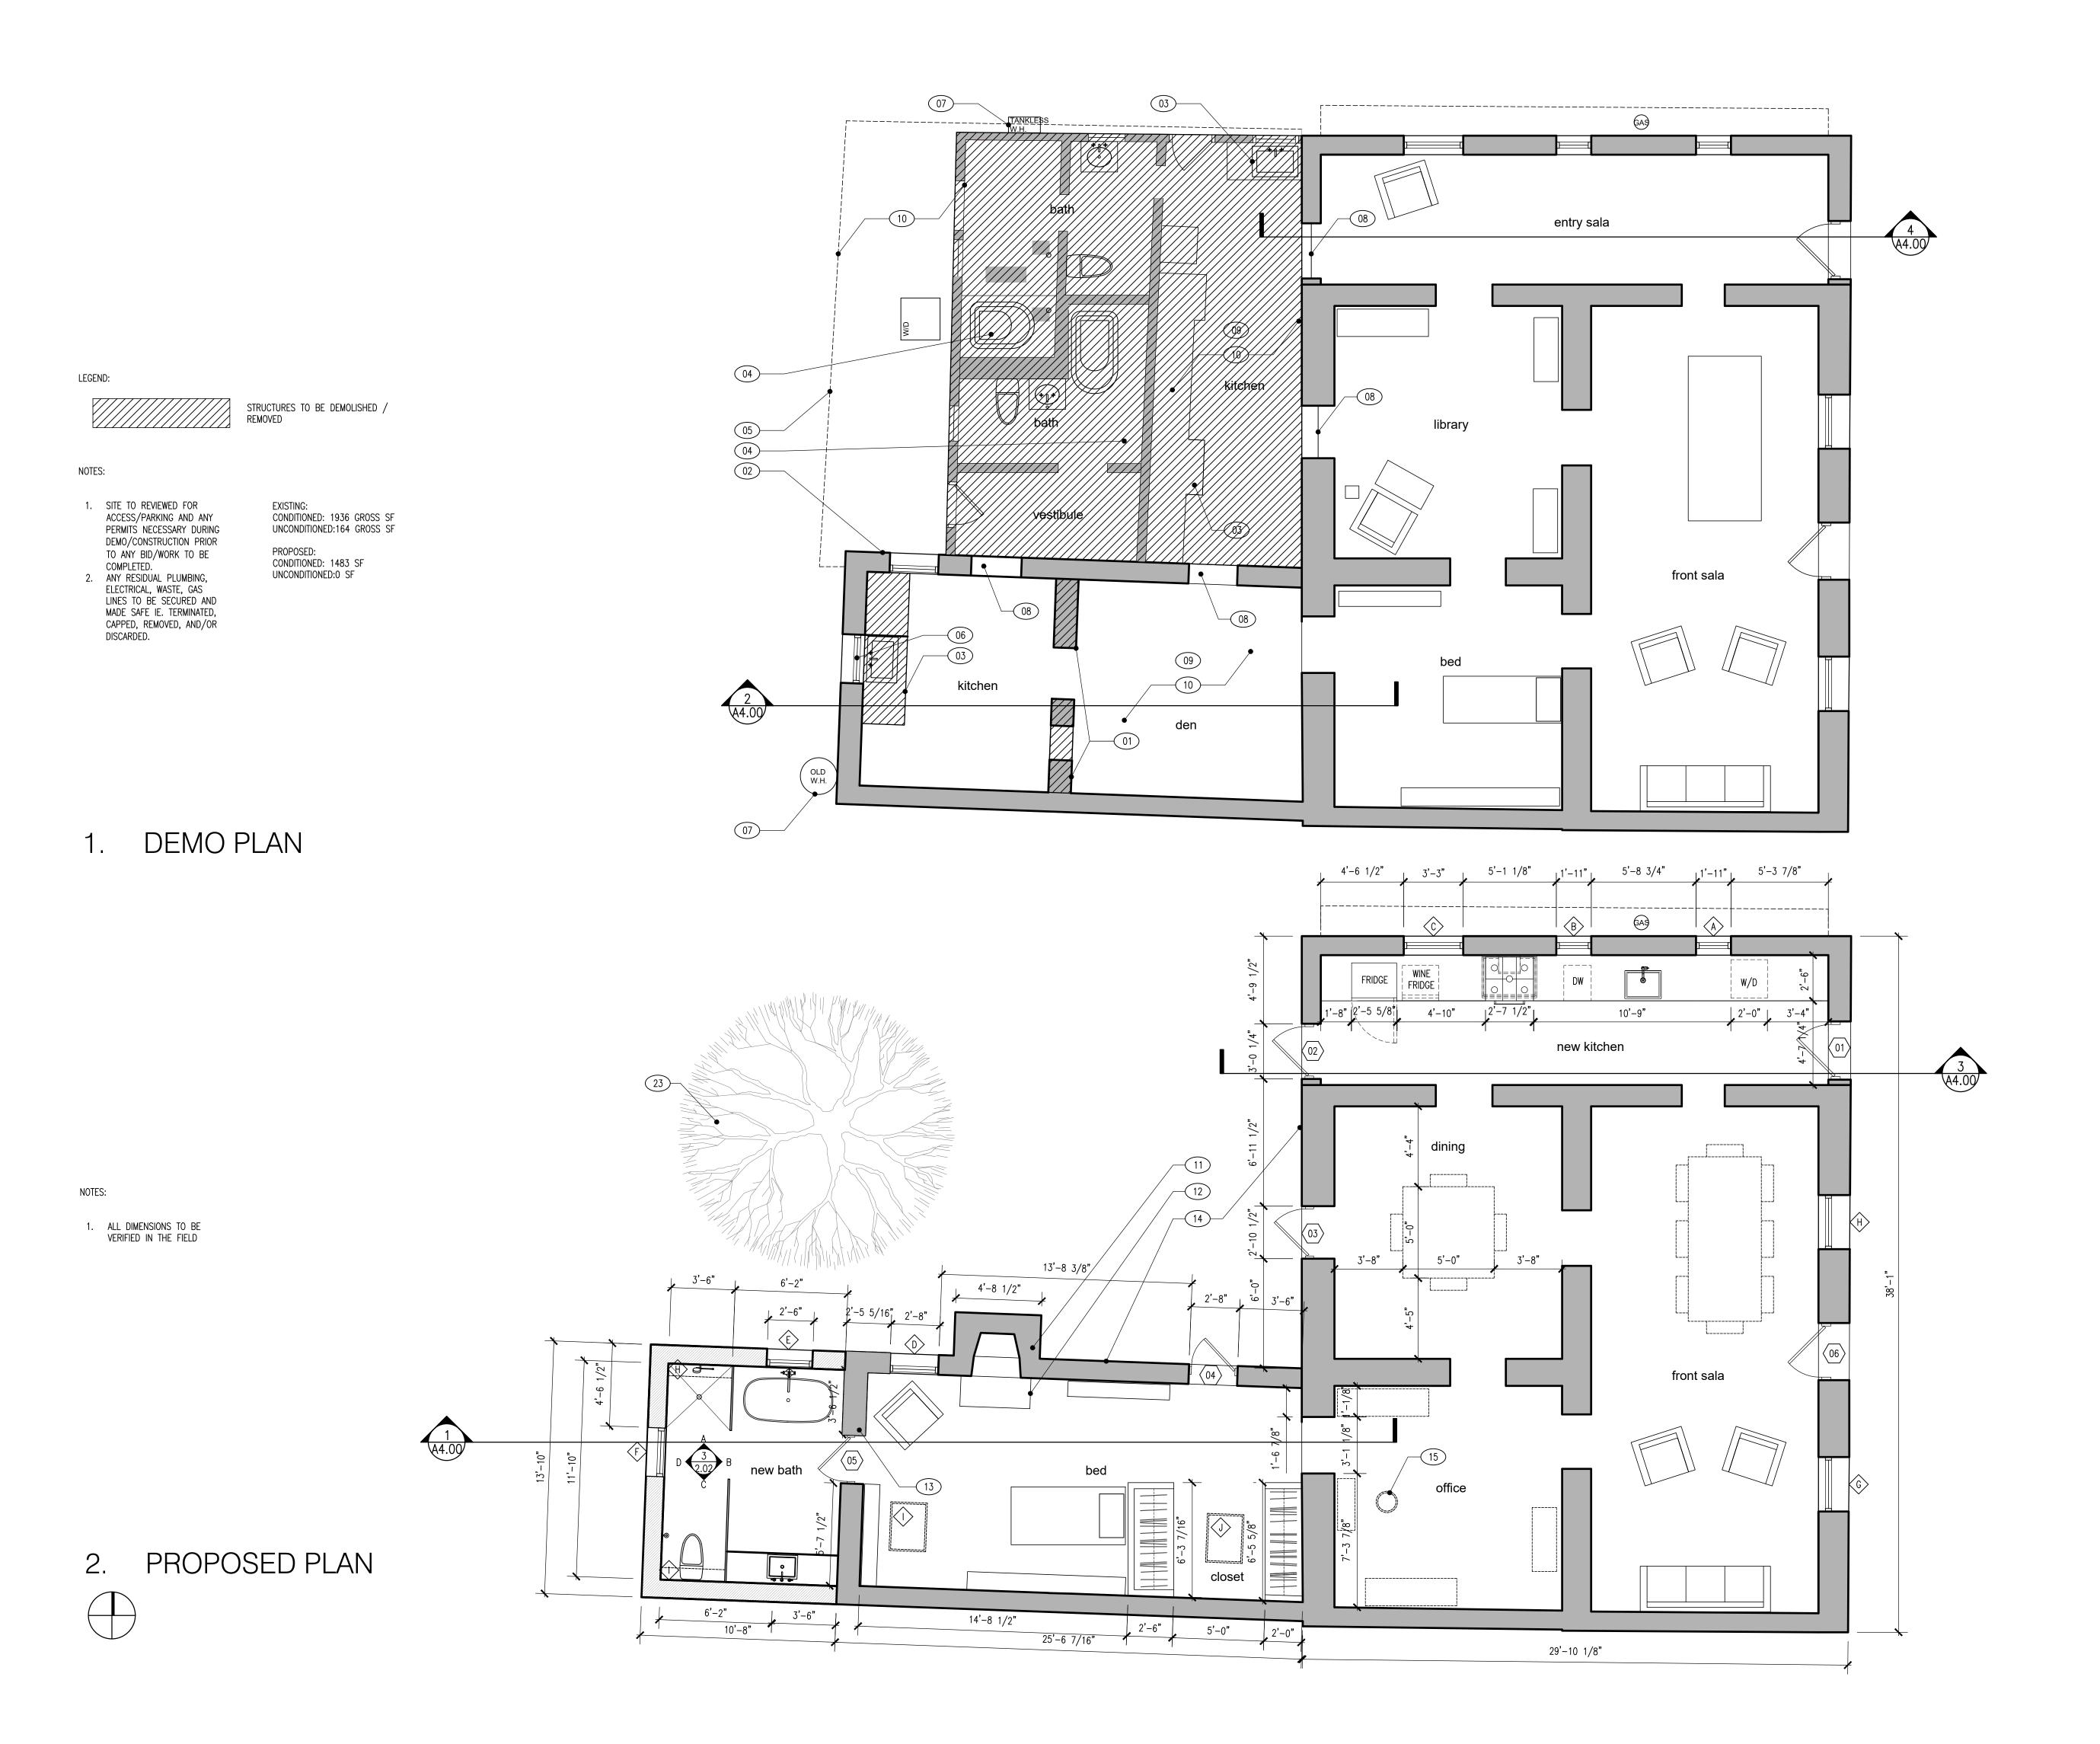

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Revision:

Keynote

01 EXISTING WALLS TO BE REMOVED.

02 EXISTING WALL TO REMAIN.
PATCH AND REPAIR AS NEEDED.

03 EXISTING COUNTER TO BE DEMOLISHED.

04 EXISTING KITCHEN/BATHROOMS
TO BE DEMOLISHED. FIXTURES
TO BE SALVAGED AT OWNERS

05 ALL EXISTING WALLS AND ROOF TO BE DEMOLISHED. ALL FIXTURES TO BE REMOVED.

DISCRETION.

06 EXISTING WINDOW TO BE CONVERTED INTO DOOR.

O7 ALL WATER HEATERS TO BE CONSOLIDATED TO ONE SEE

CONSOLIDATED TO ONE. SEE PLUMBING PLAN.

OPENINGS TO BE SECURED DURING CONSTRUCTION FROM DUST/DEBRIS & WEATHER

EXISTING ROOF & STRUCTURE TO BE DEMOLISHED/REMOVED

DEMO EXISTING FLOOR TO GRADE

NEW FIREPLACE. 30" FireRock RUMFORD KIT.

LINE OF 3'-10"x20"
NONCOMBUSTIBLE HEARTH

NEW DOOR MODIFIED FROM EXISTING WINDOW.

EXISTING ADOBE WALL.
PLASTER/STUCCO TO PATCH
TO MATCH EXISTING.

NEW 14" SOLAR TUBE

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Schneider Structural Engineers 435 E. 9th Street Tucson, AZ 85705 520-429-7080



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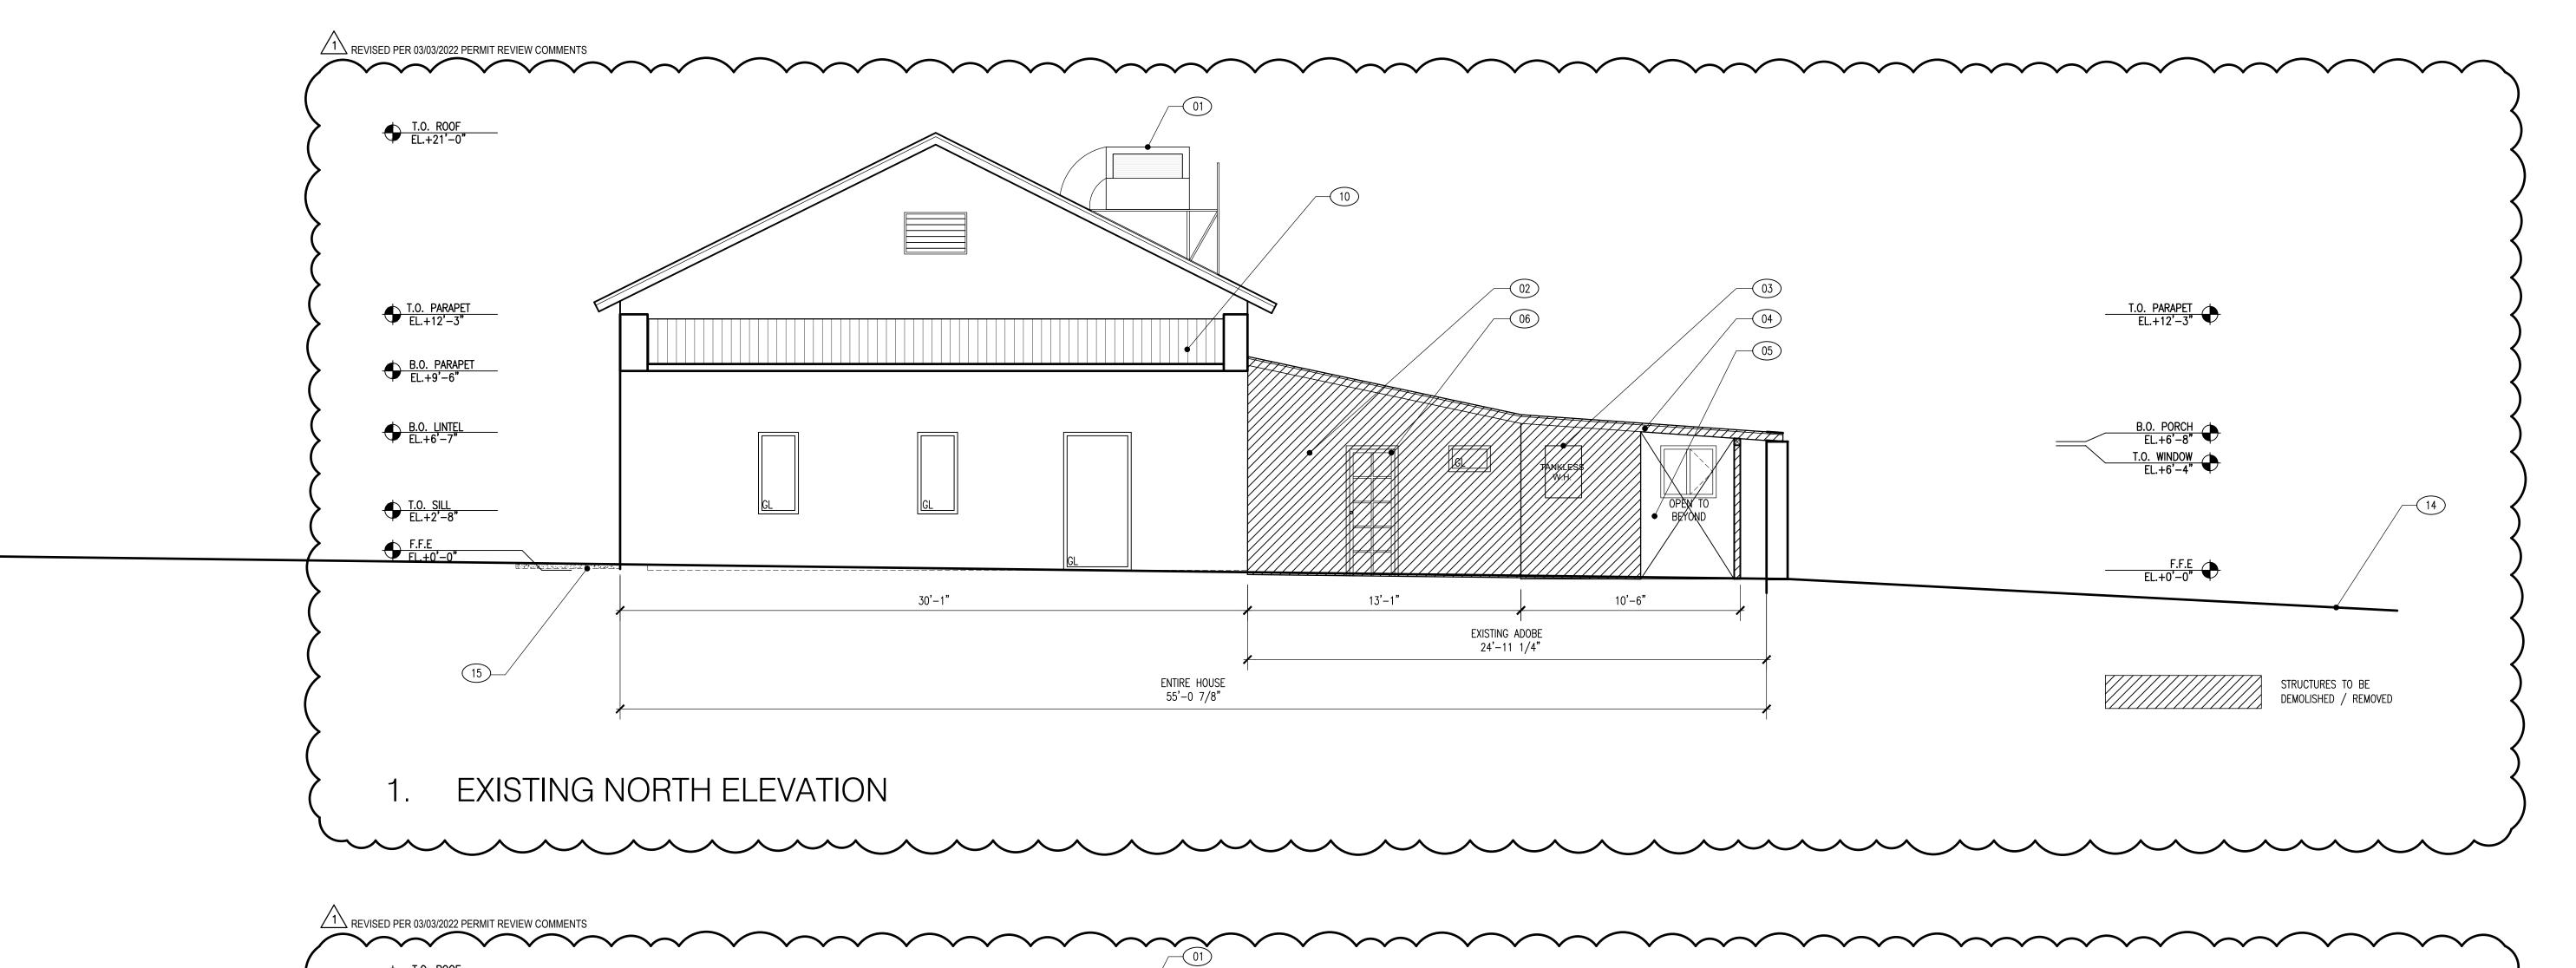
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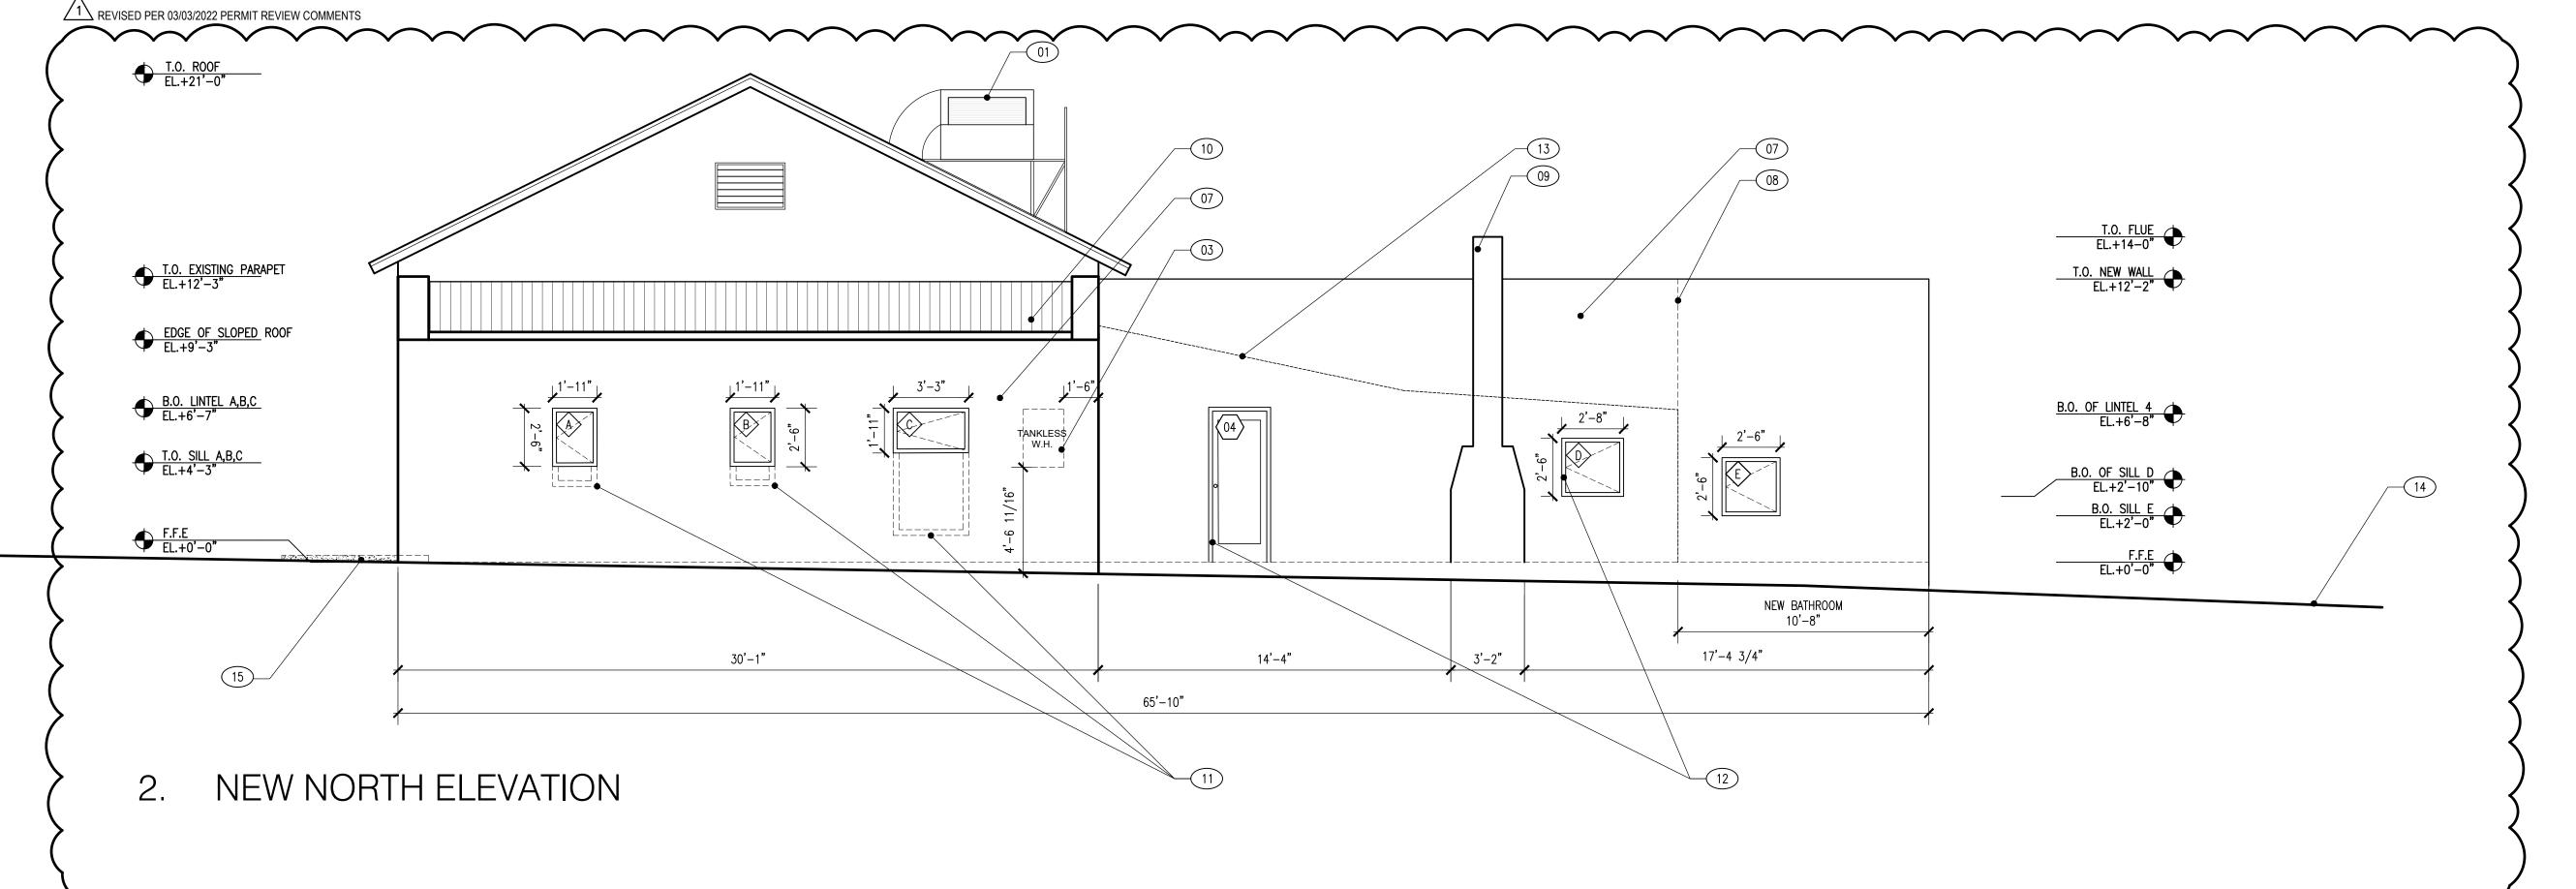
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Drawing Title:

Drawing Title:
DEMO PLAN &
PROPOSED
PLAN

Sheet No.:
A2.00





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Revision: Date:

03/07/2022
PERMIT REVIEW REVISION

Keynotes:

01) EXISTING A.C. UNIT

PROPOSED DEMO ZONE

02)

EXISTING LOCATION OF WATER HEATER. TO BE MOVED

O4 COVERED PORCH TO BE

DEMOLISHED

EXISTING ADOBE STRUCTURE
TO BE PRESERVED AND

REMOLDED. SEE A2.00

EXISTING DOOR TO BE
SALVAGED/RE PURPOSED.

COORDINATE WITH OWNER
NEW LIME STUCCO SMOOTH

TO MATCH EXISTING

OB LINE OF NEW BATHROOM

09 NEW FIREPLACE. 30" FireRock RUMFORD KIT.

10 EXISTING CORRUGATED SLOPED ROOF

LINE OF OLD OPENING. TO BE FRAMED IN AND STUCCO'D TO MATCH EXISTING

EXISTING OPENING. NEW FRAMED DOOR AND WINDOW.

LINE OF EXISTING ADOBE W/
NEW CMU ABOVE. SEE
STRUCTURAL.

APPROX. LINE OF SLOPPING GRADE

15 EXISTING SIDEWALK

Consultants:
Schneider Structural Engineers
435 E. 9th Street

435 E. 9th Street
Tucson, AZ 85705
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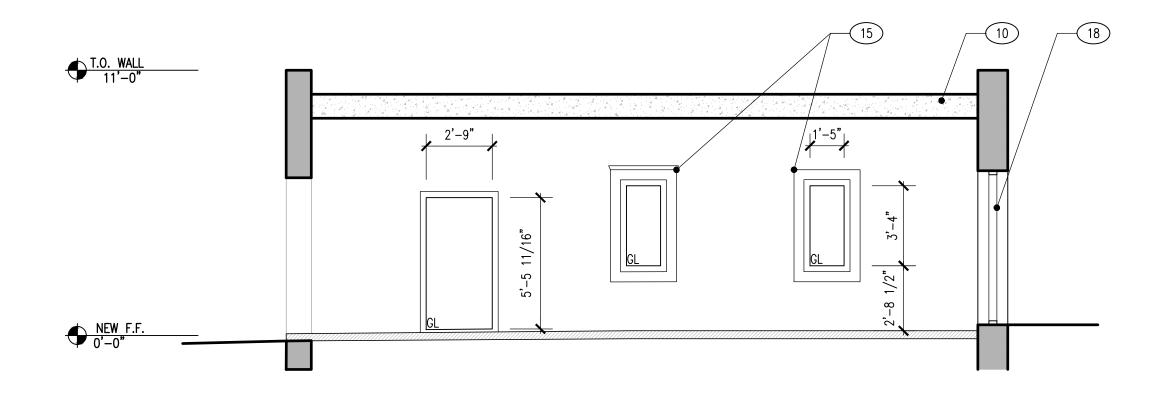
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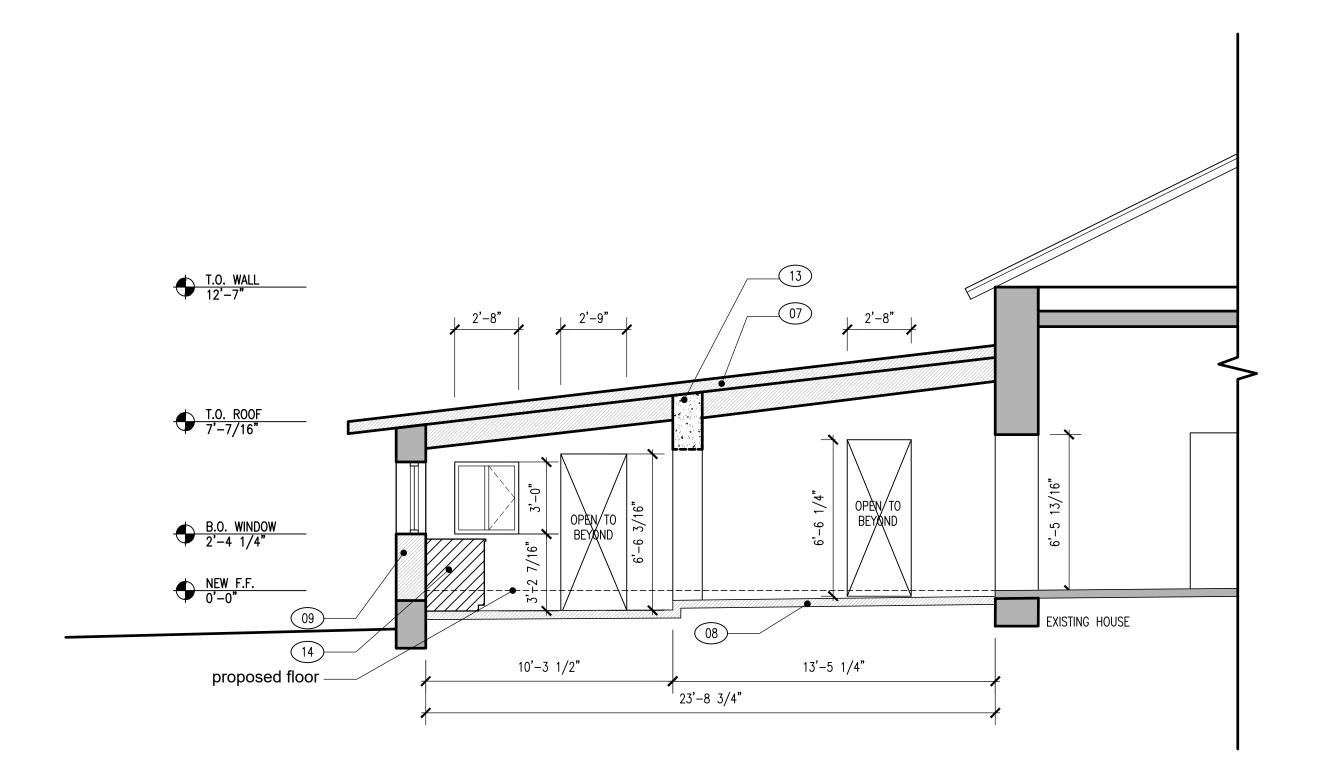
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BUILDING ELEVATIONS


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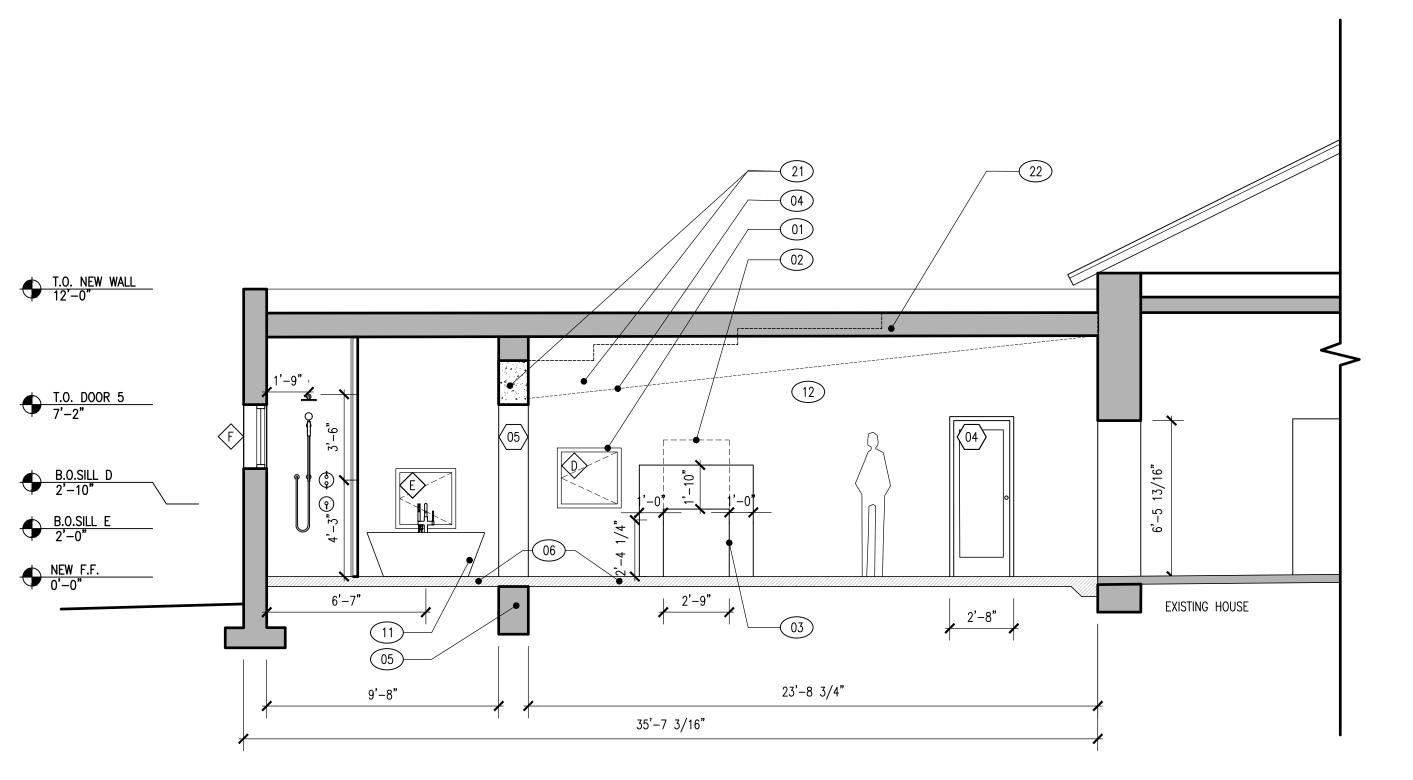
EXISTING SECTION- KITCHEN



EXISTING SECTION-BEDROOM AND BATHROOM



PROPOSED KITCHEN SECTION

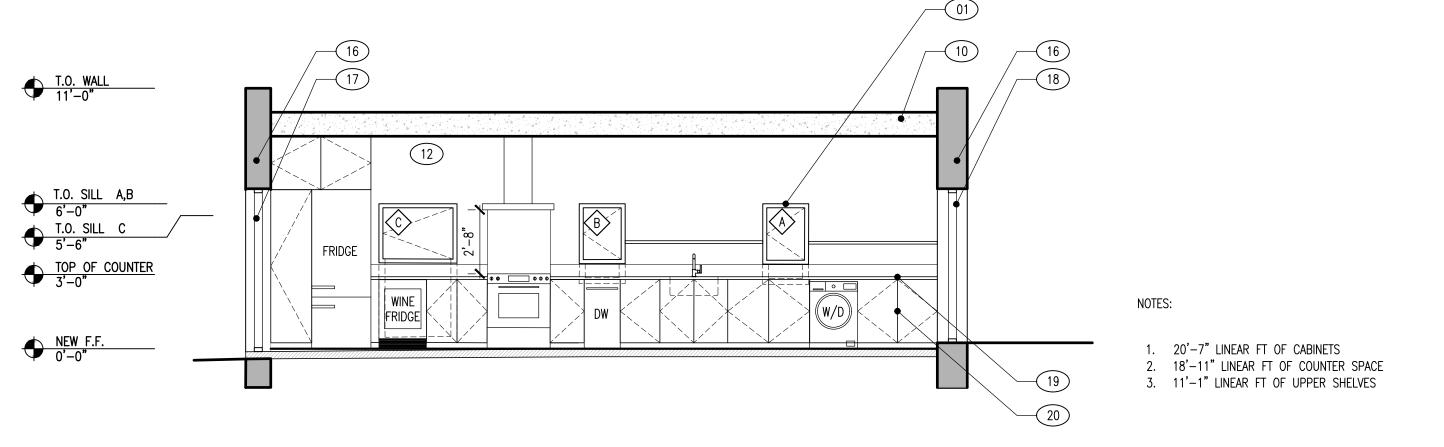

1. PROPOSED SECTION-BEDROOM AND BATHROOM

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Date:

Revision:

01 NEW WINDOW UNIT IN EXISTING OPENING.

02 LINE OF OLD DOOR, FILLED IN AND FINISHED TO MATCH.

UNE OF NEW FIREPLACE. 30" SHROUD.

04 EXISTING CEILING LINE FOR REFERENCE ONLY. 05 EXISTING WALL/FOUNDATION.

06 NEW 4" CONCRETE FLOOR SLAB. SEE STRUCTURAL. SLAB. SEE STRUCTURAL.

07 EXISTING ROOF STRUCTURE TO BE DEMOLISHED.

08 EXISTING FLOOR TO BE DEMOLISHED.

EXISTING WALL UNDER WINDOW TO BE DEMOLISHED

INTO DOOR. 10 EXISTING STRUCTURAL CAVITY.

NEW BATHTUB. VETRALLA 58 ¾"x29 ¾" 12 EARTHEN WALL PLASTER

EXISTING ADOBE WALL TO BE DEMOLISHED

EXISTING CABINETS TO BE DEMOLISHED

REMOVE ALL TRIM. PATCH AND PLASTER FOR NEW WINDOW SIZE/OPENING

16 EXISTING WALL
EXISTING ARCH.
EXTERIOR DOOR EXISTING ARCH. NEW CUSTOM EXTERIOR DOOR.

EXISTING EXTERIOR DOOR TO

19 SOLID SURFACE COUNTERTOP IKEA CABINETS W/REFORM SURFACE FRONT OR

COMPARABLE NEW BOND BEAM/LINTEL.

SEE STRUCTURAL. NEW 10" STRUCTURAL CAVITY.
SEE STRUCTURAL R-39 BATT SEE STRUCTURAL. R-39 BATT INSULATION W. TPO ROOFING

OVER SUBSTRATE.

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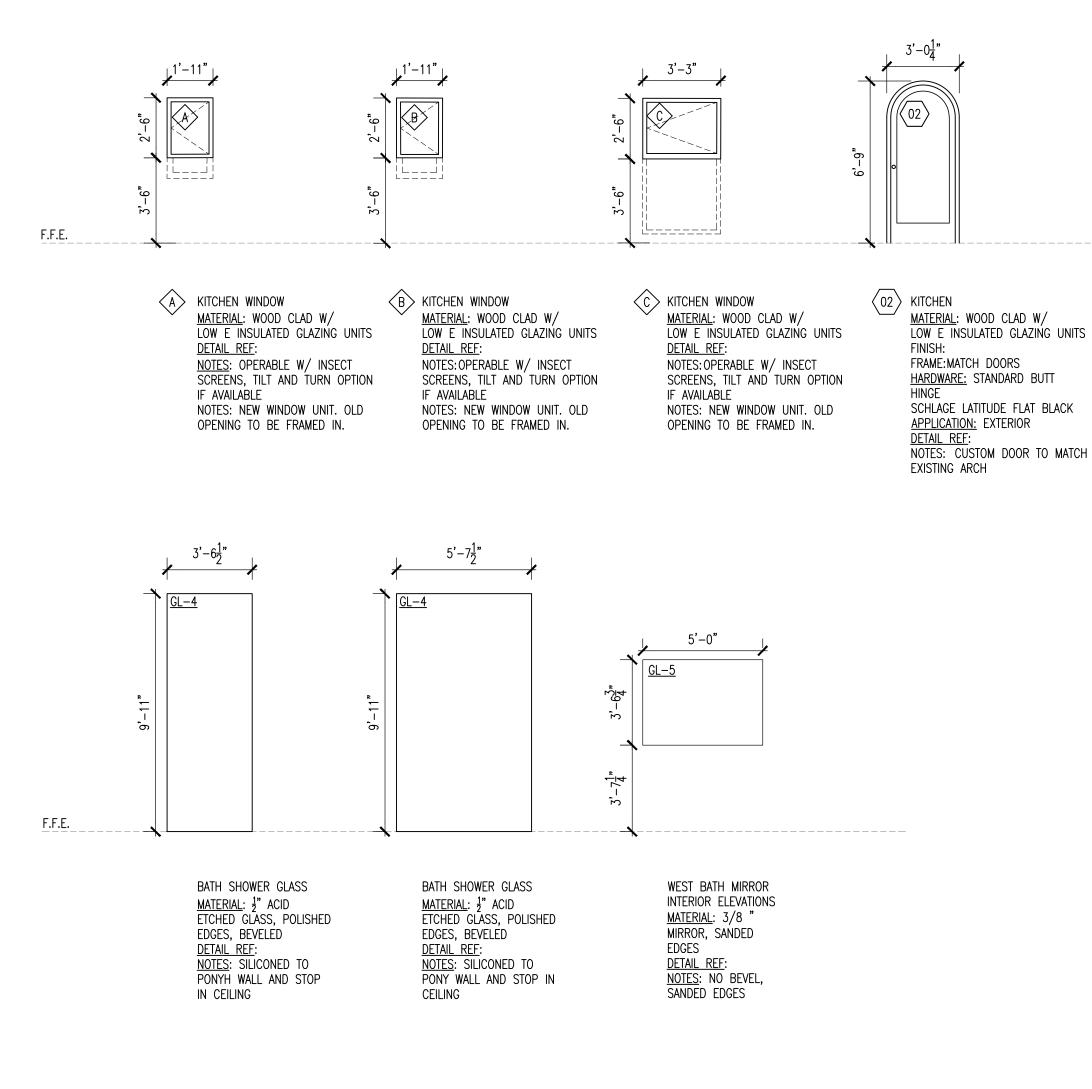
Baylor Residence


492 S Convent Ave, Tucson, AZ 85701 JANUARY 07 2022

Drawing Title:

BUILDING SECTIONS

Sheet No.:
A4.00



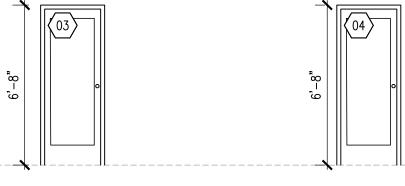

03 DINNING

MATERIAL: WOOD CLAD W/

<u>HARDWARE:</u> STANDARD BUTT

<u>APPLICATION:</u> EXTERIOR

<u>DETAIL REF</u>:


SCHLAGE LATITUDE FLAT BLACK

NOTES: CUSTOM DOOR TO MATCH

NOTE:TO MATCH MARVIN DOOR AND WINDOW PACKAGE

FRAME:MATCH DOORS

LOW E INSULATED GLAZING UNITS

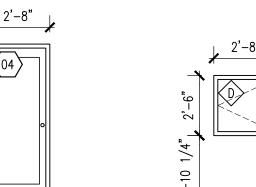

(04) BEDROOM

MATERIAL: WOOD CLAD W/

FRAME: MATCH DOORS

<u>APPLICATION:</u> EXTERIOR

<u>DETAIL REF</u>:

WINDOW PACKAGE


LOW E INSULATED GLAZING UNITS

HARDWARE: STANDARD BUTT HINGE

NOTES: TO MATCH MARVIN DOOR AND

SCHLAGE LATITUDE FLAT BLACK



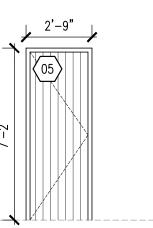

(05) BATHROOM DOOR

CONCEALED

<u>DETAIL REF</u>:

BEDROOM

MATERIAL: TO MATCH CABINETRY


FINISH: TO MATCH CABINETRY

<u>HARDWARE:</u> CENTER PIVOT OR

NOTES: FLUSH, TRIMLESS TOWARDS

FRAME: MATCH DOORS

APPLICATION: INTERIOR

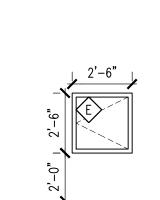

E BATHROOM WINDOW

<u>DETAIL REF</u>:


IF AVAILABLE.


CMU CONSTRUCTION.


MATERIAL: WOOD CLAD W/

NOTES: OPERABLE W/ INSECT

NOTES: NEW WINDOW UNIT IN

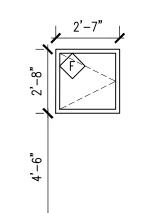

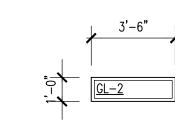

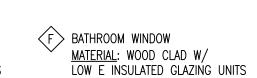

LOW E INSULATED GLAZING UNITS <u>DETAIL REF</u>: NOTES: OPERABLE W/ INSECT SCREENS, TILT AND TURN OPTION SCREENS, TILT AND TURN OPTION IF AVAILABLE. NOTES: NEW WINDOW UNIT IN CMU CONSTRUCTION.



BATHROOM SKYLIGHT SKYLIGHT (VCE) - CURB MOUNT MATERIAL: ALUMINUM TOP HUNG CURB MOUNT SKYLIGHT W/ INSULATED LOW E GLASS <u>DETAIL REF</u>: <u>NOTES</u>:

GENERAL NOTES:

(D) BEDROOM WINDOW

<u>DETAIL REF</u>:

IF AVAILABLE.

MATERIAL: WOOD CLAD W/

NOTES: OPERABLE W/ INSECT

LOW E INSULATED GLAZING UNITS

SCREENS, TILT AND TURN OPTION

NOTES: NEW WINDOW UNIT. OLD

OPENING TO BE FRAMED IN.

- WINDOWS, DOORS, FRAMES, STILES, RAILS, SASHES, ETC. ARE SHOWN INDICATIVELY ONLY. DO NOT SCALE FROM DRAWING. ALL DIMENSIONS ARE INDICATED ON THESE ELEVATIONS. WORK TO ANNOTATED DIMENSIONS ONLY.
- MANUFACTURER TO REVIEW SECTION SIZES AND GLASS THICKNESS INDICATED WITH REGARD TO WIND CAPACITY, ALONG WITH FRAME AND SASH STIFFNESS, PARTICULARLY AT OPENING ELEMENTS.
- 3. DIMENSIONS INDICATED IN DRAWINGS ARE ROUGH OPENINGS UNLESS NOTED OTHERWISE. IT IS THE CONTRACTOR'S RESPONSIBILITY TO VERIFY ALL DIMENSIONS IN THE FIELD AND ORDER/INSTALL PROPER UNIT SIZES.
- 4. FABRICATE ALL GLAZING WITHOUT MANUFACTURER'S IDENTIFICATION, ETCHINGS, AND ETCHED SAFETY LABELING.
- 5. DOOR HARDWARE: BALDWIN 5166 ESTATE LEVER; OIL-RUBBED BRONZE (102) FINISH OR SCHLAGE LATITUDE FLAT
- 6. THIS DRAWING IS TO BE READ IN CONJUNCTION WITH ASSOCIATED 'ARCHITECTURAL' AND 'STRUCTURAL' DRAWINGS.
- CONTRACTOR TO BRING TO THE ATTENTION OF THE ARCHITECT ANY DISCREPANCIES WHICH HE MAY FIND ON THIS DRAWING AND/OR ASSOCIATED DOCUMENTS PRIOR TO COMMENCEMENT OF MANUFACTURER
- OVERALL DOOR AND WINDOW DIMENSIONS INDICATED ARE EXTERIOR FINISHED OPENING DIMENSIONS AS MEASURED FROM THE FACE OF FINISH MATERIAL. CONTRACTOR TO CHECK ALL SUCH OPENING DIMENSIONS ON SITE PRIOR TO COMMENCEMENT OF MANUFACTURER, AND ALLOW FOR SUITABLE TOLERANCES.
- 9. ALL MATERIALS TO BE USED STRICTLY IN ACCORDANCE WITH MANUFACTURER INSTRUCTIONS.
- 10. ALL WINDOWS TO OPEN INWARD UNLESS INDICATED OTHERWISE ON THIS SCHEDULE
- 11. ALL WINDOW AND DOOR SECTIONS TO BE THERMALLY BROKEN.
- 12. MANUFACTURER TO INSTALL HEAVY STAYS, HANDLES, LOCKS, AND ANY OTHER APPROVED STANDARD HARDWARE AND DOOR HARDWARE TO ALL UNITS.
- 13. ALL OPERABLE WINDOWS, TRANSOMS, AND SLIDING DOORS, SHALL HAVE INSECT SCREENS, CONTRACTOR SHALL INSTALL SCREENS PROVIDED BY MANUFACTURER.
- 14. MANUFACTURER TO PREPARE SHOP DRAWINGS FOR ALL TYPES OF DOORS AND WINDOWS FOR ARCHITECTS APPROVAL PRIOR TO COMMENCEMENT OF MANUFACTURE.
- 15. ALL ALUMINUM DOORS AND WINDOWS TO BE DARK ANODIZED FINISH. PER MANUFACTURER UNLESS OTHERWISE

WOOD DOORS AND WINDOWS: SIZES AND PROFILES AS INDICATED IN THE DRAWINGS. VG FIR OR SIMILAR GRAIN PATTERN FOR INTERIOR DOORS. MATTE TO FLAT FINISH. DOORS TO MATCH CABINETRY, TO BE SIMILAR VENEER PRODUCT AND

- FINISH SPECS AND STANDARDS. 16. ALL CUSTOM DOORS TO BE WEATHER TIGHT
- 18. WINDOW AND DOOR CAULKING: EXTERIOR WINDOW AND DOOR SEALANT TO MATCH SCORIA WALL TEXTURE AND COLOR. SANDED GROUT CAULK TO BE REVIEWED AND APPROVED WITH ARCHITECT PRIOR TO INSTALLATION.
- 19. FOR WOOD DOORS AND WINDOWS COMPLY WITH AWI'S "ARCHITECTURAL WOODWORK QUALITY STANDARDS ILLUSTRATED:; LATEST EDITION PREMIUM GRADE

GLASS NOTES AND SPECIFICATIONS:

1. VERIFY ALL DIMENSIONS IN FIELD — DIMENSIONS INDICATED ARE FOR REFERENCE ONLY

NOMINAL OPENINGS.

- ALL GLASS SHALL BE HERMETICALLY SEALED DOUBLE GLAZED UNITS TO EXTERIOR WINDOWS, SKYLIGHTS, AND DOORS WITH GLAZING UNITS SHALL CONSIST OF THE FOLLOWING PROPERTIES PER 2018 IRC ZONE 3 TABLE 1102.1.2 (R402.1.1). HERS RATING CERTIFICATION DATA TO OVERRIDE ANY GENERAL NOTES REGARDING GLAZING VALUES:
- U-VALUE .32 MAX
- SKYLIGHT U-VALUE .55 MAX SOLAR HEAT GAIN COEFFICIENT .25 MAX
- MANUFACTURER TO PROVIDE TEMPERED GLAZING AS REQUIRED BY LOCAL AND STATE CODE.
- 4. PROVIDE OBSCURED GLASS AS NOTED.
- 5. ALL INTERIOR GLASS TO BE FRAMELESS SINGLE GLAZING
- ALL OPERABLE WINDOWS TO HAVE INSECT SCREENS. INSULATED GLASS TRIM TO BE BLACK, BLACK SILICONE.
- 8. OBSCURED GLASS SHOWN TONED FOR CLARITY
- 9. ALL WINDOWS TO HAVE VISIBLE LIGHT TRANSMITTANCE OF MIN 60%
- 10. EXIT WINDOWS FOR BEDROOMS MUST PROVIDE A MINIMUM OF 5.7 SQ. FT.

GL-1 1" INSULATED GLAZING UNIT

<u>GL-2</u> 1" INSULATED GLAZING UNIT W/ TEMPERED PANES

GL-3 1" ACID ETCHED INSULATED GLAZING UNIT W/ TEMPERED PANES

<u>GL-4</u> 1/2" ACID ETCHED FRAMELESS GLASS, TEMPERED

GL-5 1/4" MIRROR



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Revision:

Keynotes:



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Project Name:

Baylor Residence

492 S Convent Ave, Tucson, AZ 85701

JANUARY 07 2022 PERMIT Issued For:

DUST Drawn By:

1/4"=1'

Drawing Title: DOOR AND WINDOW SCHEDULE

Structural Notes

- 1. ALL WORK SHALL CONFORM TO THE 2018 INTERNATIONAL BUILDING
- 2. NOTES AND DETAILS ON DRAWINGS SHALL TAKE PRECEDENCE OVER GENERAL STRUCTURAL NOTES AND TYPICAL DETAILS. WHERE NO SPECIFIC DETAILS ARE SHOWN, CONSTRUCTION SHALL CONFORM TO SIMILAR WORK ON THE PROJECT.
- 3. VERIFY ALL DIMENSIONS WITH ARCHITECTURAL DRAWINGS PRIOR TO START OF CONSTRUCTION RESOLVE ANY DISCREPANCY WITH ARCHITECT. DO NOT SCALE DRAWINGS.
- 4. FOR CLARITY, ALL ROOF, FLOOR, AND WALL OPENINGS MAY NOT BE SHOWN ON STRUCTURAL DRAWINGS. FOR EXACT SIZE, NUMBER, AND LOCATION OF OPENINGS, SEE THE ARCHITECTURAL, MECHANICAL, ELECTRICAL, AND PLUMBING DRAWINGS. FOR FRAMING AT OPENINGS, SEE TYPICAL STRUCTURAL DETAILS. VERIFY ALL SIZES, WEIGHTS, AND LOCATIONS OF MECHANICAL AND ELECTRICAL EQUIPMENT, DUCTS, WITH MECHANICAL AND ELECTRICAL ENGINEERS THROUGH THE ARCHITECT.
- 5. CONSTRUCTION MATERIALS SHALL BE SPREAD OUT IF PLACED ON FRAMED FLOORS OR ROOF. LOAD SHALL NOT EXCEED THE DESIGN LIVE LOAD PER SQUARE FOOT.
- 6. THE CONTRACTOR SHALL TAKE ALL MEASURES NECESSARY TO PROTECT THE STRUCTURE DURING CONSTRUCTION INCLUDING, BUT NOT LIMITED TO, BRACING, SHORING, ETC. THE CONTRACTOR SHALL BE RESPONSIBLE FOR THE DESIGN AND IMPLEMENTATION OF ALL SCAFFOLDING, BRACING, AND SHORING. OBSERVATION VISITS TO THE SITE BY THE STRUCTURAL ENGINEER SHALL NOT INCLUDE INSPECTION OF THE ABOVE ITEMS THE STRUCTURAL ENGINEER WILL NOT BE RESPONSIBLE FOR THE CONTRACTOR'S MEANS, METHODS, TECHNIQUES, SEQUENCES OR PROCEDURES OF CONSTRUCTION. NOR WILL THE STRUCTURAL ENGINEER BE RESPONSIBLE FOR CONSTRUCTION SITE SAFETY, OR THE SAFETY PRECAUTIONS AND THE PROGRAMS INCIDENT THERETO.
- 7. THE CONTRACT STRUCTURAL DRAWINGS REPRESENT THE FINISHED STRUCTURE. THEY DO NOT INDICATE THE METHOD OF CONSTRUCTION.
- 8. ALL SLABS AND FOOTINGS SHALL BEAR ON FIRM, UNDISTURBED NATIVE SOIL. ALL SOIL BELOW FOOTINGS AND SLABS SHALL BE COMPACTED TO 95% MINIMUM IN ACCORDANCE TO ASTM D698. DESIGN SOIL BEARING PRESSURE = 1500 PSF. THE STRUCTURAL ENGINEER ACCEPTS NO RESPONSIBILITY FOR EXISTING SOIL CONDITIONS. FOOTING DESIGN IS BASED UPON MINIMUM INTERNATIONAL BUILDING CODE SOIL BEARING VALUES AS REQUIRED BY THE BUILDING CODE DEPARTMENT IN THE ABSENCE OF A SOIL REPORT. IT SHALL BE THE OWNER'S RESPONSIBILITY TO VERIFY THE SOIL BEARING PRESSURE AND TO DETERMINE WHETHER UNSUITABLE SOIL CONDITIONS (I.E. EXPANSIVE OR COLLAPSIBLE SOILS, LOOSE FILLS, ETC.) EXIST.
- 9. LAP SPLICES FOR REINFORCING IN CONCRETE SHALL BE 30 BAR DIAMETERS MINIMUM.
- 10. LAP SPLICES FOR REINFORCING IN CMU SHALL BE 48 BAR DIAMETERS FOR GRADE 60 REINFORCING U.N.O.
- 11. PROVIDE BENT CORNER BARS TO MATCH AND LAP HORIZONTAL REINFORCING AT CORNERS AND INTERSECTIONS IN CONCRETE FOOTINGS AND WALLS AND MASONRY WALL BOND BEAMS.
- 12. CMU WALLS SHALL BE REINFORCED WITH #4 VERTICAL REINFORCING AT 32" O.C. MAXIMUM, AND AT ALL CORNERS, INTERSECTIONS, WALL ENDS, BEAM BEARINGS, JAMBS, AND EACH SIDE OF CONTROL JOINTS. PROVIDE #9 GAGE WIRE HORIZONTAL JOINT REINFORCING AT 16" O.C.
- 13. ALL NAIL SPACING NOT NOTED SHALL BE ACCORDING TO TABLE 2304.9.1 OF THE INTERNATIONAL BUILDING CODE. SIZE AND NUMBER OF NAILS IN JOIST HANGERS AND MISCELLANEOUS FRAMING ANCHORS SHALL BE ACCORDING TO THE MANUFACTURER'S LATEST CATALOG.

15. DESIGN LOADS:

ROOF LIVE LOAD = 20 PSF (REDUCIBLE)
ROOF DEAD LOAD = 15 PSF

ROOF UPLIFT WIND LOAD = 5 PSF (NET)

SUPERIMPOSED DEAD LOADS DO NOT INCLUDE THE SELF—WEIGHT OF SUPPORTING FRAMING TO BE DESIGNED BY OTHERS.

WIND: BASIC WIND SPEED = 105 MPH, EXPOSURE "C", I = 1.00 SEISMIC: DESIGN CATEGORY B

16. MATERIALS OF CONSTRUCTION:

CONCRETE - ASTM C94, F'c = 3000 PSI AT 28 DAYS

REINFORCING – ASTM A615 GRADE 60

CMU – ASTM C90 WITH A

NET COMPRESSIVE STRENGTH OF 2000 PSI. F'm = 2000 PSI

GROUT - ASTM C476, 2000 PSI AT 28 DAYS

MORTAR - ASTM C270, TYPE S, PORTLAND CEMENT, 2000 PSI AT 28 DAYS

ANCHOR BOLTS - ASTM A36 OR ASTM A307, GRADE A

G LUMBER - WWPA OR WCLB STAMPED, 19% MAXIMUM MOISTURE CONTENT, DOUGLAR-FIR LARCH OF THE FOLLOWING GRADES:

TYPICAL U.N.O. – #2 6X POSTS AND BEAMS – #1 2X4 STUDS – STUD GRADE

PLYWOOD
APA STAMPED WITH AN EXTERIOR OR EXPOSURE 1

DURABILITY CLASSIFICATION NAILED WITH COMMON NAILS

APA RATED SHEATHING (I.E. WAFERBOARD


AND ORIENTED STRAND BOARD) CONFORMING TO

NER-108 AND WITH THE EQUIVALENT EXPOSURE


NER-108 AND WITH THE EQUIVALENT EXPOSURE DURABILITY CLASSIFICATION, THICKNESS AND SPAN INDEX RATIO MAY BE SUBSTITUTED FOR PLYWOOD IF APPROVED IN WRITING BY THE ARCHITECT.
LAY-UP PLYWOOD WITH LONG DIMENSION PERPENDICULAR TO SUPPORTS AND STAGGER JOINTS. BLOCK ALL UNSUPPORTED EDGES AT WALLS.

USE THICKNESS SPAN INDEX EDGE NAILING INTERMEDIATE NAILING ROOF 5/8" 32/16 8d AT 6" O.C. 8d AT 12" O.C.


17. SPECIAL INSPECTIONS. THIS IS A MINOR STRUCTURE. NO SPECIAL INSPECTIONS REQUIRED.

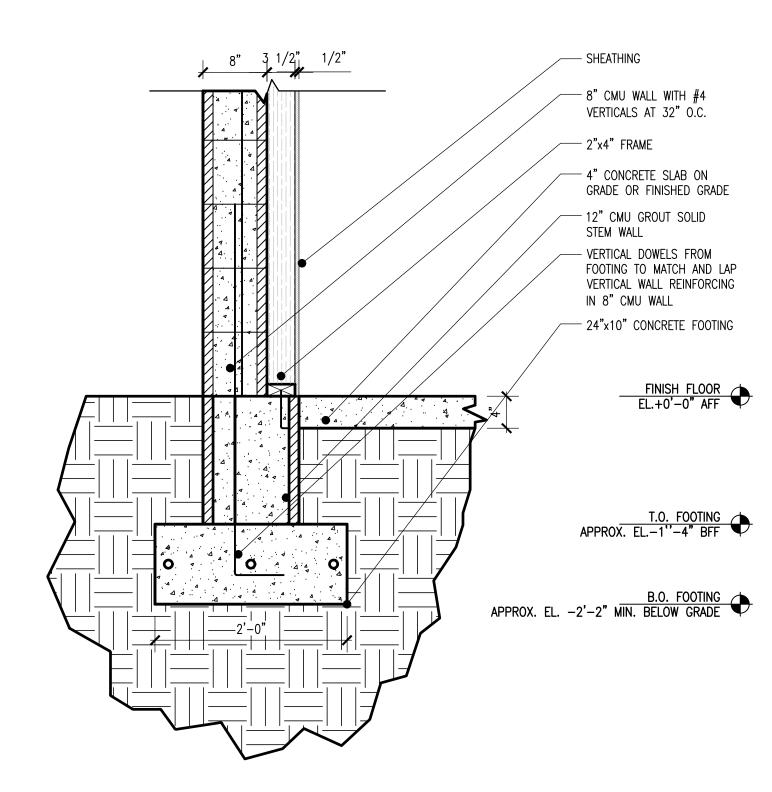

3. STEM WALL DETAIL

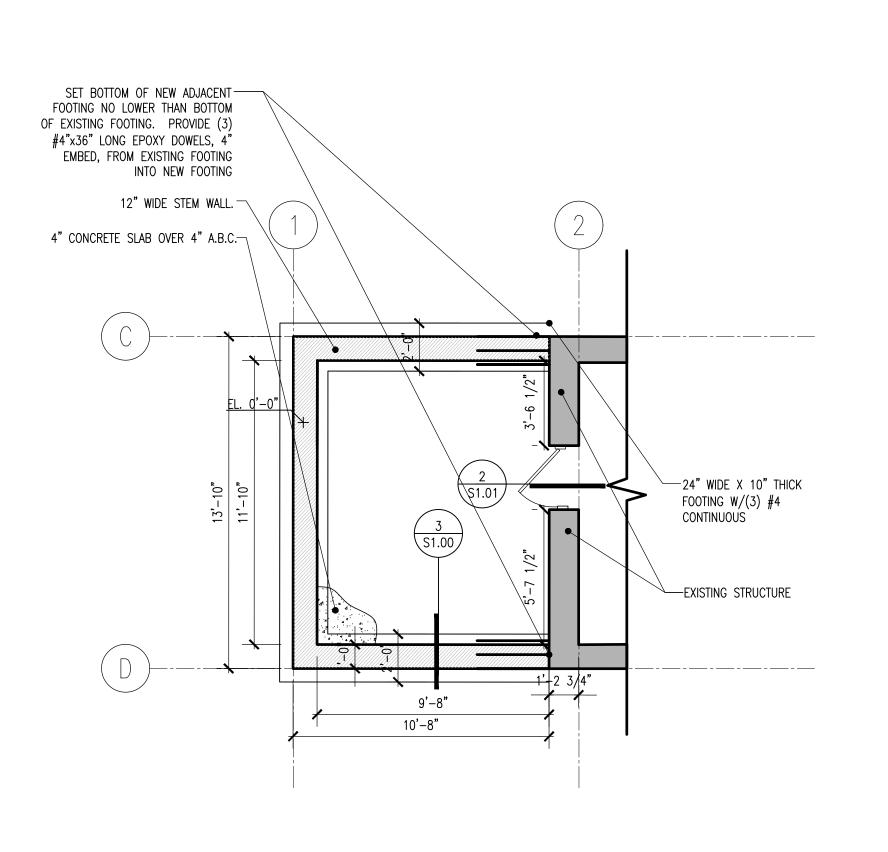



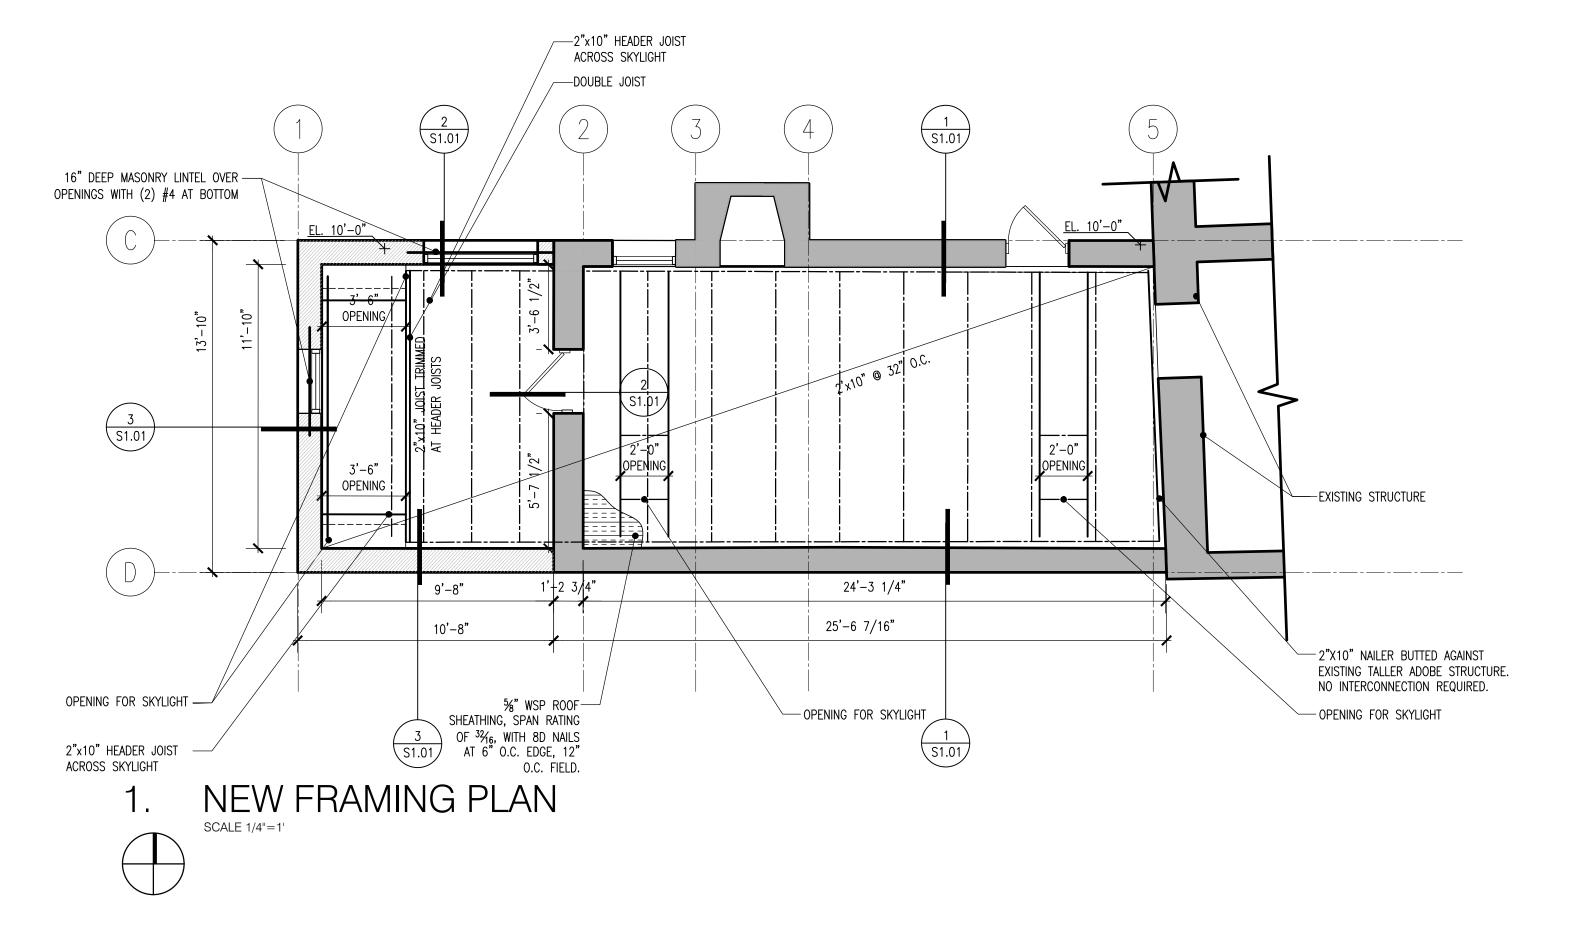

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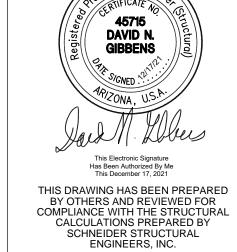
Revision: Date:

Keynotes:

Consultants:

Schneider Structural Engineers
435 E. 9th Street
Tucson, AZ 85705

520-429-7080



Project Name:

Baylor Residence

492 S Convent Ave, Tucson, AZ 85701

Date: NOVEMBER 30 2021


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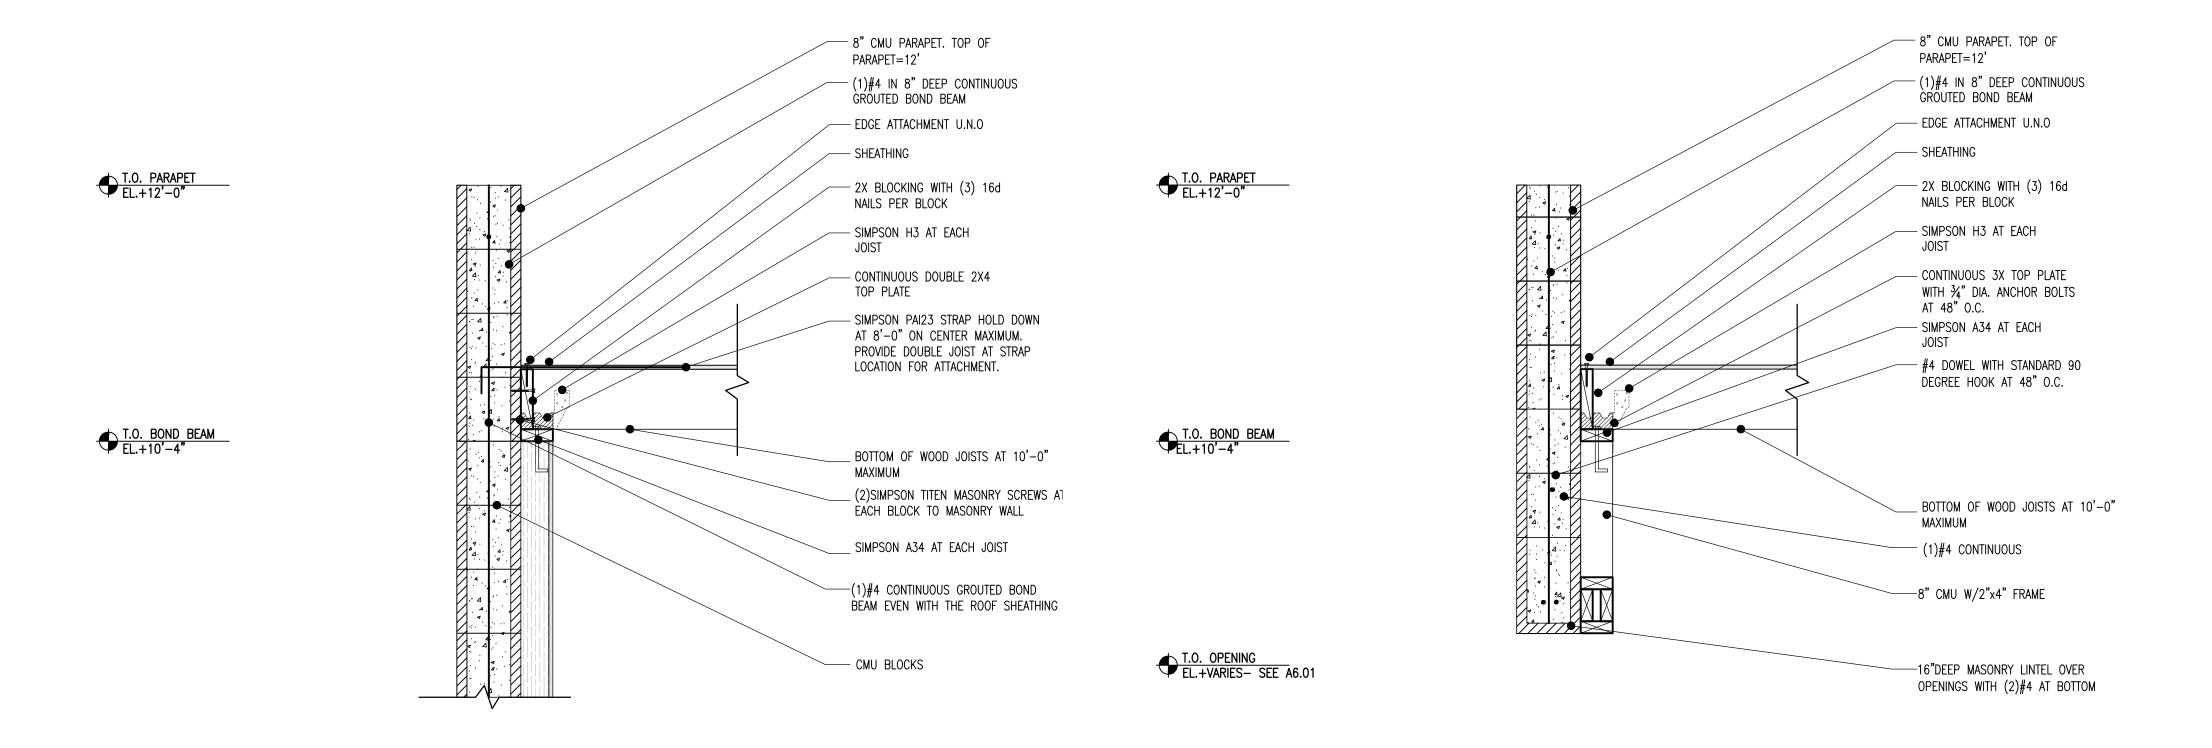
Drawn By: DUST
Scale: 1/4"=1'

Drawing Title:

FRAMING & FOUNDATION PLAN/DETAIL

Sheet No.: **S1.00**



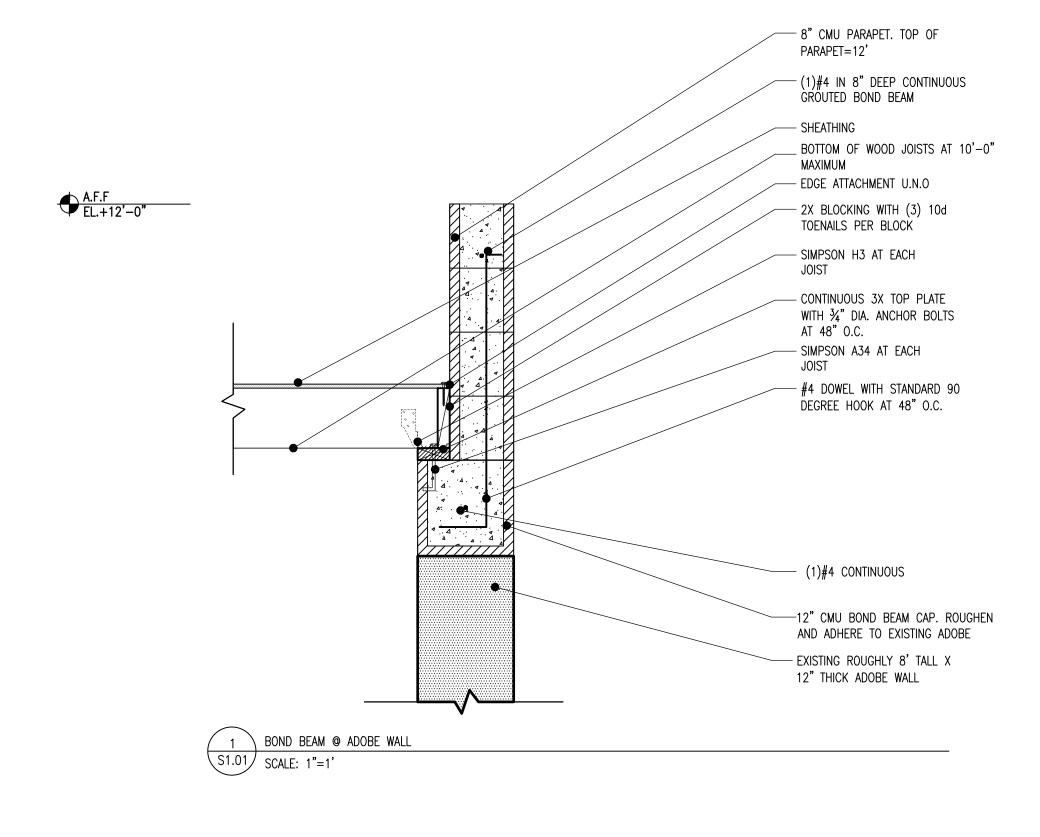

BOND BEAM @ CMU WALL
SCALE: 1"=1'

MASONRY LINTEL
S1.01 SCALE: 1"=1'

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Keynotes:

Consultants: Schneider Structural Engineers

435 E. 9th Street Tucson, AZ 85705 520-429-7080

ROLESSIONAL Engines ROLESTIFICATE NO. 45715 DAVID N. GIBBENS THIS DRAWING HAS BEEN PREPARED
BY OTHERS AND REVIEWED FOR
COMPLIANCE WITH THE STRUCTURAL
CALCULATIONS PREPARED BY
SCHNEIDER STRUCTURAL
ENGINEERS, INC.

Project Name:

Baylor Residence

492 S Convent Ave, Tucson, AZ 85701 NOVEMBER 30 2021 Date: REVIEW Issued For:

DUST Drawn By:

1"=1' Scale:

Drawing Title: STRUCTURAL DETAILS

Sheet No.: **S1.01**

Electrical Notes

- 1. ALL WORK SHALL COMPLY AND SHALL BE PERFORMED WITH THE CURRENT N.E.C., 2018 I.R.C. AND ALL APPLICABLE LOCAL CODES AND ORDINANCES
- 2. THE ELECTRICAL CONTRACTOR SHALL PROVIDE ALL MATERIALS, EQUIPMENT, LABOR, ETC. NECESSARY FOR A COMPLETE AND OPERABLE ELECTRICAL SYSTEM WHETHER OR NOT ALL ITEMS ARE SPECIFICALLY NOTED IN THESE DRAWINGS.
- 3. ALL WORK SHALL BE INSTALLED USING THE LATEST AND BEST INDUSTRY STANDARDS.
- 4. IT IS THE ELECTRICAL CONTRACTORS' RESPONSIBILITY TO REVIEW THE DRAWINGS, PANEL SCHEDULES & LOAD CALCULATIONS AND COORDINATE THE INSTALLATION OF ALL ELECTRICAL WORK WITH THE GENERAL CONTRACTOR AND ALL OTHER TRADES. ANY OMISSIONS OR DISCREPANCIES IN THE DRAWINGS OR EXISTING CONDITIONS AT THE SITE OR SERVICE SHOULD BE BROUGHT TO THE ARCHITECT'S ATTENTION FOR CLARIFICATION PRIOR TO SUBMISSION OF BID OR COMMENCEMENT OF WORK.
- 5. ALL WIRING SHALL BE RUN CONCEALED UNLESS OTHERWISE INDICATED ON THE DRAWINGS.
- 6. 120 VOLT, SINGLE PHASE 15 AMP AND 20 AMP RECEPTACLE OUTLETS INSTALLED OUTDOORS, IN BATHROOMS, AND WITHIN 4' OF SINKS SHALL HAVE GROUND FAULT CIRCUIT INTERRUPTION.
- 7. EXTERIOR LIGHT FIXTURES SHALL COMPLY WITH ANY LOCAL OUTDOOR LIGHTING REQUIREMENTS.
- 8. OPENINGS IN WALLS, CEILINGS, AND FLOORS FOR ELECTRICAL BOXES, LINES, ETC.. SHALL BE CAULKED OR OTHERWISE SEALED AGAINST AIR, WATER, AND/OR INSECT INFILTRATION. VERIFY MATERIALS AND METHODS WITH ARCHITECT PRIOR TO SEALING. ELECTRICAL CONTRACTOR TO PROVIDE AND INSTALL ELECTRICAL OUTLET COVER PLATE GASKETS AT ALL EXTERIOR WALLS AND AS REQUIRED.
- 9. HEIGHTS INDICATED ON ELECTRICAL DRAWINGS INDICATE HEIGHTS ABOVE ADJACENT FINISH FLOOR ELEVATION.
- 10. ALL LIGHT CONTROLS SHALL BE PLACED NO HIGHER THAN 48" O.C. ABOVE THE FLOOR
- 11. ALL THERMOSTATS SHALL BE PLACED NO HIGHER THAN 54", O.C., ABOVE THE FLOOR.
- 12. THE EXCEPTIONS TO THESE PROVISIONS ARE AS FOLLOWS:
- A. ELECTRICAL RECEPTACLES SERVING A DEDICATED USE
 - B. APPLIANCE MOUNTED CONTROLS OR SWITCHES
 - C. SINGLE OUTLET WHERE ALL OF THE FOLLOWING CONDITIONS ARE MET:

 I. THE OUTLET IS ABOVE A LENGTH OF COUNTERTOP THAT IS UNINTERRUPTED BY A
 - SINK OR APPLIANCE AND
 - II. AT LEAST ON RECEPTACLE IS PROVIDED FOR THAT LENGTH OF COUNTERTOP

 III. ALL OTHER RECEPTACLES PROVIDED FOR THAT LENGTH OF COUNTERTOP SET NO
 - HIGHER THAN 48"

 D. FLOOR ELECTRICAL RECEPTACLES
 - E. PLUMBING FIXTURE CONTROLS
 - F. HVAC DIFFUSERS
 G. CEILING MOUNTED CONTROLS
- 13. MATERIALS AND EQUIPMENT SHALL BE INDEPENDENT LABORATORY LISTED (SUCH AS U.L.) AND THE INSTALLATION SHALL COMPLY WITH THE LISTING INSTRUCTIONS.
- 14. COMPLY WITH ELECTRICAL, TELEPHONE AND CABLE TELEVISION UTILITY COMPANY'S SERVICE REQUIREMENTS.
- 15. VERIFY EXACT LOCATIONS OF RADIANT HEATING AND PLUMBING EQUIPMENT, THERMOSTATS, CONTROLS, ETC. PRIOR TO ROUGH—IN AND COMPLY AS REQUIRED TO ACHIEVE A FULLY FUNCTIONAL AND AESTHETICALLY PLEASING INSTALLATION. VERIFY EQUIPMENT RATINGS (VOLTAGE, AMPERES, WATTAGE, MAXIMUM OVERCURRENT DEVICE SIZE, ETC.) AND COORDINATE FUSE OR CIRCUIT BREAKER SIZES, WIRE SIZES, ETC. AS REQUIRED FOR A FULLY FUNCTIONAL INSTALLATION.
- 16. COORDINATE WITH RADIANT HEAT, PLUMBING AND SPECIAL SYSTEMS CONTRACTORS TO PROVIDE ALL ELECTRICAL AND CONTROL CONNECTIONS FOR A FULLY FUNCTIONAL INSTALLATION.
- 17. ALL WIRING SHALL BE COPPER UNLESS NOTED OTHERWISE.
- 18. ELECTRICAL PANELS SHALL BE SQUARE "D" HOMELINE OR EQUAL GE, SIEMENS OR CUTLER HAMMER, CIRCUIT BREAKERS SHALL BE FULL SIZE (1" HIGH POLES), WHEN SHORT CIRCUIT RATINGS IN EXCESS OF 10,000A SYMMETRICAL ARE INDICATED UL LISTED SERIES TESTED EQUIPMENT MAY BE UTILIZED TO MEET THE REQUIRED SHORT CIRCUIT DUTY.
- 19. DISCONNECTS AND SWITCHES FOR MOTORS SHALL BE HORSEPOWER RATED, MOTORS SHALL BE PROTECTED BY PROPERLY SIZED FUSETRONS OR OTHER APPROVED MOTOR OVERLOAD PROTECTOR.
- 20. PROVIDE GROUND FAULT CIRCUIT INTERRUPTER (GFCI) RECEPTACLES AT LOCATIONS WHERE INDICATED, DO NOT USE FEED THROUGH TYPE GFCI DEVICES EXCEPT WHERE INDICATED.
- 21. WALL BOX DIMMERS SHALL BE LUTRON, LEVITON OR APPROVED EQUAL WITH WATTAGE RATING AT LEAST 125% OF CONNECTED LIGHTING LOAD. WHEN 3-WAY DIMMERS ARE INDICATED USE DIMMERS CAPABLE OF DIMMING LIGHTS FROM EITHER DIMMER LOCATION. WHEN LOW VOLTAGE LIGHTING FIXTURES ARE CONTROLLED BY DIMMER USE DIMMER DESIGNED FOR USE WITH LOW VOLTAGE TRANSFORMERS.
- 22. LIGHTING FIXTURES SHALL BE AS SELECTED BY ARCHITECT AND OWNER, COMPLETE WITH LAMPS, GLASSWARE, ETC. FOR A COMPLETE AND FINISHED INSTALLATION.
- 22.1. CEILING FIXTURES SHALL BE COMPATIBLE WITH THE CEILING CONSTRUCTION.22.2. RECESSED FIXTURES SHALL BE LISTED FOR DIRECT CONTACT WITH CEILING INSULATION.
- 22.3. IN CLOSETS, FIXTURES SHALL BE RECESSED TYPE WITH FLAT LENS.
 22.4. WHEN MOUNTED OVER BATHTUBS OR IN SHOWERS FIXTURES SHALL BE LISTED FOR WET LOCATIONS.
- 23. ELECTRICAL CONTRACTOR TO REVIEW ELECTRICAL FIXTURE LAYOUT WITH ARCHITECT PRIOR TO INSTALLATION.
- 24. ALL BRANCH CIRCUITS THAT SUPPLY 120 VOLT, SINGLE PHASE, 15 AND 20 AMPERE RECEPTACLES INSTALLED IN HOUSE SHALL BE PROTECTED BY ARC—FAULT CIRCUIT INTERRUPTERS PER 2018 IRC E3902.12.
- 25. SMOKE DETECTORS SHALL BE 120VAC TYPE WITH INTEGRAL BATTERY BACK-UP AND ALARM SIGNAL. SMOKE DETECTORS SHALL BE INTERCONNECTED SO ALL UNITS SOUND ALARM WHEN ANY DETECTOR IS IN ALARM.
- 26. PROVIDE COMPLETE PRE-WIRE OF TELEPHONE, CABLE TV, SOUND, INTERCOM, ETC. AS REQUIRED TO ALL HABITABLE ROOMS. COORDINATE EXACT REQUIREMENTS AND OUTLET LOCATIONS WITH ARCHITECT.

LIGHTING LE SYMBOL	GEND DESCRIPTION
0	RECESSED (4")
© EX	EXTERIOR RECESSED (4")
	UNDERCABINET LIGHT

ELECTRICAL LEGEND SYMBOL DESCRIPTION

==	DUPLEX RECEPTACLE
	QUADRAPLEX RECEPTACLE
 	GROUND FAULT CIRCUIT INTERUPTER
\Rightarrow_{WP}	WEATHER PROOF RECEPTACLE
- SW	SWITCHED RECEPTACLE
→ SW	1/2 SWITCHED RECEPTACLE
•	FLOOR RECEPTACLE

- \$ SWITCH
- ф 3 WAY DIMMER SWITCH
- b DIMMER SWITCH
- EXHAUST FAN
- (SD) SMOKE & CARBON MONOXIDE DETECTOR
- JUNCTION BOX
- DATA
- FUSED DISCONNECT
- ☐☐☐ DISCONNECT
- NOTE: UNLESS OTHERWISE INDICATED, MOUNT CENTER OF
- 1. RECEPTACLES: +8" HORIZONTAL, TYP.
- SWITCHES: +42" AND STARTING 8" FROM EDGE OF WALL/OPENING, TYP.
 RECEPTACLES @ BATHROOM COUNTERS: GANG WITH SWITCHES +42"
- 4. THERMOSTATS: +45"

LOAD CALCULATION PANEL	"A"		
EXISTING LOAD 1,605 SQ FT		NEW LOAD	
GENERAL LOAD = 1,605 SQ FT x 3 2-SMALL APPLIANCE CIRCUITS LAUNDRY BATHROOM CIRCUIT	4,815 WATTS 3,000 1,500 1,500	GENERAL LOAD = 1168 SQ FT x 3 2 SMALL APPLIANCE CIRCUITS LAUNDRY BATHROOM CIRCUIT	3,504 WATTS 3,000 1,500 1,500
TOTAL	10,815	TOTAL	9,504
1ST 10K AT 100% REMAINDER AT 40%	10,000 326	1ST 10K AT 100%	9,504
AC LOAD AT 100%	9,500	AC LOAD AT 100%	9,500
TOTAL LOAD	19,826/ 240V=83 AMPS	TOTAL LOAD	19,004/ 240V=79.18 AMPS< 100A PANEL OK

PANEL "A" SCHEDULE EXISTING 100 AMP W/ METER SERVICE						
#	С	DESCRIPTION		#	С	DESCRIPTION
1	20	NEW FRIDE	2P 50	9A	20	EXISTING ENTRY LIGHTS
2	20	EXISTING AC	2P 50	9B	20	NEW KITCHEN LIGHTS
3	20	EXISTING AC	1P 20	9C	20	NEW PATIO LIGHT
4A	20	NEW KITCHEN (COUNTER)	1P 20	-	-	-
4B	20	NEW KITCHEN (WINEFRIDGE)	1P 20	-	-	-
5A	20	WASHER / DRYER	1P 20	-	-	-
6	20	NEW DISHWASHER DISPOSAL	1P 20	-	-	-
7	20	MAIN HOUSE	2P 100	-	-	-
8	20	MAIN HOUSE	2P 100	-	-	-
9	20	LIGHTING	1P 20	-	-	-
10	20	FRONT ROOM RECEPTS	1P 20	-	-	-
11	30	DINING ROOM RECEPTS	1P 20	-	-	-
12	20	NEW RANGE HOOD	1P 100	-	-	-

LOAD CALCULATION PAI	NEL "B"		
EXISTING LOAD		NEW LOAD	
GENERAL LOAD = 768X3 2-SMALL APPLIANCE KIT	2,304 WATTS 3,000	GENERAL LOAD = 915 x 3	2,745 WATTS
TOTAL	5,304	BATHROOM CIRCUIT	1,500
TOTAL LOAD	5,304/ 240=22.1 AMPS	TOTAL NEW LOAD	4245/240< 17.68 AMPS 100 AMP PANEL OK
	= == == == == == == == == == == == == =		

PANEL "B" SCHEDULE				
EXISTING 100 AMP W/ METER SERVICE				
#	С	DESCRIPTION		
1	20	NEW CASEMENT LIGHTS	2P 100	
2	20	NEW CLOSET LIGHTS	2P 100	
3	20	NEW BEDROOM LIGHTS	2P 100	
4	20	NEW BATHROOM LIGHTS	2P 100	
5	20	NEW PATIO LIGHT	-	
6	20	NOT USED	-	
7	20	MAIN	2P 100	
8	20	MAIN	2P 100	
9	20	LIGHTING	-	
10	20	BATH GFCI	-	
11	20	STUDY RECEPTS	-	
12	30	BEDROOM RECEPTS	-	
13	20	NOT USED	-	
14	20	NOT USED	-	

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Revision: Date:

Keynotes:

Consultants:

Schneider Structural Engineers
435 E. 9th Street
Tucson, AZ 85705

520-429-7080



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Project Name:

Baylor Residence

492 S Convent Ave, Tucson, AZ 85701

JANUARY 07 2022

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Scale:

Drawing Title:

ELECTRICAL
NOTES

Sheet No.: **E1.00**



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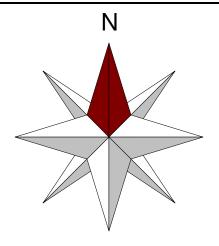
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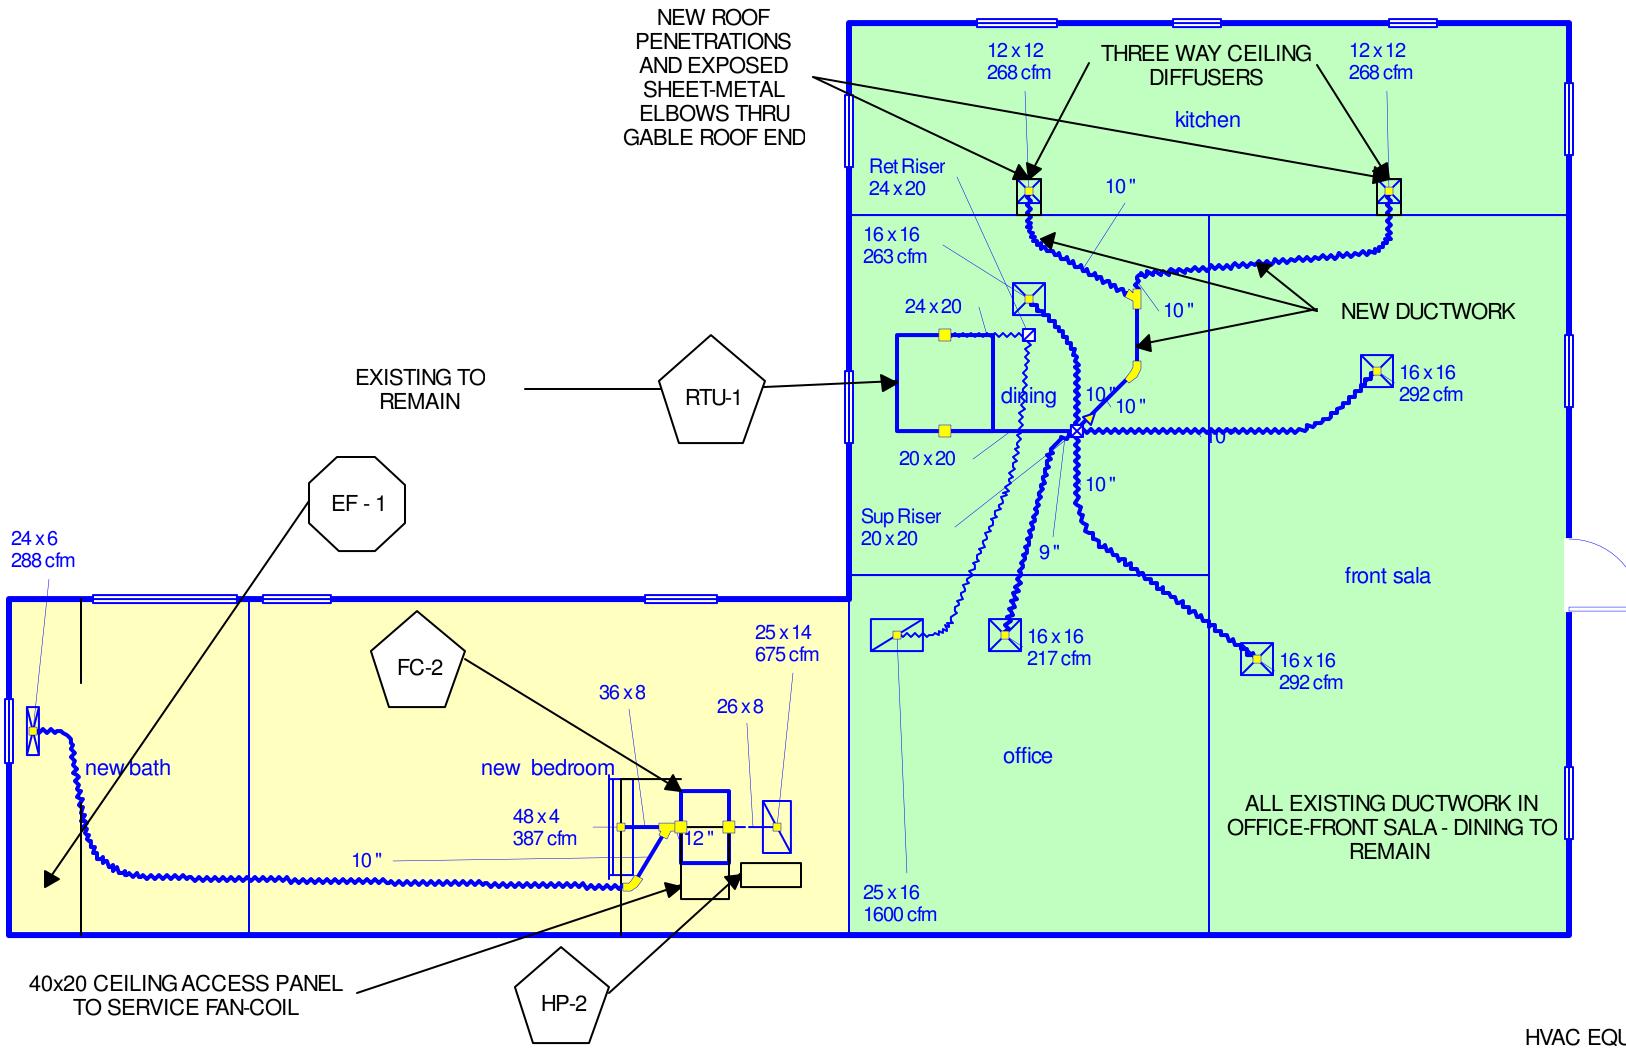
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Drawing Title:

ELECTRICAL & LIGHTING PLAN

Sheet No.: E1.01





EF - 1 CONTINUOUS OPERATION FAN TO MEET FRESHAIR REQUIREMENTS PER 2018 IRC TABLE M1505.4.3 ASHRAE 62.2

MAIN HOUSE FAN SET TO 60 CFM EACH

PANASONIC FV-0511VK2 50-80-110 CFM, 0.3 SONES, 120 VOLT, 0.1 AMPS, 6-INCH DUCTING DIMENSIONS: 11" X 11" X 7.5" HIGH FV-VS15VK1 MODULE: MULTI-SPEED RELAY REQUIRES TWO SWITCHES SPECIAL WIRING

HVAC EQUIPMENT SCHEDULE:

ZONE NAME = HP-2 / FC-2 (NEW)

DAIKIN CEILING-MOUNTED DUCTED MINI-SPLIT FAN-COIL

18,000 BTU / 18.5 SEER / 12.70 EER

HP-1 = DAIKIN RX18RMVJU (ROOFTOP MOUNTED ON REDWOODS)

FC-1 = DAIKIN FDMQ18RMVJU (HANG FROM ROOF STRUCTURE)

COOLING / HEATING CAPACITY: 11,500 BTU SENSIBLE COOLING @ DESIGN 18,700 BTU HEATING OUTPUT @ DESIGN

INDOOR FAN AIRFLOW PERFORMANCE: 675 CFM @ 0.4" AVSP

ELECTRICAL CIRCUIT REQUIREMENTS: HP = 208-230/1PH/60HZ - 13 MCA - 15 AMP FUSES FC = 208-230/1PH/60HZ 1.0 MCA - 15 AMP FUSES

PHYSICAL DIMENSIONS (IN INCHES): 32.50 (W) X 12.00 (D) X 29.00 (H) - CONDENSER 42.0 (W) X 32.0 (D) X 10.0 (H) - FAN COIL MUST INCLUDE BRC1E73 WALL MOUNTED CONTROLLER

HVAC EQUIPMENT SCHEDULE:

ZONE NAME = RTU-1 (EXISTING)

RTU-1 = AMERICAN STANDARD 4WCZ6048B1000A PACKAGED HEAT PUMP UNIT (ALL ELECTRIC) WITH 5KW HEAT STRIP MODEL BAYHTRV105F

4.0 TON / 16.00 SEER / 12.00 EER / AHRI = 7180052

COOLING / HEATING CAPACITY: 31,100 BTU SENSIBLE COOLING @ DESIGN 29,400 BTU HEATING CAPACITY @ DESIGN

INDOOR FAN AIRFLOW PERFORMANCE: 1,600CFM @ 0.50" AVSP

ELECTRICAL CIRCUIT REQUIREMENTS: UNIT = 208-230/1PH/60HZ - 34.2 MCA - 50 AMP FUSES 5KW = 208-230/1PH/60HZ - 26.0 MCA - 30 AMP FUSES

PHYSICAL DIMENSIONS (IN INCHES): 60.50 (W) X 46.25 (D) X 41.50 (H) REQUIRED CLEARANCES PER SUBMITTAL

Job #: Performed for:

BOLEYN BAYLOR 492 S CONVENT AVE Tucson, AZ 85701

Hamstra Heating & Cooling Inc

4389 N Highway Dr Tucson, AZ 85705 Phone: 520-629-9833 Scale: 1/4" = 1'0"

Page 1
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GENERAL PLUMBING NOTES

- 1. ALL WORK WILL MEET CURRENT 2018 I.R.C., LOCAL CODES AND UTILITY COMPANY REQUIREMENTS, IF A CONFLICT EXISTS BETWEEN THE PLAN AND APPLICABLE REGULATION, CONTRACTOR IS TO NOTIFY THE ARCHITECT BEFORE PROCEEDING WITH
- 2. PLUMBING & GAS PLAN IS DIAGRAMMATIC FOR THE PURPOSE OF SIZING SYSTEMS ONLY. PLUMBING CONTRACTOR TO BE RESPONSIBLE FOR FINAL DESIGN AND LAYOUT PER CODE
- 3. CONTRACTOR TO PROVIDE A COMPLETELY OPERATIONAL SYSTEM WHETHER OR NOT ALL COMPONENTS ARE SHOWN ON PLAN
- 4. VERIFY LOCATION AND CONDITION OF EXISTING WATER, GAS AND SEWER LINES.
- 5. COORDINATE ALL WORK WITH ALL OTHER TRADES; EXACT ROUTING SHALL BE COORDINATED WITH ALL STRUCTURAL CONDITIONS.
- 6. V.T.R.s SHALL BE GANGED TOGETHER WHERE APPROPRIATE TO MINIMIZE ROOF PENETRATIONS.
- 7. ALL PLUMBING FIXTURES TO CONFORM TO CURRENT WATER CONSERVATION CODES.
- 8. OFFSET ALL PLUMBING VENTS AS REQUIRED TO ENSURE 10'-0" MIN. CLEARANCE FROM ALL OUTSIDE AIR INTAKES.
- 9. ALL GAS PIPES THROUGH CONCRETE TO BE SLEEVED AND VENTED PER IRC G2415.6 &
- 10. WATER HEATER(S) TO HAVE TEMPERATURE AND PRESSURE RELIEF VALVE WITH VENT LINE TO EXTERIOR DAYLIGHT @ 6"-24" ABOVE FINISH GRADE, FACING DOWN.
- 11. WATERPROOF MATERIALS A MINIMUM OF 72" ABOVE THE SHOWER DRAIN.
- 12. SHOWER ENCLOSURES SHALL HAVE A MINIMUM FINISHED INTERIOR OF 30" EACH WAY.
- 13. WATER HAMMER ARRESTORS TO BE INSTALLED IN ACCORDANCE WITH ASSE 1010-2004 ON WATER LINES SERVING APPLIANCES EQUIPPED WITH QUICK-CLOSING VALVES. TO INCLUDE BUT NOT LIMITED TO: CLOTHES WASHERS, DISHWASHERS AND REFRIGERATORS.
- 14. VERIFY HOSE BIBB LOCATIONS WITH ARCHITECT AND/OR CONSTRUCTION MANAGER AND PROVIDE BACKFLOW PREVENTERS.
- 15. FLASH AND COUNTER-FLASH ALL PENETRATIONS THROUGH ROOF FOR WATERTIGHT
- 16. ALL PIPE, CONDUIT AND DUCT RUNS SHALL BE PLACED UNDER ROOF. NO LINES SHALL RUN OVER WITHOUT WRITTEN APPROVAL OF THE OWNER.
- 15. TEST PLUMBING SYSTEMS AS RECOMMENDED BY GOVERNING CODE PRIOR TO CLOSING IN OF EACH SYSTEM.
- 16. FURNISH AND INSTALL ANY MISCELLANEOUS ITEMS REQUIRED TO PROVIDE A COMPLETE AND FUNCTIONAL SYSTEM. THE DRAWINGS ARE SCHEMATIC IN NATURE AND DO NOT SHOW EVERY OFFSET, TRANSITION, FITTING, ETC. THAT MAY BE REQUIRED FOR A COMPLETE AND WORKING SYSTEM.
- 17. EXACT LOCATION OF PLUMBING FIXTURES DETERMINED FROM ARCHITECTURAL DRAWINGS. COORDINATE WITH OTHER TRADES.
- 18. VENTS AND EXHAUST AIR THROUGH ROOF LOCATED A MINIMUM DISTANCE OF 10 FEET FROM ANY MAKE-UP AIR OR SUPPLY DEVICES.
- 19. FURNISH 2 COPIES OF SHOP DRAWINGS AND MAINTENANCE AND WARRANTY
- 20. WATER PIPING TYPE "L" COPPER UNDER SLAB, NO JOINTS. TYPE "M" ABOVE PVC SCHEDULE 40 OUTSIDE BUILDINGS. COPPER FITTINGS SHALL BE SOLDERED WITH A LEAD FREE 95/5 SOLDER.
- 21. PROVIDE WATER SHUT OFF 1/4 TURN ANGLE STOPS AT EACH FIXTURE. 22. SOIL PIPE SCHEDULE 40 ABS, VENT PIPING SCHEDULE 40 ABS.
- 23. PROVIDE CHROME COVERS FOR WALL CLEANOUTS. COORDINATE LOCATION OF WALL CLEANOUTS WITH ARCHITECT.
- 24. PROVIDE MECHANICAL GAS SHUTOFF VALVES ON ALL GAS SERVICES.
- 25. SHOWERS AND TUB/SHOWER COMBINATIONS SHALL BE PROVIDED WITH INDIVIDUAL CONTROL VALVES OF THE PRESSURE BALANCED OR THERMOSTATIC MIXING VALVE TYPE.
- 26. ALL HOT AND COLD WATER LINES 1/2" U.N.O.
- 27. HOT WATER PIPING SHALL BE INSULATED WITH 1" R-4 INSULATION MINIMUM.
- 28. SEAL ALL PENETRATIONS THROUGH EXTERIOR WALLS. BELOW AND ABOVE GRADE
- 29. PROVIDE WATER SHUTOFF VALVES AT ALL LAV'S, SINKS AND WC'S
- 30. WATER SYSTEM TO BE UPONOR OR WATTS PEX, INSTALLED ACCORDING TO INSTRUCTIONS. WATER PIPING TO BE ABOVE GROUND EXCEPT WHERE REQUIRED TO BE UNDERGROUND.
- 31. HOSE BIBBS TO BE FREEZEPROOF FREE HYDRANTS, WATTS HY500VB WITH VACUUM BREAKER MOUNT IN 12X12 SLAB ON GRADE. INSTALL PER MANUF. WITH 2' DEPTH OF BURIAL. PROVIDE KEY IN EACH HB BOX.
- 32. GROUND DRAIN PIPING TO BE ABS
- 33. WC'S TO BE 1.6 GPF MAX AND TO BE DUAL FLUSH
- 34. P&T RELIEF LINE TO BE HARD DRAWN COPPER TUBING EXTENDING OUTSIDE BUILDING AND TERMINATING IN A DOWNWARD POSITION NOT MORE THAN 2 FEET NOR LESS THAN 6" ABOVE GRADE
- 35. CONTRACTOR TO MAINTAIN A SET OF REDLINED AS BUILTS FOR REVIEW AND TO PROVIDE A COPY TO OWNER COMPLETION OF THE PROJECT

plumbing plan

EXISTING WATER SUPPLY & DRAINAGE FIXTURE UNIT CALCULATIONS							
	WATER-	-SUPPLY FIXTURE UN	IT VALUE (W.S.F.U)				
FIXTURE	QTY	НОТ	COLD	COMBINED	TOTAL W.S.F.U	D.F.U./FIXTURE	TOTAL D.F.U.
WATER CLOSET (1.6 GPF)	2	_	2.2	2.2	6.6	3	9
LAVATORY	2	0.5	0.5	.7	2.1	1	3
SHOWER/TUB	2	1.0	1.0	1.4	2.8	2	4
KITCHEN SINK	2	1.0	1.0	1.4	1.4	2	2
WASHER	1	1.0	1.0	1.4	1.4	2	2
HOSE BIBB	APP. 4		2.5	2.5	12.5		22

EXISTING FIXTURE UNITS FOR DWELLING

TOTAL FIXTURE UNITS FOR DWELLING

PRESSURE = 55 PSI STATIC ASSUMED.

- METER SIZE 1". PLUMBING SUBCONTRACTOR TO VERIFY IN FIELD AND SIZE DISTRIBUTION SYSTEM ACOORDING TO CURRENT CODES AND STANDARDS.
- ESTIMATED DEVELOPED PIPE LENGTH FROM MAIN HOUSE TO SERVICE ENTRY= 490'x1.2 = 588'
- ESTIMATED DEVELOPED INTERIOR PIPE LENGTH FROM SERVICE ENTRY = 160'
- TOTAL ESTIMATED DEVELOPED PIPE LENGTH = 748

TOTAL LOTTINIATED L		LLINOIII — /+C	,
1/2" PIPE TO ALL	FIXTURES U.O.N	NOR SPECIFIED	BY MANUFACTURER

PLUMBING FIXTUR	ES			
LOCATION	MANUF.	UNITS	PRODUCT NUMBER	NOTE
SHOWER	KOHLER	1	K-22181-G	WALL MOUNT
LAV SINKS	KOHLER	1	K-2882	UNDERMONT
LAV FAUCET	KOHLER	1	K-14406-4	DECK MNT
SHOWER DRAIN	INFINITY	1	SAS-6536 SS	FLUSH
KITCHEN SINK	KOHLER	1	K-5286	UNDERMOUNT
DISPOSAL	INSINKERATOR	1	PRO1000LP	1 HP
KITCHEN FAUCET	HANSGROHE	1	10821801	PULL DOWN
TOILET	тото	1	CST416M#11	DUAL FLUSH
TOILET SEAT	тото	1	SS114#01	SOFT CLOSE
TUB	VICTORIA + ALBERT	1	VETRALLA 1500	FLOOR MOUNT
TUB FAUCET	BRIZO	1	T704	WALL MOUNT

	WATER-SU	JPPLY FIXTURE UN	NIT VALUE (W.S.F.U)				
FIXTURE	QTY	НОТ	COLD	COMBINED	TOTAL W.S.F.U	D.F.U./FIXTURE	TOTAL D.F.U
WATER CLOSET (1.6 GPF)	1		2.2	2.2			9
LAVATORY	1	0.5	0.5	.7	6.6	3	3
SHOWER/TUB	2	1.0	1.0	1.4	2.1	1	4
KITCHEN SINK	1	1.0	1.0	1.4	2.8	2	2
WASHER	1	1.0	1.0	1.4	1.4	2	2
HOSE BIBB	TBD		2.5	2.5	1.4	2	
NEW FIXTURE UNITS FOR DV							6
OTAL FIXTURE UNITS FOR D	WELLING						6

- WASTE TIE-IN

 \sim 2 WAY CLEANOUTS 3"

— NEW ¾" TEE FOR KITCHEN

PRESSURE = 55 PSI STATIC ASSUMED.

EXISTING CITY WATER LINE

EXISTING 3" CITY WASTE LINE


METER SIZE - 1". PLUMBING SUBCONTRACTOR TO VERIFY IN FIELD AND SIZE DISTRIBUTION SYSTEM


ACOORDING TO CURRENT CODES AND STANDARDS. ESTIMATED DEVELOPED PIPE LENGTH FROM MAIN HOUSE TO SERVICE ENTRY= 490'x1.2 = 588'

ESTIMATED DEVELOPED INTERIOR PIPE LENGTH FROM SERVICE ENTRY = 160'

TOTAL ESTIMATED DEVELOPED PIPE LENGTH = 748'

1/2" PIPE TO ALL FIXTURES U.O.N. OR SPECIFIED BY MANUFACTURER

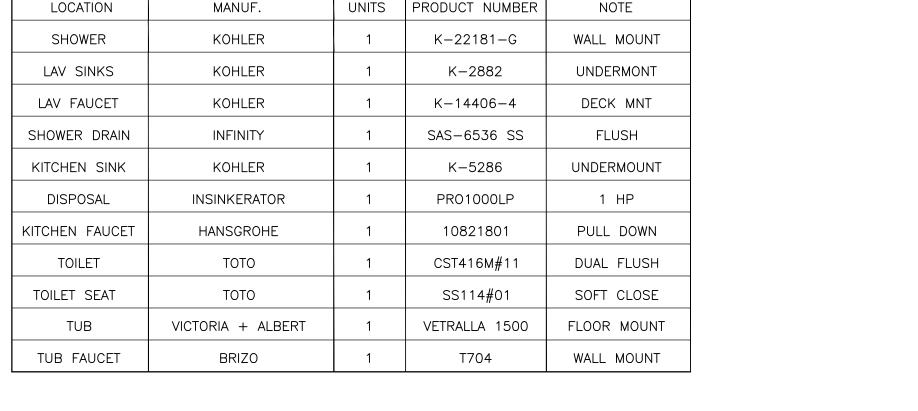

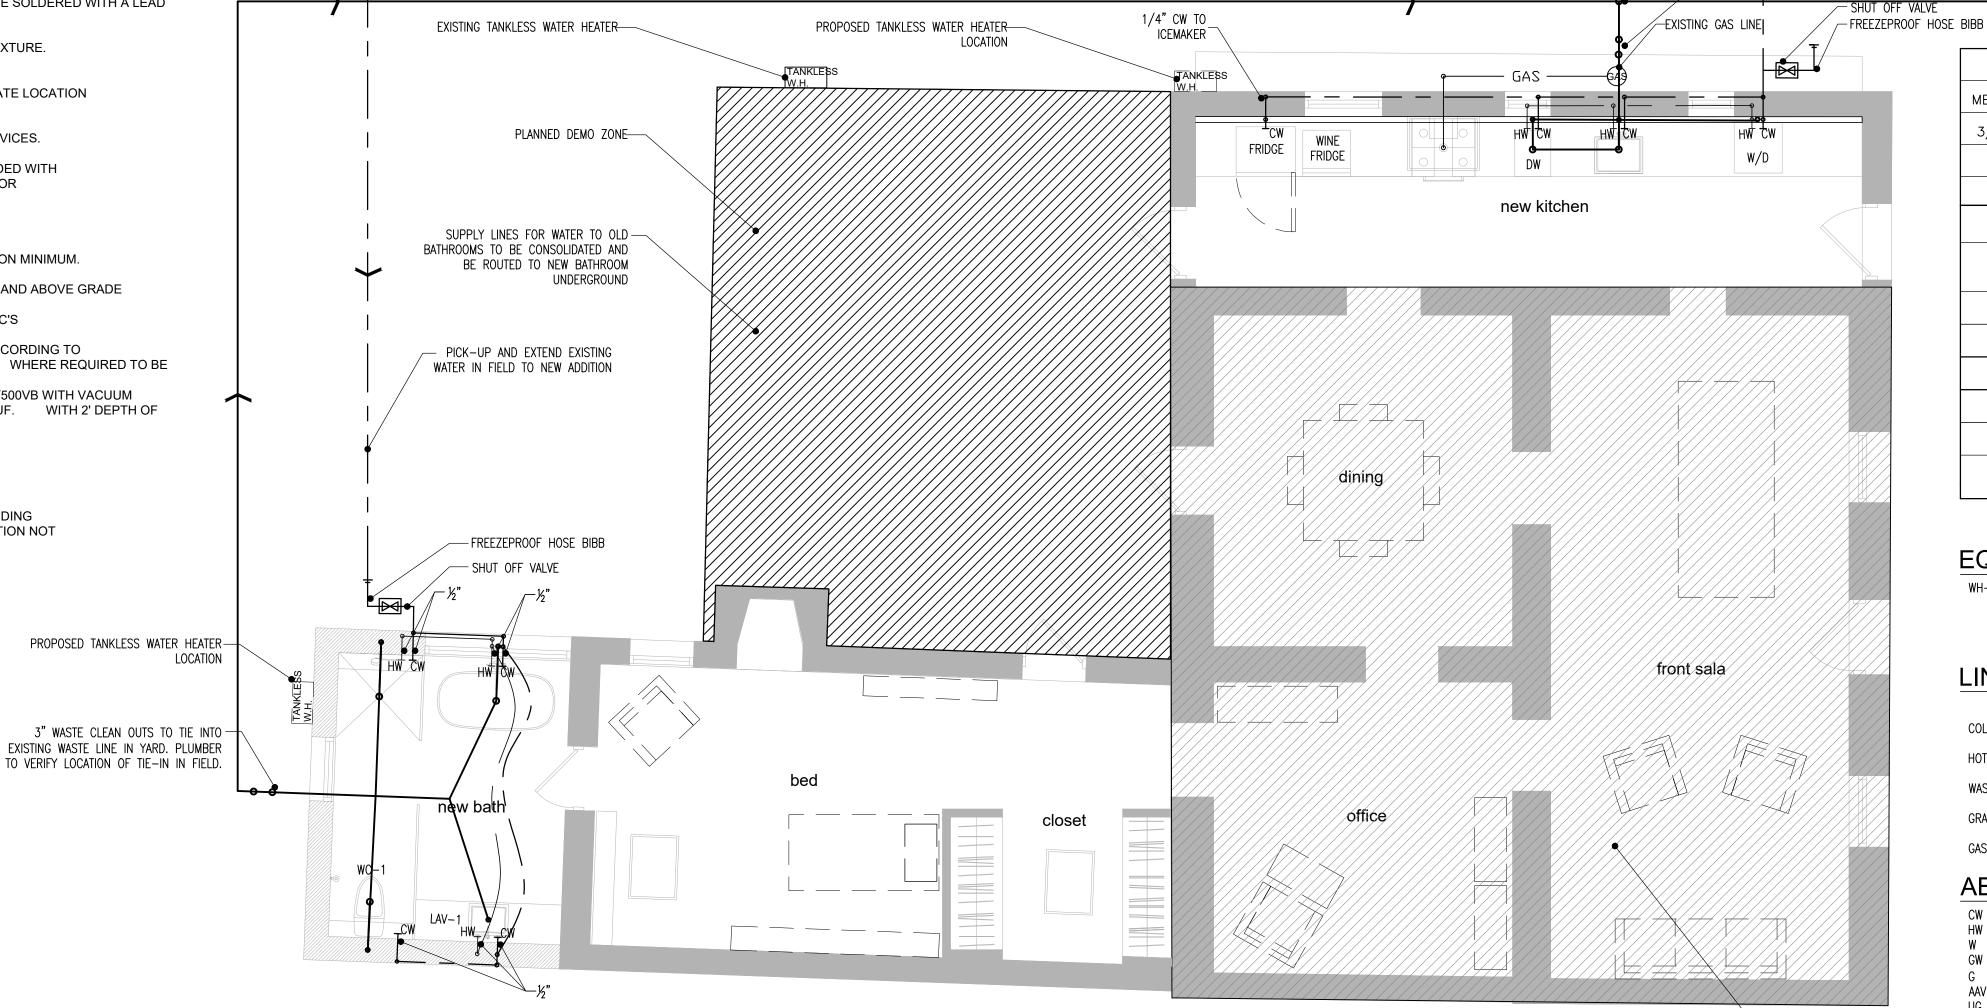

	WATER PIPE CAPACITY SIZING TABLE AP201.1 IRC				
METER	DIST. PIPE	DEVELOPED LE	NGTH	FIXTUF	RE UNITS
3/4"	1-1/4"	500'			24
1"	1-1/4"	500'			28
1"	1-1/2"	500'			70
G/	AS LOAD				
	DESCRIPTION	LENGTH	E	BTU's	CFH
WATER HEATER #1		20'	1	99K	199
LOG LIGHTER		200'	25K		25
GAS DRYER		50'	2	220K	220
	GAS RANGE	180'	5	520K	520

180'

PRIMARY PIPE SIZE PER I.R.C. TABLE G2413.4 = 3/4" TO 400' FROM REGULATOR.

520K

520

-EXISTING ⅔" WATER METER

EQUIPMENT SCHEDULE

1" TO 125' FROM REGULATOR TO FIRST "T"

TOTALS

WH-1 EXISTING RINNAI 180K BTU TANKLESS GAS WATER

LINE LEGEND		
COLD WATER		
HOT WATER		
WASTE		
GRAYWATER		
GAS		

ABBREVIATIONS

COLD WATER
HOT WATER
WASTE
GRAYWATER
GAS (PROPANE)
AID ADMITTANIOÉ

AIR ADMITTANCE VALVE UNDERGROUND OVERHEAD PERF PERFORATED

CLEAN OUT

Revision: Date:

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DUST Drawn By: 1/4"=1"

> Drawing Title: PLUMBING PLAN

P1.00