### ELECTRICAL HY-LITE DESIGN 4500 N. CAMINO CARDENAL TUCSON, AZ 85718 520-760-9301

## STRUCTURAL JIM GALVIN

11441 N. INGOT LOOP ORO VALLEY, AZ 85737 520-797-5567

## SHEET INDEX

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G002	SYMBOLS, CLEARANCES, NOTES, & ABBREVATIONS	L5	IRRIGATION PLAN
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G005	SIDEWALK PLAN	AD100	DEMO PLAN
G007	SIGHT VISIBLITY TRIANGLE	A100	PATIO PLAN
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L2	LANDSCAPE SCHEDULES + DETAILS	A300	PATIO WALL ELEVATIONS
L3	LANDSCAPE DETAILS	A400	SECTIONS



SIMPSON ST.

# TEATRO CARMEN PATIO PROJECT - 75% CDs

## LANDSCAPE ARCHITECT

JENNIFER PATTON 2738 E. ADAMS STREET TUCSON, AZ 85716 520-320-3936

## ARCHITECT POSTER MIRTO MCDONALD 317 N. COURT AVE TUCSON, AZ 85701 520-882-6310 WWW.PMM.DESIGN

## DEVELOPER


STRATFORD ART WORKS INC 308 E. 2ND ST. TUCSON, AZ 85705 520-204-2240 WWW.STRATFORDARTWORKS.ORG

# **PROJECT PARTNERS**



Landscape Architects




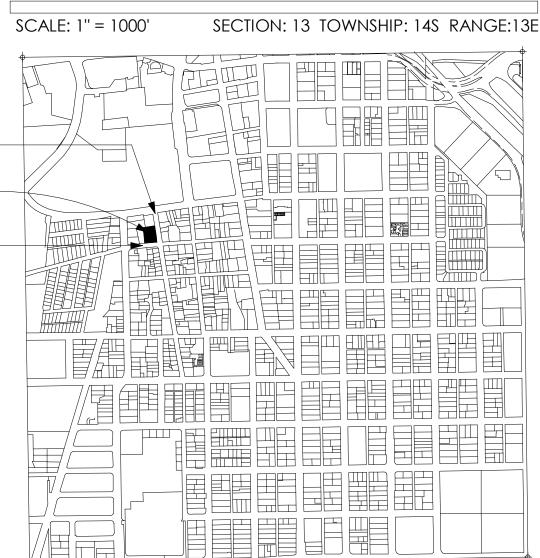

MEYER AVE.

PROJECT LOCATION

SIMPSON ST

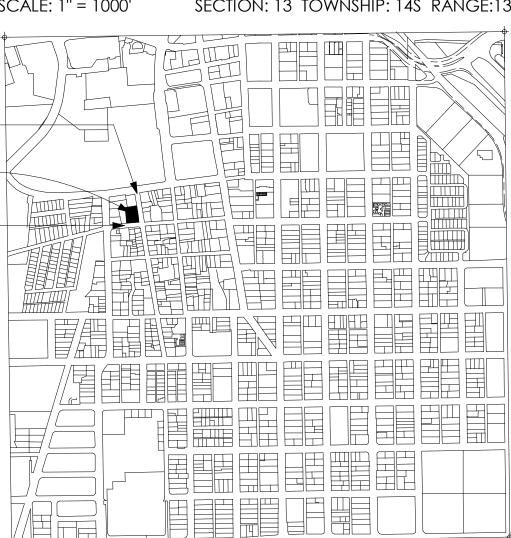

# **PROJECT TEAM**

PROJECT OWNER PIMA COUNTY 150 W. CONGRESS TUCSON, AZ 85701 520-724-3171

# PROJECT ADDRESS

380 & 384 S. MEYER AVE TUCSON, AZ 85701

TUCSON S PT OF L 10 BEING 84.315' ON E & 80.52' ON W BLK 228

TUCSON NORTH PART LOT 10 & E32' M/L LOT 11 BLK 228

# PROJECT DESCRIPTION

DEVELOPMENT OF NEW EXTERIOR PATIO, INFRASTRUCTURE, LANDSCAPING AND WALL ALONG PROPERTY LINE.

# **PROJECT MAP**



POSTER MIRTO McDONALD 317 N. COURT AVE. TUCSON, AZ 85701 PH 520.882.6310 | WWW.PMM.DESIGN



TEATRO CARMEN REHABILITATION OF HISTORIC THEATER 380 S. MEYER AVE. - TUCSON, AZ 85701

G000

TITLE SHEET

DRAWN BY: Author REVISIONS CHECKED BY: Checker NO. DATE

ISSUE


#### COMMON ABBREVIATIONS

		HORZ	
	ANCHOR BOLT	-	HORIZONTAL
ABV	ABOVE	HT	HEIGHT
ACT	ACOUSTICAL CEILING TILE	ID	INSIDE DIAMETER
	ADJUSTABLE	INCL	
			INCLUDE(D), INCLUDING
\FF	ABOVE FINISHED FLOOR	INT	INTERIOR
AHU	AIR HANDLING UNIT	JAN	JANITOR'S CLOSET
-			
	ALTERNATE	KIT	KITCHEN
ALUM	ALUMINUM	LAV	LAVATORY
APPROX	APPROXIMATE	L	LENGTH
-			-
	ARCHITECT(URAL)	LF	LINEAR FOOT
3D	BOARD	LT	LIGHT
	BELOW	LVP	LUXURY VINYL PLANK
	-		
BLDG	BUILDING	MAS	MASONRY
3LK	BLOCK	MFR	MANUFACTURER
BLKG	BLOCKING	MFD	MANUFACTURED
BM	BEAM	MAX	MAXIMUM
BR	BEDROOM	MECH	MECHANICAL
		-	
BOT	BOTTOM	MTL	METAL
BRG	BEARING	MIN	MINIMUM
BTWN	BETWEEN	MT	MOUNT
BUR	BUILT UP ROOF	Ν	NORTH
CAB	CABINET	NIC	NOT IN CONTRACT
CFL	COUNTER FLASHING	NOM	NOMINAL
CJ	CONTROL JOINT	NTS	NOT TO SCALE
CLG	CEILING	OC	ON CENTER
CLR	CLEAR	OD	OUTSIDE DIAMETER
COL	COLUMN	OH	OVERHEAD
CMU	CONCRETE MASONRY UNIT	OPNG	OPENING
CONC	CONCRETE	OPP	OPPOSITE
CONST	CONSTRUCTION	PROP	PROPERTY
CONT	CONTINUOUS	PLAM	PLASTIC LAMINATE
CONTR	CONTRACTOR	PLBG	PLUMBING
CP	CONTROL PANEL	PLF	POUNDS PER LIN FOOT
COORD	COORDINATION	PL	PLATE
CORR	CORRIDOR	PR	PAIR
CPT	CARPET	PSF	POUNDS PER SQ FOOT
CT	CERAMIC TILE	PSI	POUNDS PER SQUARE INCH
)G	DECOMPOSED GRANITE	PT	POINT
DTL(S)	DETAIL(S)	PVC	POLYVINYL CHLORIDE
)P `́	DEVELÒPMENT PACKAGE	PVMT	PAVEMENT
)F			
	DRINKING FOUNTAIN	RA	RETURN AIR
	DIAMETER	RAD	RADIUS
DIM	DIMENSION	RB	RUBBER BASE
ON	DOWN	RD	ROOF DRAIN
	DRAWING	REF	REFERENCE
EA	EACH	REQD	REQUIRED
EJ	EXPANSION JOINT	RM	ROOM
	ELEVATION	RO	ROUGH OPENING
ELEC	ELECTRIC(AL)	ROW	RIGHT OF WAY
EMER	EMERGENCY	RWL	RAINWATER LEADER
	ENCLOSURE	SC	
			SOLID CORE
	EQUAL	SECT	SECTION
EQ			
eq Equip	EQUIPMENT	SF	SQUARE FOOT
EQ EQUIP EXIST		SF SHT	
EQ EQUIP EXIST	EQUIPMENT EXISTING	SF SHT	SQUARE FOOT
EQ EQUIP EXIST EXH	EQUIPMENT EXISTING EXHAUST	SF SHT SIM	SQUARE FOOT SHEET SIMILAR
EQ EQUIP EXIST EXH EXP	EQUIPMENT EXISTING EXHAUST EXPANSION	SF SHT SIM SPEC	SQUARE FOOT SHEET SIMILAR SPECIFICATION
EQ EQUIP EXIST EXH EXP EXT	EQUIPMENT EXISTING EXHAUST EXPANSION EXTERIOR	SF SHT SIM SPEC SQ	SQUARE FOOT SHEET SIMILAR SPECIFICATION SQUARE
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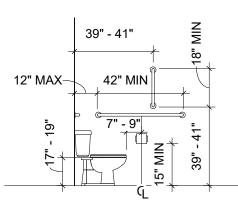
#### GENERAL NOTES


- ALL WORK AND MATERIALS SHALL BE IN FULL ACCORDANCE WITH THE REQUIREMENTS OF THE CODES AND ALL APPLICABLE LOCAL ORDINANCES. WHERE CONTRACT DOCUMENTS EXCEED SUCH REQUIREMENTS. WITHOUT VIOLATING SUCH CODES, REGULATIONS AND ORDINANCES, CONTRACT DOCUMENTS TAKE PRECEDENCE. WHERE CODES CONFLICT, THE MORE STRINGENT SHALL APPLY.
- DURING THE CONSTRUCTION PERIOD, IT SHALL BE THE SOLE RESPONSIBILITY OF THE CONTRACTOR TO MAINTAIN CONDITIONS AT THE PROJECT SITE AND TO MEET THE REQUIREMENTS OF THE FEDERAL OCCUPATIONAL SAFETY AND HEALTH ADMINISTRATION (OSHA). THIS PROVISION SHALL COVER THE CONTRACTOR'S EMPLOYEES AND ALL OTHER PERSONS WORKING UPON OR VISITING THE SITE. THE CONTRACTOR SHALL BECOME FULLY INFORMED OF ALL APPLICABLE STANDARDS AND REGULATIONS AND INFORM ALL PERSONS AND REPRESENTATIVES RESPONSIBLE FOR WORK UNDER THIS CONTRACT.
- CONFIRM ALL NEW AND EXISTING CONDITIONS WITH THE CONTRACT DOCUMENTS. - 3 NOTIFY ARCHITECT IMMEDIATELY IN WRITING OF ALL DISCREPANCIES OR CONFLICTS. DO NOT PROCEED WITH WORK IN THE AREA OF DISCREPANCY OR CONFLICT UNTIL DIRECTION IS GIVEN BY ARCHITECT. IF THE CONTRACTOR PROCEEDS WITHOUT DIRECTION FROM ARCHITECT, IT SHALL BE AT CONTRACTORS RISK, AND CONTRACTOR SHALL BE RESPONSIBLE FOR ALL REQUIRED CORRECTIVE ACTION.
- REVIEW THE ARCHITECTURAL DRAWINGS BEFORE THE INSTALLATION OF SYSTEMS 4. SHOWN ON CONSULTING ENGINEERS DOCUMENTS. DISCREPANCIES BETWEEN THE ARCHITECTURAL AND CONSULTING ENGINEER'S DOCUMENTS SHALL BE BROUGHT TO ARCHITECT'S ATTENTION FOR DIRECTION.
- DO NOT SCALE THE CONSTRUCTION DOCUMENTS. WRITTEN DIMENSIONS TAKE PRECEDENCE OVER SCALED GRAPHICS. NOTIFY ARCHITECT IMMEDIATELY IN WRITING OF ALL ADDITIONAL REQUIRED DIMENSIONS. DO NOT PROCEED WITH WORK IN THE AREA OF DISCREPANCY OR CONFLICT UNTIL DIRECTION IS GIVEN BY ARCHITECT. IF THE CONTRACTOR PROCEEDS WITHOUT DIRECTION FROM ARCHITECT, IT SHALL BE AT CONTRACTORS RISK, AND CONTRACTOR SHALL BE RESPONSIBLE FOR ALL REQUIRED CORRECTIVE ACTION.
- CORRECT ALL WORK INSTALLED IN CONFLICT WITH THE CONSTRUCTION 6. DOCUMENTS BY CONTRACTOR AS DIRECTED BY ARCHITECT AND AT NO ADDITIONAL EXPENSE TO THE OWNER.
- VISIT JOB SITE PRIOR TO BEGINNING WORK AND VERIFY ALL DIMENSIONS.
- COORDINATE THE SECURING OF ALL PERMITS, GOVERNMENTAL FEES AND 8. LICENSES REQUIRED FOR PROPER COMPLETION OF THE WORK. REQUEST ALL INSPECTIONS REQUIRED BY LOCAL GOVERNMENTAL AGENCIES AND COORDINATE THE WORK ACCORDINGLY. SEE SPECS AND/OR CONTRACTS FOR OWNER'S RESPONSIBILITY.
- WHERE WORK OR EQUIPMENT IS INDICATED "N.I.C." (NOT IN CONTRACT) ON THE DRAWINGS, SUCH WORK AND/OR EQUIPMENT SHALL BE PROVIDED BY OTHERS. CONTRACTOR SHALL COORDINATE AND COOPERATE TO EFFECT SUCH INSTALLATION.
- 10. ALL PLAN DIMENSIONS SHOWN AT CENTER OF WALL REPRESENT CENTER LINE OF STUD OR STRUCTURAL ELEMENT UNLESS NOTED OTHERWISE.
- 11. ALL PLAN DIMENSIONS FOR MASONRY AND CONCRETE REPRESENT FACE OF MATERIAL AND OPENING UNLESS NOTED OTHERWISE.
- 12. ALL PLAN DIMENSIONS FOR STUD WALLS REPRESENT FACE OF STUD UNLESS NOTED OTHERWISE.
- DIMENSIONS ARE NOT ADJUSTABLE WITHOUT THE REVIEW OF ARCHITECT UNLESS 13. NOTED (+/-) OR "VERIFY". DIMENSIONS NOTED "HOLD" SHALL BE CONSIDERED AS ABSOLUTE AND USED FOR LAY-OUT CONTROL UNLESS OTHERWISE DIRECTED BY ARCHITECT.
- 14. ALL HEIGHTS ARE DIMENSIONED FROM TOP OF SLAB UNLESS NOTED "AFF" (ABOVE FINISH FLOOR).
- "TYPICAL" MEANS COMPARABLE CHARACTERISTICS FOR THE ELEVATION OR DETAIL 15. NOTED. WHEN A DETAIL OR NOTE IS IDENTIFIED AS "TYPICAL", CONTRACTOR SHALL APPLY THIS DETAIL OR NOTE TO EVERY LIKE CONDITION, WHETHER OR NOT THE REFERENCE IS REPEATED IN EVERY INSTANCE. VERIFY DIMENSIONS AND **ORIENTATION ON PLANS.**
- "SIMILAR" MEANS COMPARABLE CHARACTERISTICS FOR THE ELEVATION OR DETAIL 16. NOTED - VERIFY DIMENSIONS AND ORIENTATION ON PLANS.
- ABBREVIATIONS THROUGHOUT THE DOCUMENTS COMPLY WITH DOCUMENT 17. ABBREVIATION LIST OR ARE THOSE IN COMMON USE. ARCHITECT WILL DEFINE THE INTENT OF ANY IN QUESTION.
- 18. REFER TO THE PROJECT MANUAL AND/OR CONTRACT BETWEEN OWNER AND CONTRACTOR FOR GENERAL CONDITIONS, SUPPLEMENTARY AND SPECIAL CONDITIONS, AND OTHER REQUIREMENTS.
- PROVIDE BARRICADES AND PROTECTIVE DEVICES SEPARATING CONSTRUCTION 19. AREAS. PROVIDE TEMPORARY PASSAGES AS REQUIRED. PRIOR TO DELIVERY OF MATERIALS TO CONSTRUCTION ZONE AND REMOVAL OF WASTE FROM SITE, CHECK WITH OWNER FOR ACCEPTABLE ACCESS ROUTE AND TIME. UNDER NO CIRCUMSTANCES USE AREA OUTSIDE THE CONSTRUCTION ZONE WITHOUT PRIOR CLEARANCE FROM THE OWNER. COMPLY WITH REQUIREMENTS AS SPECIFIED IN PROJECT MANUAL.
- PROVIDE FOR THE PROPER SEQUENCE OF CONSTRUCTION, LOCATION AND SIZE OF 20. OPENINGS. COORDINATE ALL CONSTRUCTION AS INDICATED BY THE CONTRACT DOCUMENTS, INCLUDING SHOP DRAWINGS REVIEWED BY ARCHITECT.
- VERIFY POINTS OF CONNECTION, INCLUDING SIZES AND LOCATIONS, AND ALL 21. OTHER REQUIRED OPERATING CRITERIA WITH EQUIPMENT MANUFACTURER.
- COORDINATE THE LOCATION AND TYPE OF ALL ACCESS PANELS REQUIRED FOR 22. ACCESSING MECHANICAL, PLUMBING, ELECTRICAL AND OTHER BUILDING SYSTEMS WITH ARCHITECT.
- CONTRACTOR SHALL STIPULATE THAT ALL PROPOSED SUBSTITUTIONS ARE EQUAL 23. IN PERFORMANCE AND COMPLY WITH APPLICABLE CODES AND REGULATIONS. CONTRACTOR'S SUBSTITUTION OF ALTERNATE MATERIALS OR SYSTEMS SHALL BE AT NO ADDITIONAL COST TO OWNER.
- CONTRACTOR SHALL ENSURE ALL CONSTRUCTION SHALL REMAIN ACCESSIBLE AND 24. EXPOSED FOR INSPECTION PURPOSES UNTIL APPROVED BY THE INSPECTOR OF RECORD. FOR CONTINUOUS INSPECTION, TESTING, AND OBSERVATION REQUIREMENTS, REFER TO THE TESTING AND OBSERVATION PROGRAM.

#### ACCESSIBLE MOUNTING CLEARANCES

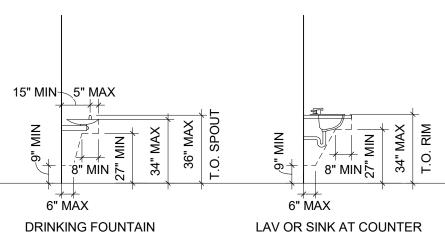



DRINKING FOUNTAIN



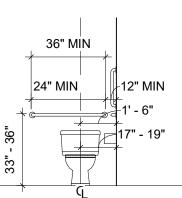


TOILET (SIDE)

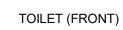


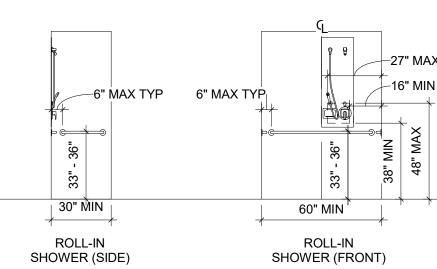


4" MAX ¢ 9 15" MAX-6" MAX TYP 36" MIN TRANSFER-TYPE


SHOWER (SIDE)

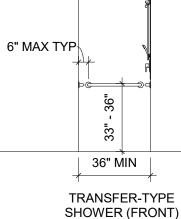

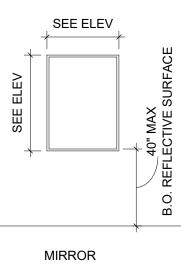

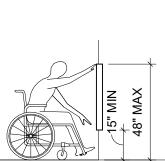

WALL-MOUNTED ITEMS PER FORWARD REACH LIMITS SYMBOLS LEGEND

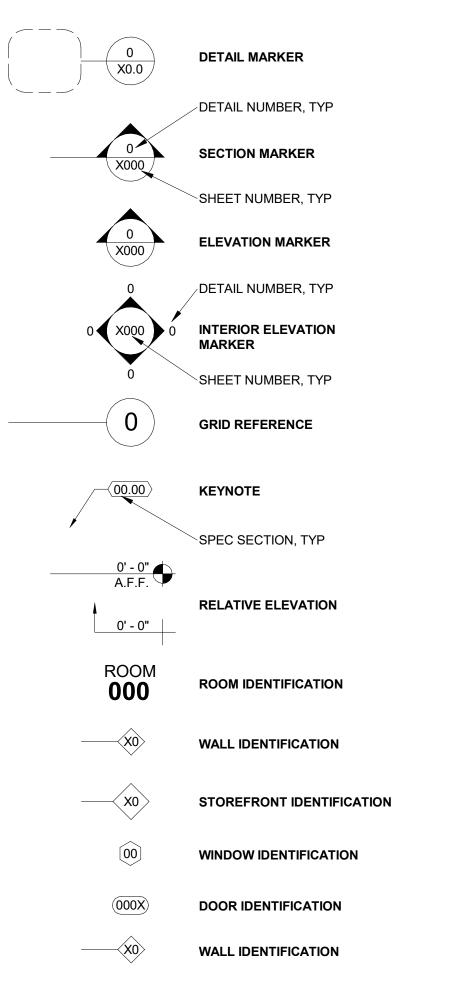



POSTER MIRTO McDONALD ARCHITECTURE PLANNING PRESERVATION 7 N. COURT AVE. TUCSON, AZ 8570



### TEATRO CARMEN **REHABILITATION OF HISTORIC** THEATER

380 S. MEYER AVE. - TUCSON, AZ 85701

G002

NOTES, & ABBREVATIONS

CLEARANCES,

SYMBOLS,

DRAWN BY: Author REVISIONS CHECKED BY: Checker NO. DATE ISSUE

\_\_\_\_\_

EXISTING SITE PLAN SCALE: 1/8" = 1'-0"

(1





poster Mirto McDONALD 317 N. COURT AVE. TUCSON, AZ 85701 PH 520.882.6310 | WWW.PMM.DESIGN

KEYNOTES




TEATRO CARMEN REHABILITATION OF HISTORIC THEATER 380 S. MEYER AVE. - TUCSON, AZ 85701

G003

EXISTING SITE PLAN


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TEATRO CARMEN REHABILITATION OF HISTORIC THEATER 380 S. MEYER AVE. - TUCSON, AZ 85701

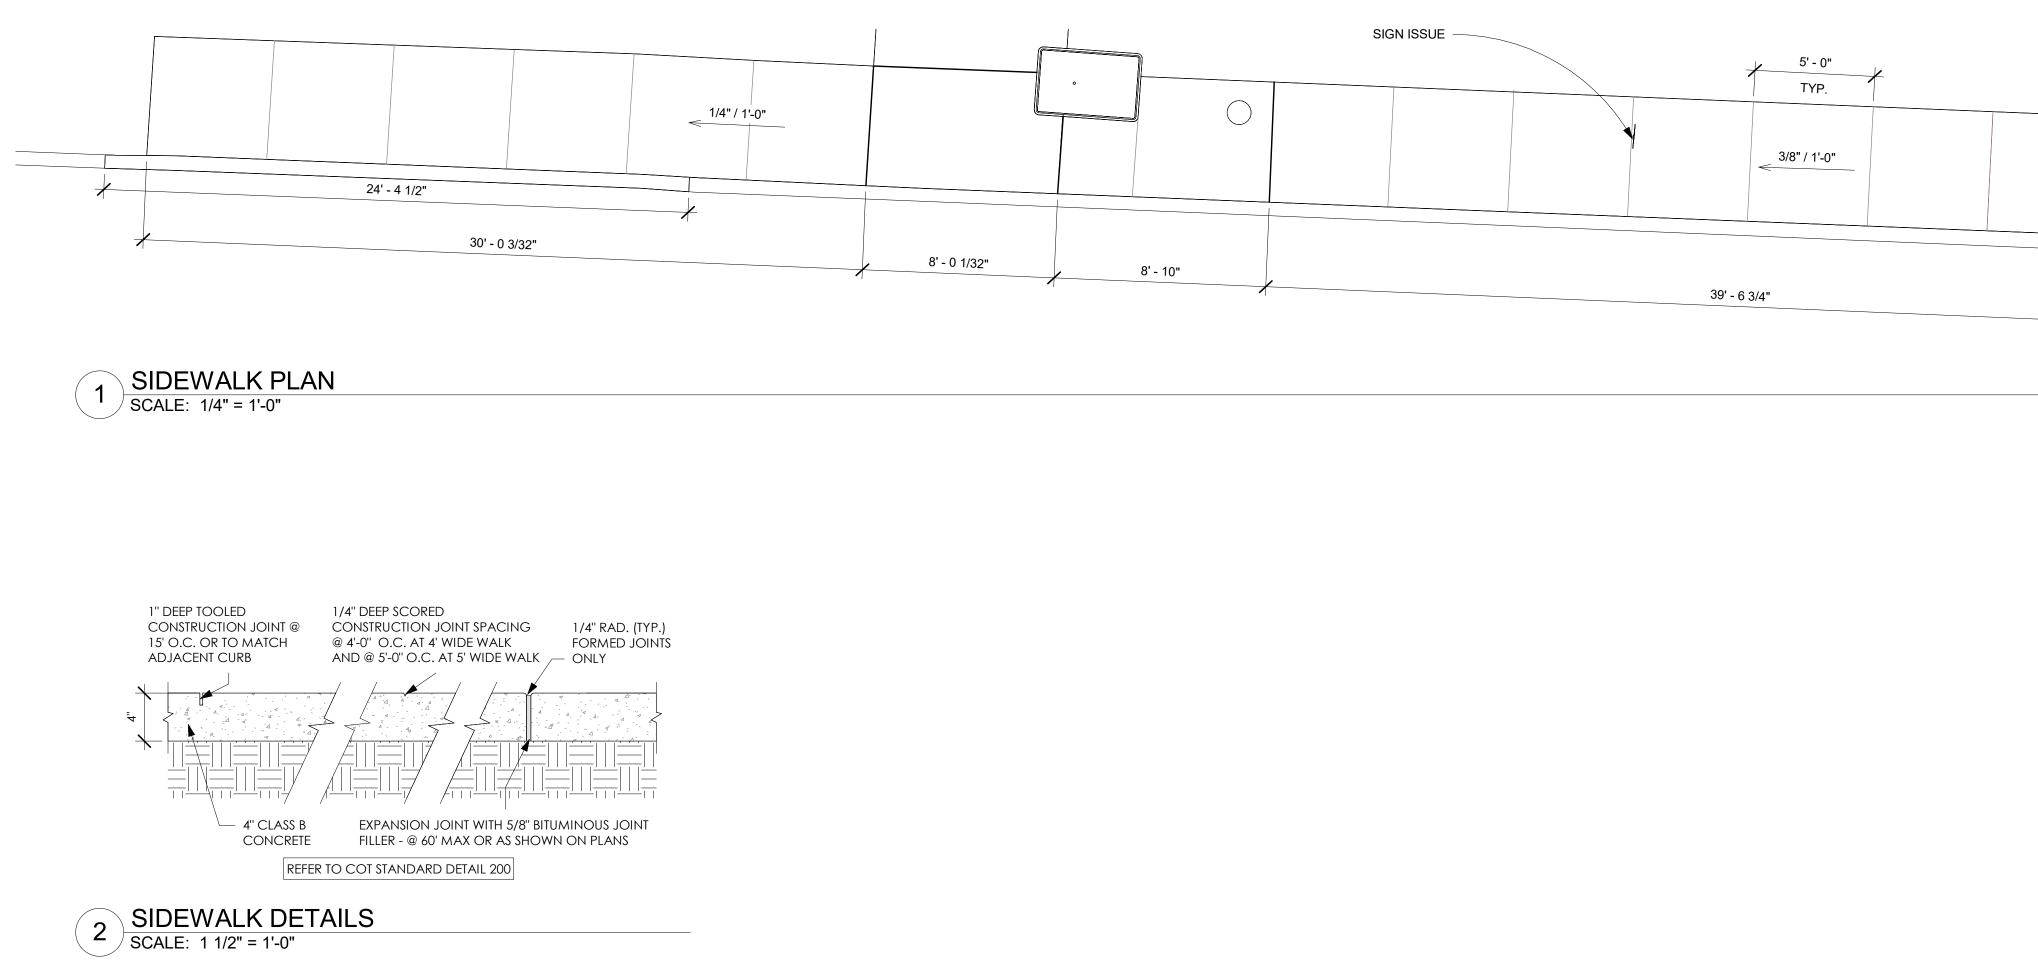G004

SIDEWALK PLAN

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1 SITE VISABLITY TRIANGE PLAN SCALE: 1/16" = 1'-0"

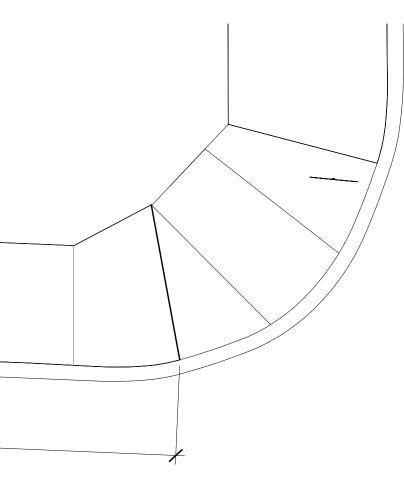

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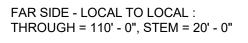
— ONE WAY

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NEAR SIDE - LOCAL TO LOCAL : THROUGH = 180' - 0", STEM = 20' - 0"



PROPOSED NEW WALL



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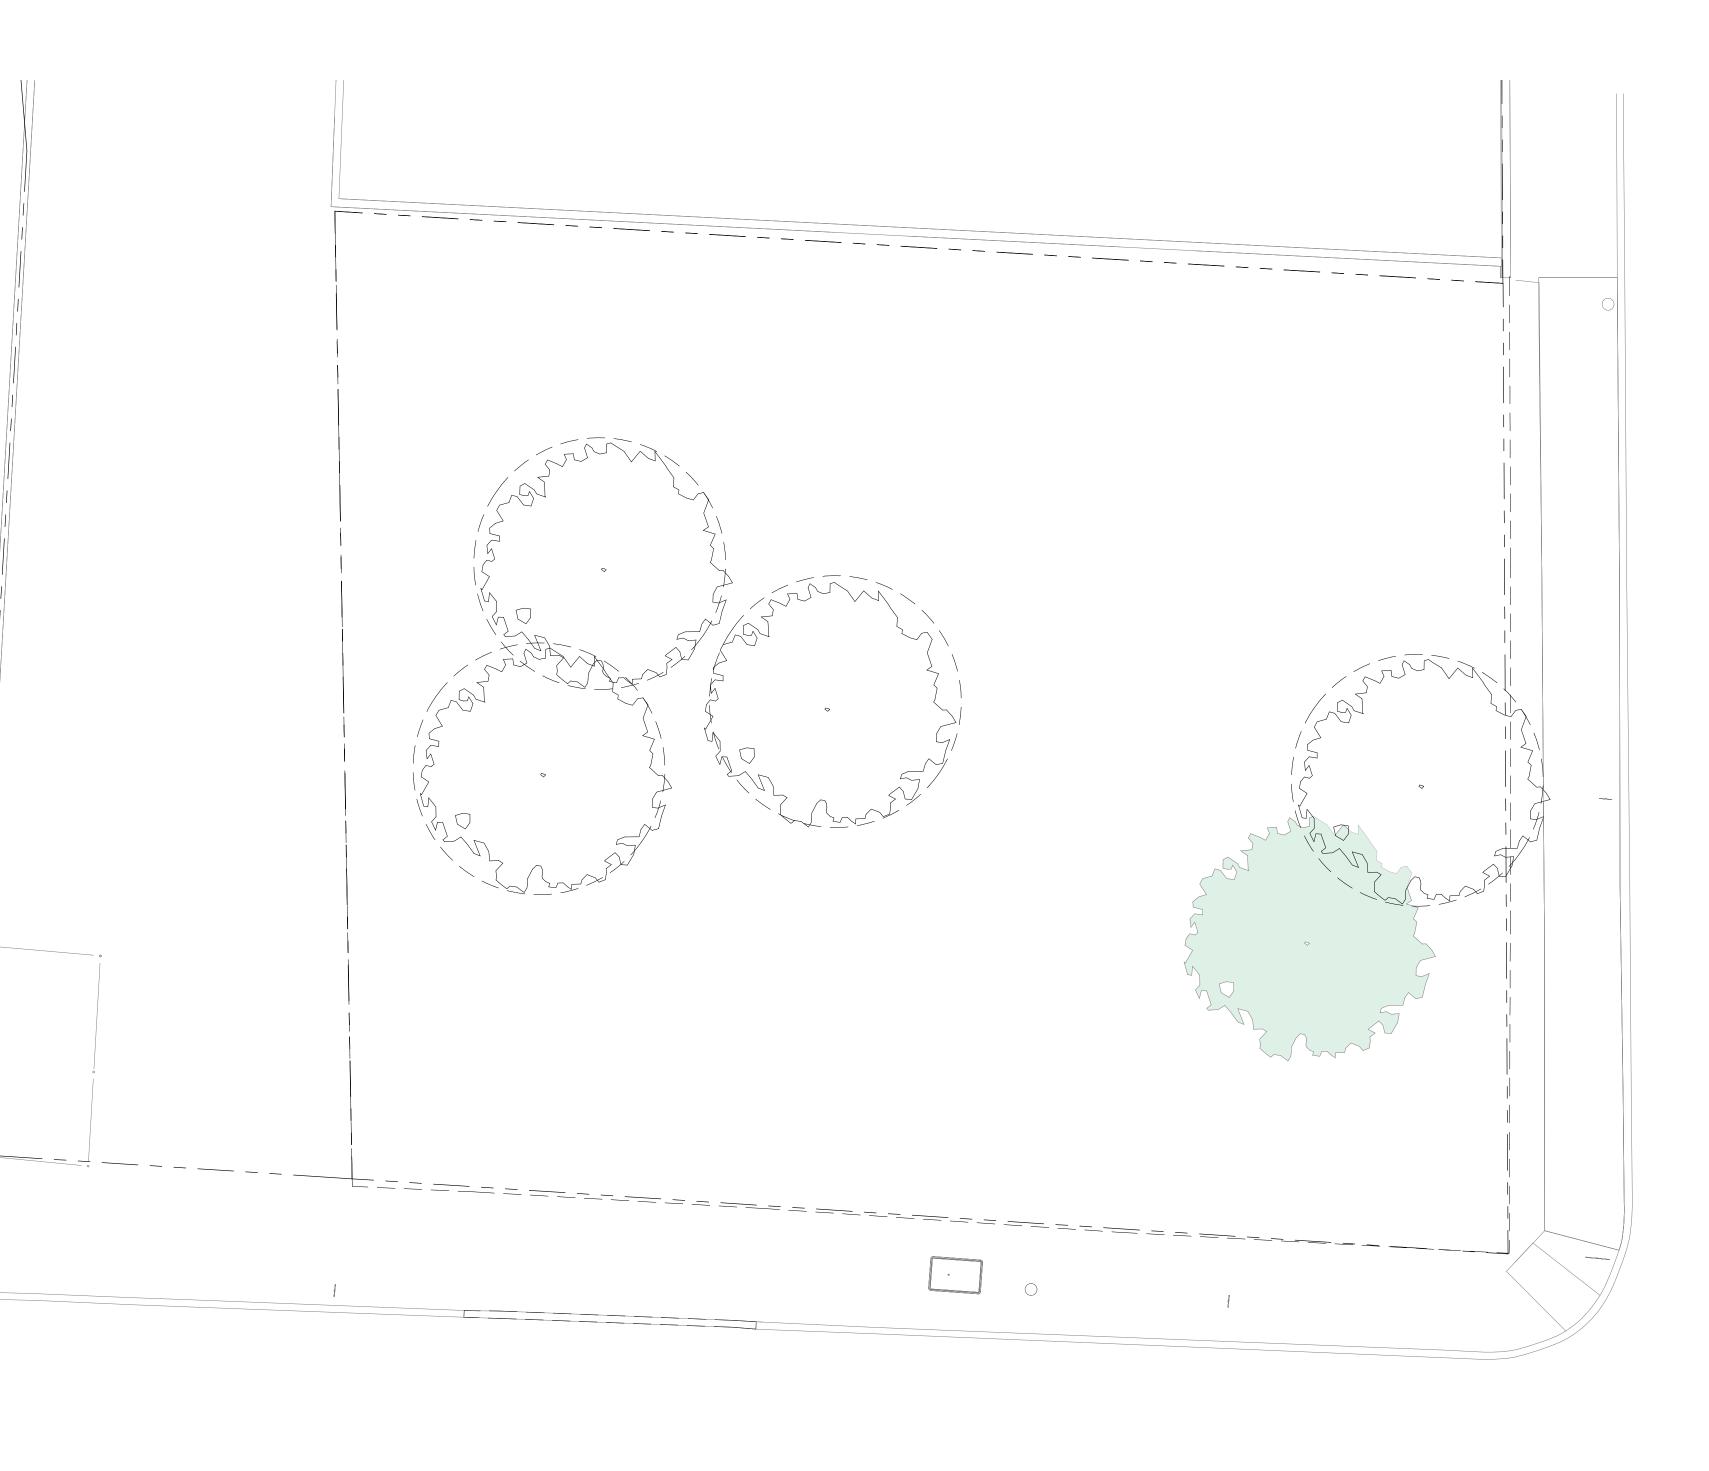
G005

SIGHT VISIBLITY TRIANGLE

DRAWN BY: Author REVISIONS CHECKED BY: Checker NO. DATE ISSUE


1 PATIO SITE PLAN - DEMO SCALE: 1/8" = 1'-0"

0





poster Mirto McDONALD

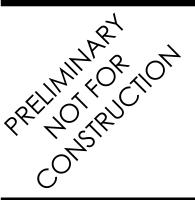


TEATRO CARMEN REHABILITATION OF HISTORIC THEATER 380 S. MEYER AVE. - TUCSON, AZ 85701

AD100

DEMO PLAN

DRAWN BY: Author REVISIONS CHECKED BY: Checker NO. DATE ISSUE

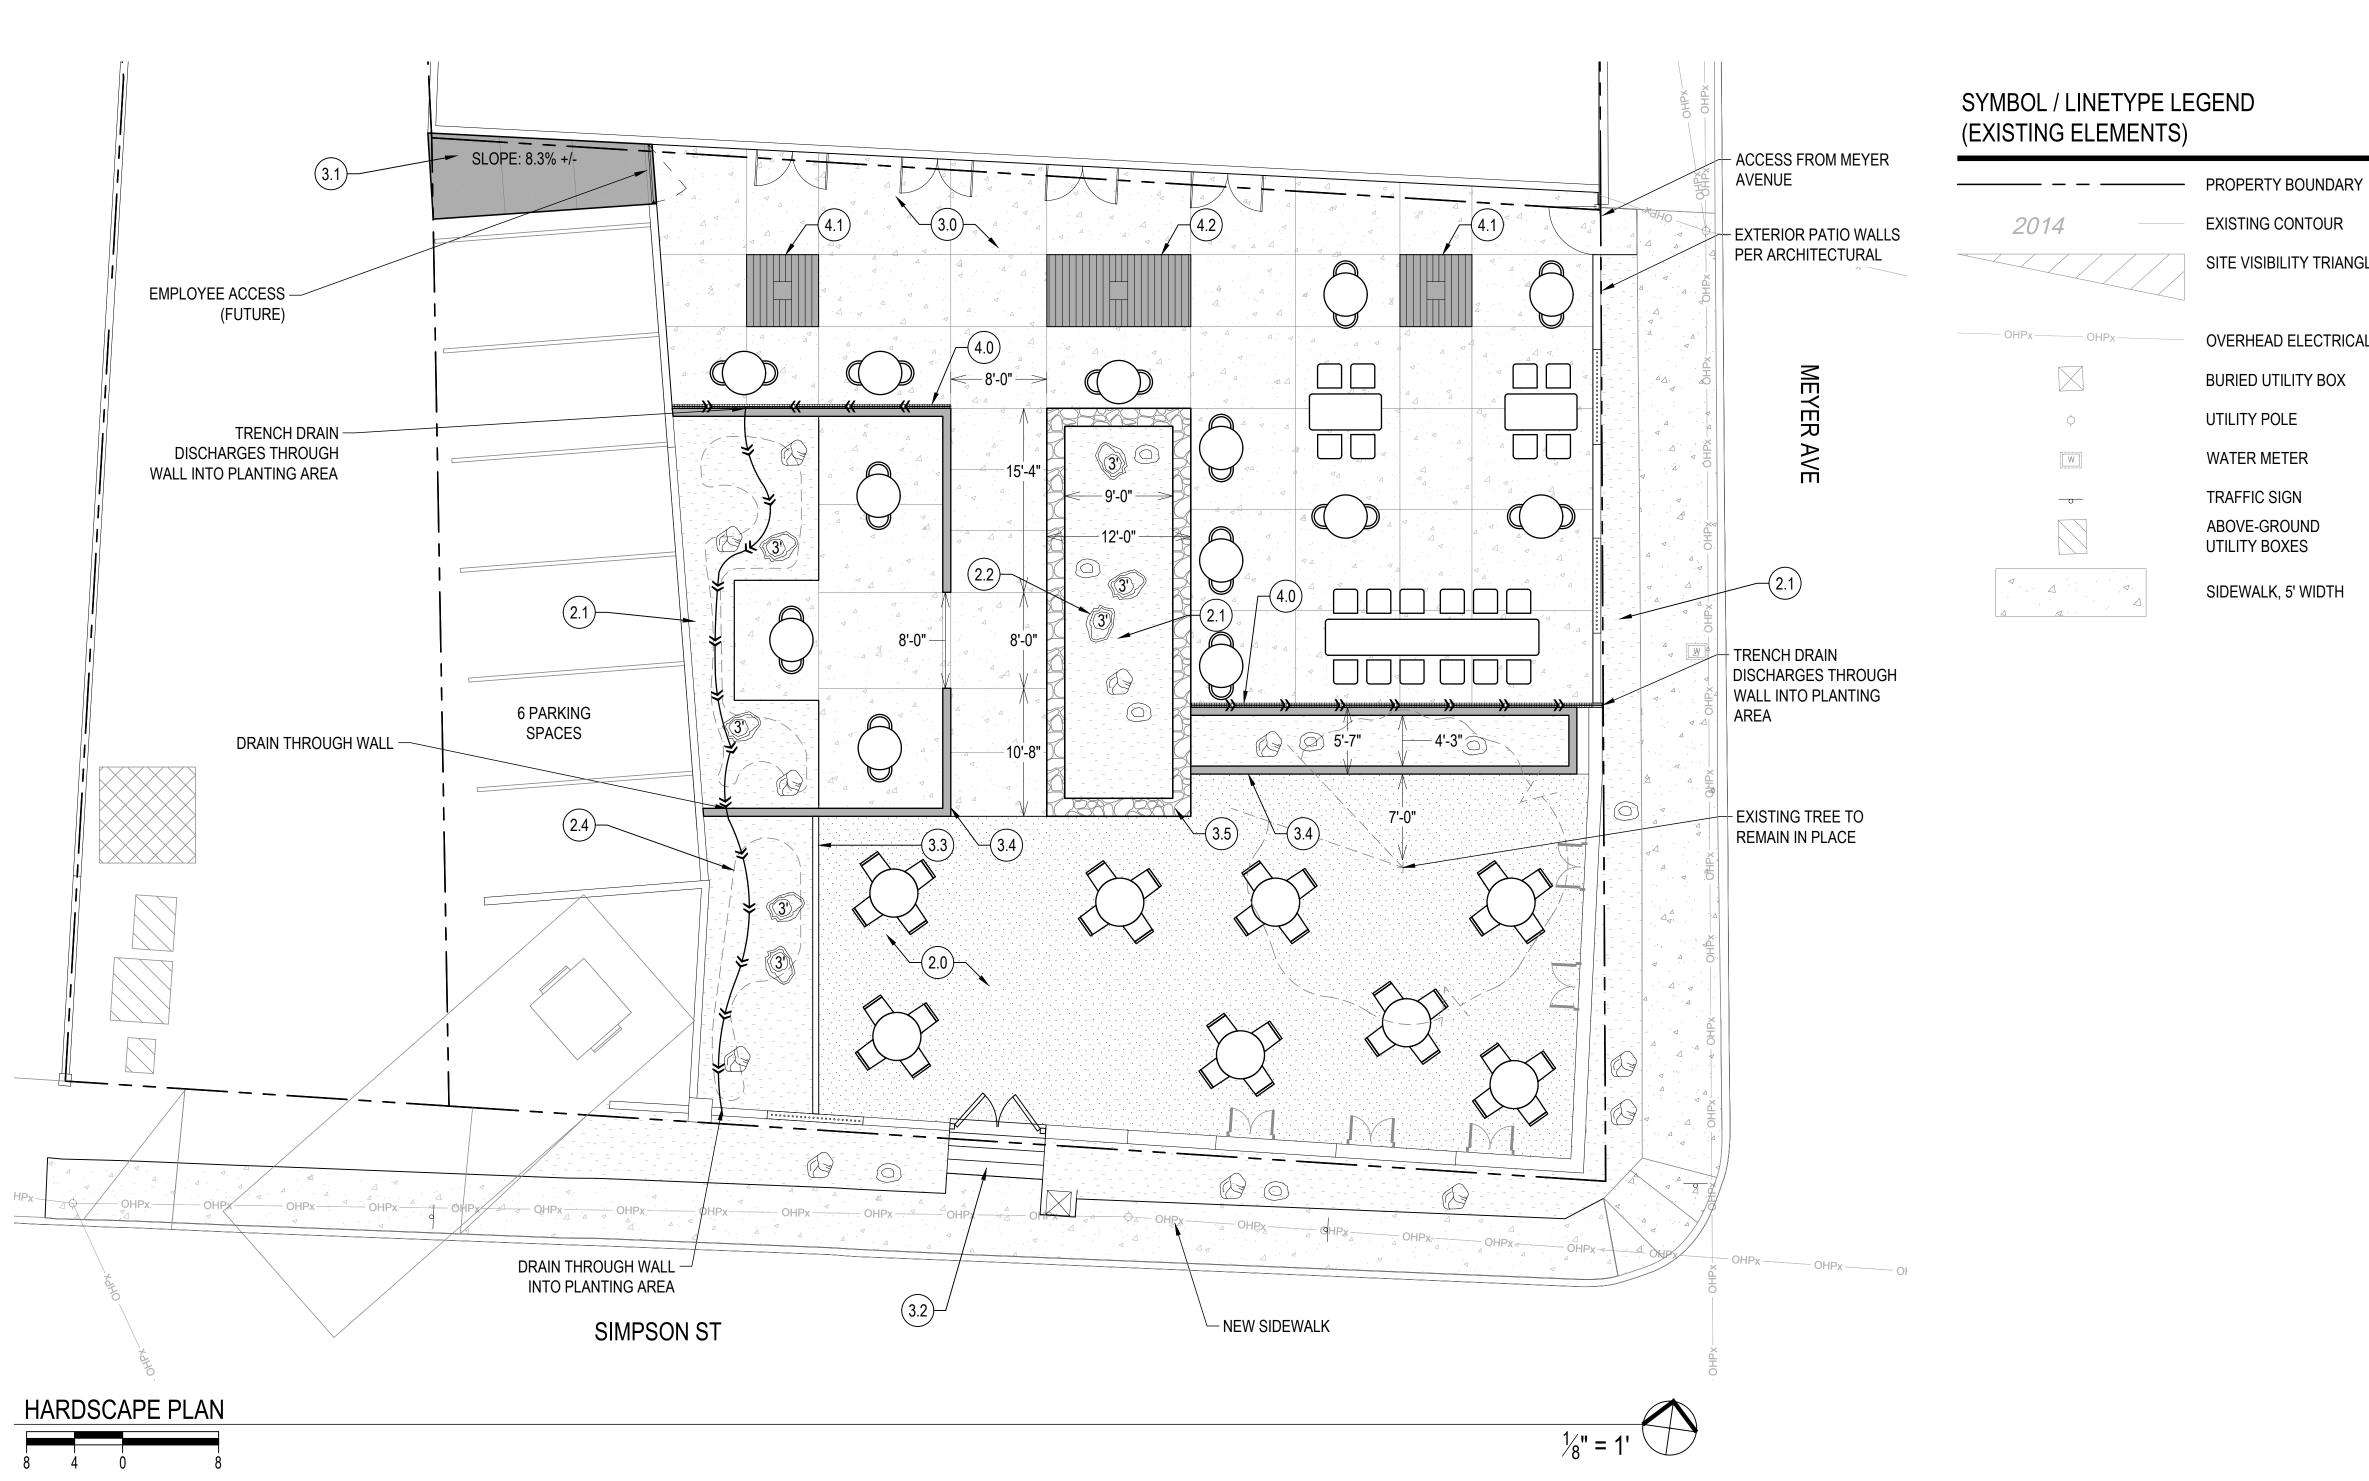

SITE VISIBILITY TRIANGLE

OVERHEAD ELECTRICAL

REFER TO SHEET L2 FOR COMPLETE SCHEDULES WITH SOURCING & QUANTITY

SYMBOL

## INERT MATERIALS + EARTHWORKS SCHEDULE KEYNOTE ITEM

	Decomposed Granite, Stabilized	2.0
	Desert Cobble (Screened Rock Mix)	(2.1)
	Boulders, Surface Select	(2.2)
NOT SHOWN ON PLANS	Soil for Raised Planters	2.3
	Basin	2.4

## HARDSCAPE, INTERIOR PATIO WALL + PLANTER SCHEDULE

SYMBOL	ITEM	KEYNOTE
	Concrete, Exposed Aggregate with Integral Color	3.0
	Ramp to Parking - FUTURE PHASE	(3.1)
	Steps, Stone	3.2
	Concrete Header	3.3
	CMU Wall, Retaining, with Stucco	(3.4)
	Stone Planter Wall	3.5

## SITE FURNISHINGS SCHEDULE

SYMBOL	ITEM	KEYNOTE
	Trench Drain	(4.0)
	Tree Grate, 6' x 6'	(4.1)
	Tree Grate, 6' x 12'	(4.2)



POSTER MIRTO McDONALD PMM ARCHITECTURE PLANNING PRESERVATION 317 N. COURT AVE. TUCSON, AZ 85701 PH 520.882.6310 | WWW.PMM.DESIGN

## WILDER Landscape Architects

2738 East Adams Street Tucson, Arizona 85716 Jennifer Patton, 520-320-3936 jennifer@wilderla.com




## TEATRO CARMEN 50% PATIO CDS

380 S. MEYER AVE. TUCSON, AZ 85701

HARDSCAPE PLAN

DRAWN BY: Wilder Team REVISIONS CHECKED BY: JP NO. DATE ISSUE

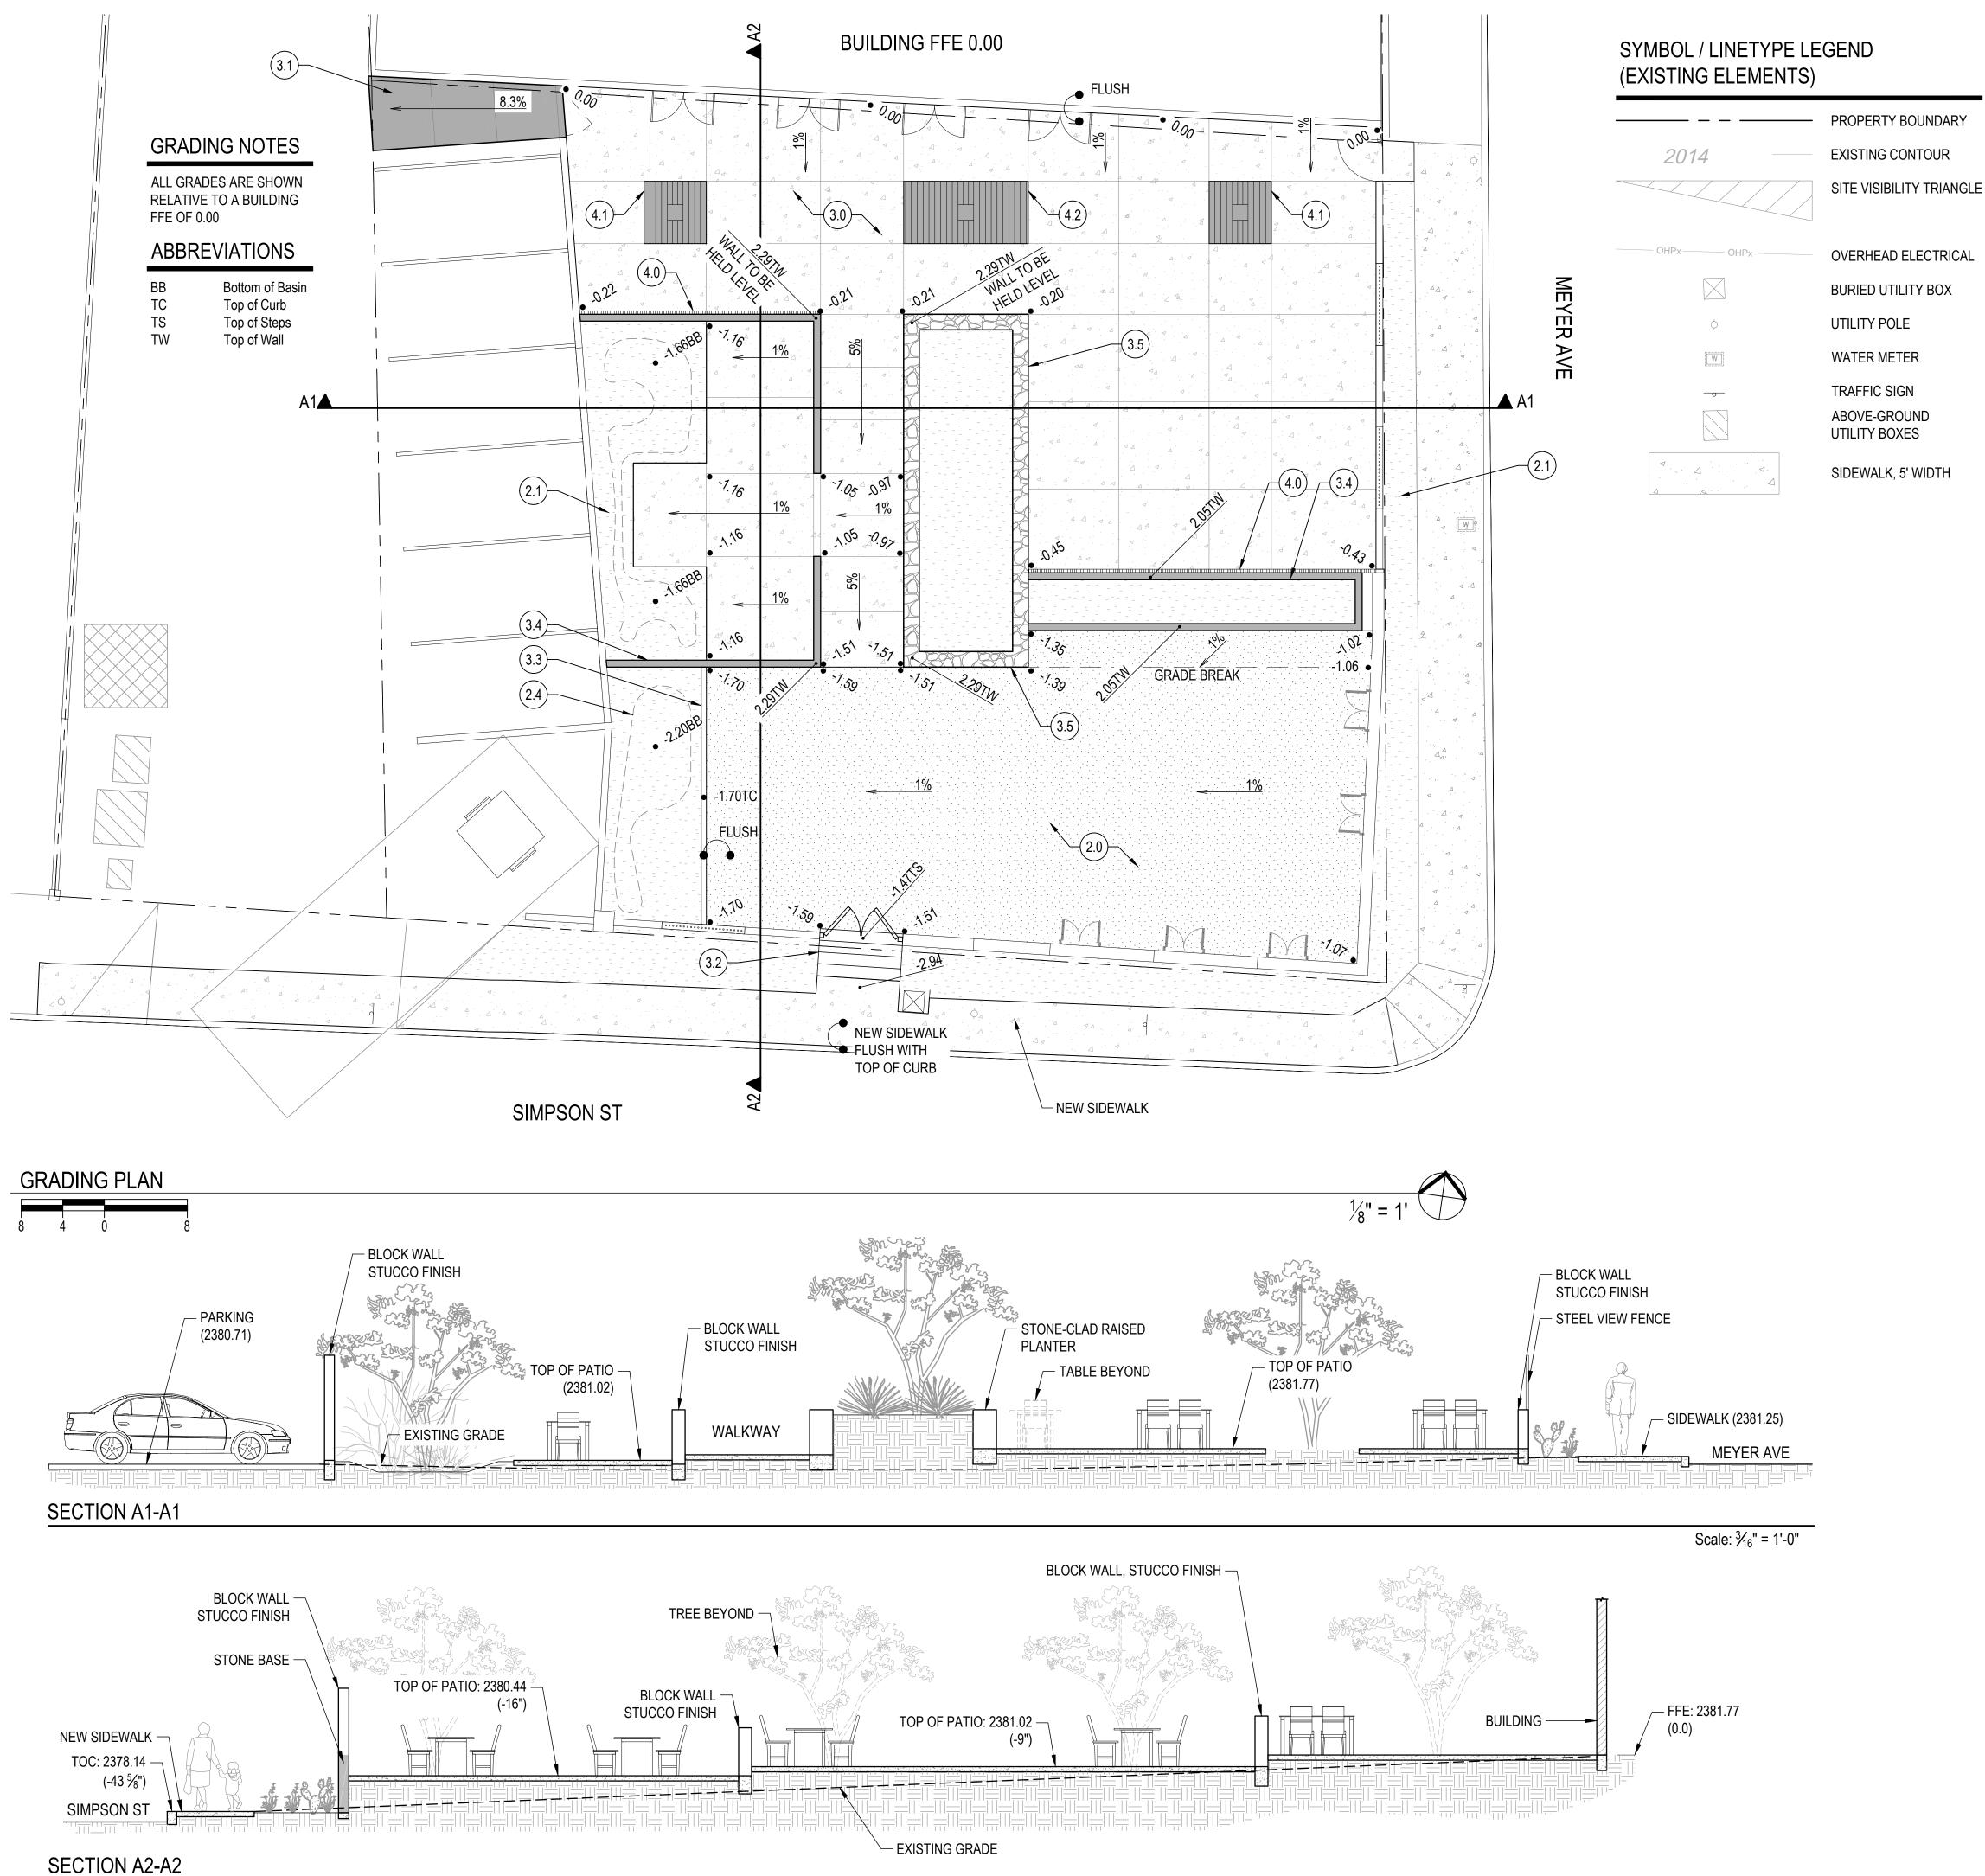



#### REFER TO SHEET L2 FOR COMPLETE SCHEDULES WITH SOURCING & QUANTITY

### INERT MATERIALS + EARTHWORKS SCHEDULE

SYMBOL	ITEM	KEYNOTE
	Decomposed Granite, Stabilized	2.0
	Desert Cobble (Screened Rock Mix)	(2.1)
	Boulders, Surface Select	(2.2)
NOT SHOWN ON PLANS	Soil for Raised Planters	2.3
	Basin	2.4

### HARDSCAPE, INTERIOR PATIO WALL + PLANTER SCHEDULE

SYMBOL	ITEM	KEYNOTE
	Concrete, Exposed Aggregate with Integral Color	3.0
	Ramp to Parking - FUTURE PHASE	3.1
	Steps, Stone	3.2
	Concrete Header	3.3
	CMU Wall, Retaining, with Stucco	3.4
	Stone Planter Wall	3.5

## SITE FURNISHINGS SCHEDULE

SYMBOL	ITEM	KEYNOTE
	Trench Drain	(4.0)
	Tree Grate, 6' x 6'	(4.1)
	Tree Grate, 6' x 12'	(4.2)




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## WILDER Landscape Architects

2738 East Adams Street Tucson, Arizona 85716 Jennifer Patton, 520-320-3936 jennifer@wilderla.com



TEATRO CARMEN 50% PATIO CDS

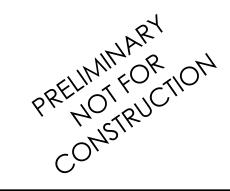380 S. MEYER AVE. TUCSON, AZ 85701

GRADING PLAN

DRAWN BY: Wilder Team REVISIONS CHECKED BY: JP

© DATE: 06.29.22 PROJECT NO: A-1553

NO. DATE ISSUE

## INERT MATERIALS + EARTHWORKS SCHEDULE

SYMBOL	ITEM	KEYNOTE	QTY	FINISH / SIZE / COLOR	SUPPLIER	NOTES / DETAIL
	Decomposed Granite, Stabilized	2.0	1,775 SF	<sup>3</sup> ⁄ <sub>8</sub> " Minus Apache Gold, Stabilized per Specifications 4" Depth after Compaction	DG: Kalamazoo Materials 520-575-9601 Stabilizer: Stabilizer Solutions Clay Hobbs 602-225-5900	Refer to Specificatio
	Desert Cobble (Screened Rock Mix)	2.1	1,570 SF	<ul> <li><sup>3</sup>/<sub>8</sub>" Screened Apache Gold, 25%</li> <li><sup>3</sup>/<sub>4</sub>" Screened Kino Blue, 25%</li> <li>1-4" Rip Rap, Apache Brown, 50%</li> </ul>	Kalamazoo Materials 520-575-9601	Depth 1.5" average 1" average depth & Rock to be mixed p Refer to Detail 3, Sh
	Boulders, Surface Select	2.2	7 EA 11 EA 8 EA	3' approx. diameter 2' approx. diameter 18" approx. diameter	Kalamazoo Materials 520-575-9601	Set boulder (weathe below finished grad setting boulder. Refer to Detail 5, Sł
NOT SHOWN ON PLANS	Soil for Raised Planters	2.3	# CY	Thrive Premium Soil Blend (35% compost; 35% coco peat; 20% red screened dirt; 10% pumice)	Tanks Green Stuff, 520-290-8588 http://tanksgreenstuff. com/products/	Soil must be fully hy lifts of 3-4", thoroug
	Basin	2.4	220 SF		N/A	Refer to Detail 4, Sh

NOTE: Quantities are provided for reference only. Contractor is responsible for calculating amount of material required to construct the project as depicted on the plan.

### HARDSCAPE, INTERIOR PATIO WALL + PLANTER SCHEDULE

SYMBOL	ITEM	KEYNOTE	QTY	FINISH / SIZE / COLOR	SUPPLIER	NOTES / DETAIL
	Concrete, Exposed Aggregate with Integral Color	3.0	2,940 SF	<sup>3</sup> ⁄ <sub>8</sub> " aggregate Integral color: Davis Color 'Sandstone' #5237	TBD	1% Slope Typ. Slop Slope and landing w Refer to Grading Pla
	Ramp to Parking - FUTURE PHASE	(3.1)	115 SF	TBD	TBD	Future Phase - shov
	Steps, Stone	3.2	40 LF	Approximate 6.75" riser height, 14" tread depth.	N/A	Refer to Detail #, Sh
	Concrete Header	3.3	51 LF	N/A	N/A	Refer to Detail 2, Sh
	CMU Wall, Retaining, with Stucco	3.4	70 LF	Construction, Stucco, and Paint to match Exterior Patio Walls per Architectural Plan	N/A	30" wall height mean to top of finished pa height of wall will ind Sleeving for irrigatio construction. Refer
	Stone Planter Wall	3.5	92 LF	Site stone to be used	N/A	30" wall height mea to top of finished pa height of wall will ind Sleeving for irrigatio construction. Refer

NOTE: Quantities are provided for reference only. Contractor is responsible for calculating amount of material required to construct the project as depicted on the plan.

### SITE FURNISHINGS SCHEDULE

SYMBOL	ITEM	KEYNOTE	QTY	FINISH / SIZE / COLOR	SUPPLIER	NOTES / DETAIL
	Trench Drain	4.0	56'-9" LF	Jamison 4.84" x 19.68" Ductile Iron, Raw Natural Finish Drain Body TBD	Urban Accessories 877-487-0488	Refer to Specification
	Tree Grate, 6' x 6'	(4.1)	2 EA	Jamison Square, 6' Ductile Iron, Raw Natural Finish	Urban Accessories 877-487-0488	Refer to Specification
	Tree Grate, 6' x 12'	4.2	1 EA	Jamison Rectangle, 6' x 12' Ductile Iron, Raw Natural Finish	Urban Accessories 877-487-0488	Refer to Specification

ations and Detail 1, Sheet L3

ge & 100% coverage for at-grade areas; h & 50% coverage for raised planters. prior to scattering. Sheet L3

athered surface exposed) with  $\frac{1}{4}$  of boulder rade. Place inert groundcover (per plans) after

Sheet L3

hydrated as the planter is filled. Fill planter in ughly wetting soil between each lift.

Sheet L3

#### ope of walkway not to exceed 1:20 (5%). where noted on plans. Plan and Details 6 & 7, Sheet L3.

nown for reference only

Sheet L#.

Sheet L3.


easured at northeast corner, from top of wall patio surface. Top of wall to be held level: increase as grade lowers to the south. ation and lighting to be placed at time of wall er to Detail 2, Sheet L2.

easured at northwest corner, from top of wall patio surface. Top of wall to be held level: increase as grade lowers to the south. ation and lighting to be placed at time of wall fer to Detail 1, Sheet L2.

ations and Detail 8, Sheet L3


ations and Detail 9, Sheet L3

ations and Detail 9, Sheet L3

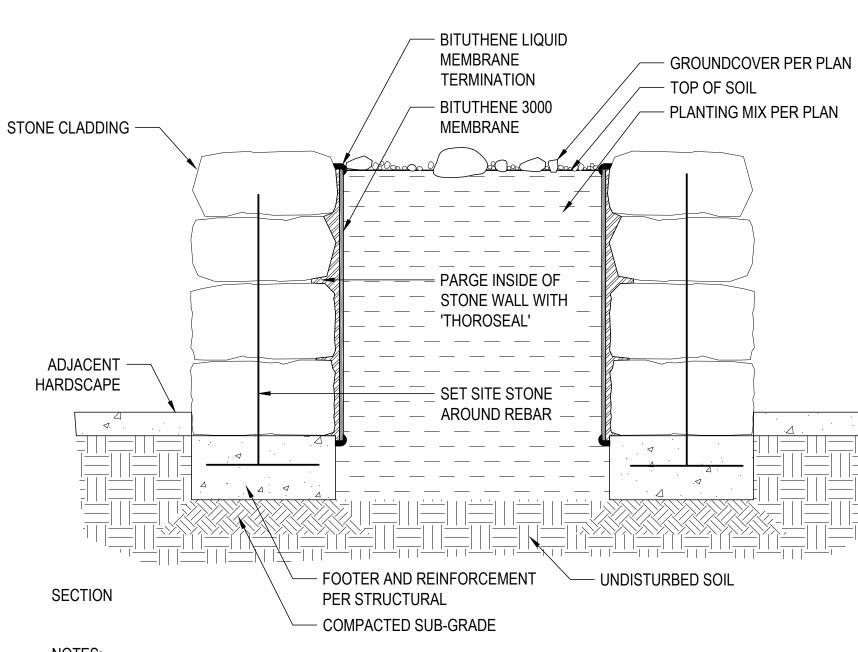

NOTES:

- 1. Apply continuous / overlapping water proofing membrane to all interior surfaces. Wrap membrane over all footers. 2. Apply continuous bead of liquid membrane to joint between footer and CMU walls. Apply continuous bead of liquid membrane
- termination at top and bottom of membranes. 3. Follow all manufacturer's specifications for installation of waterproofing.

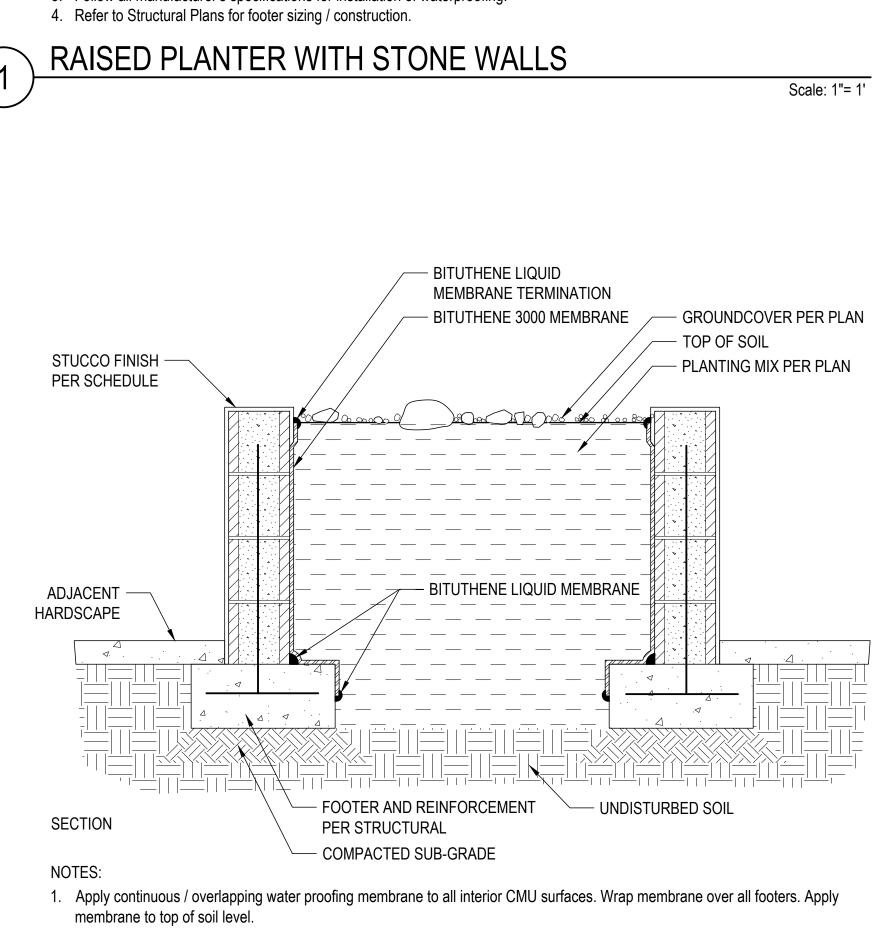

- 2. Apply continuous bead of liquid membrane to joint between footer and CMU walls. Apply continuous bead of liquid membrane termination at top and bottom of membranes.
- 3. Follow all manufacturer's specifications for installation of waterproofing.
- 4. Refer to Structural Plans for footer sizing / construction.
- RAISED PLANTER WITH STUCCO FINISH 2

### PLANTER STONE + DIMENSIONS

- . Stone for planter walls is from the site (excavation of former Chinese Grocery). Stone is assumed to be a hard basalt material, suitable for planter construction. Should this assumption be inaccurate, Project Design Team shall be notified for coordination of substitute material.
- 2. The exterior dimensions (length and width) of the planter shall be per Plan. The interior dimensions can vary by +/- 2" to allow for natural variation in stone size.



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## WILDER Landscape Architects

2738 East Adams Street Tucson, Arizona 85716 Jennifer Patton, 520-320-3936 jennifer@wilderla.com



Scale: 1"= 1'



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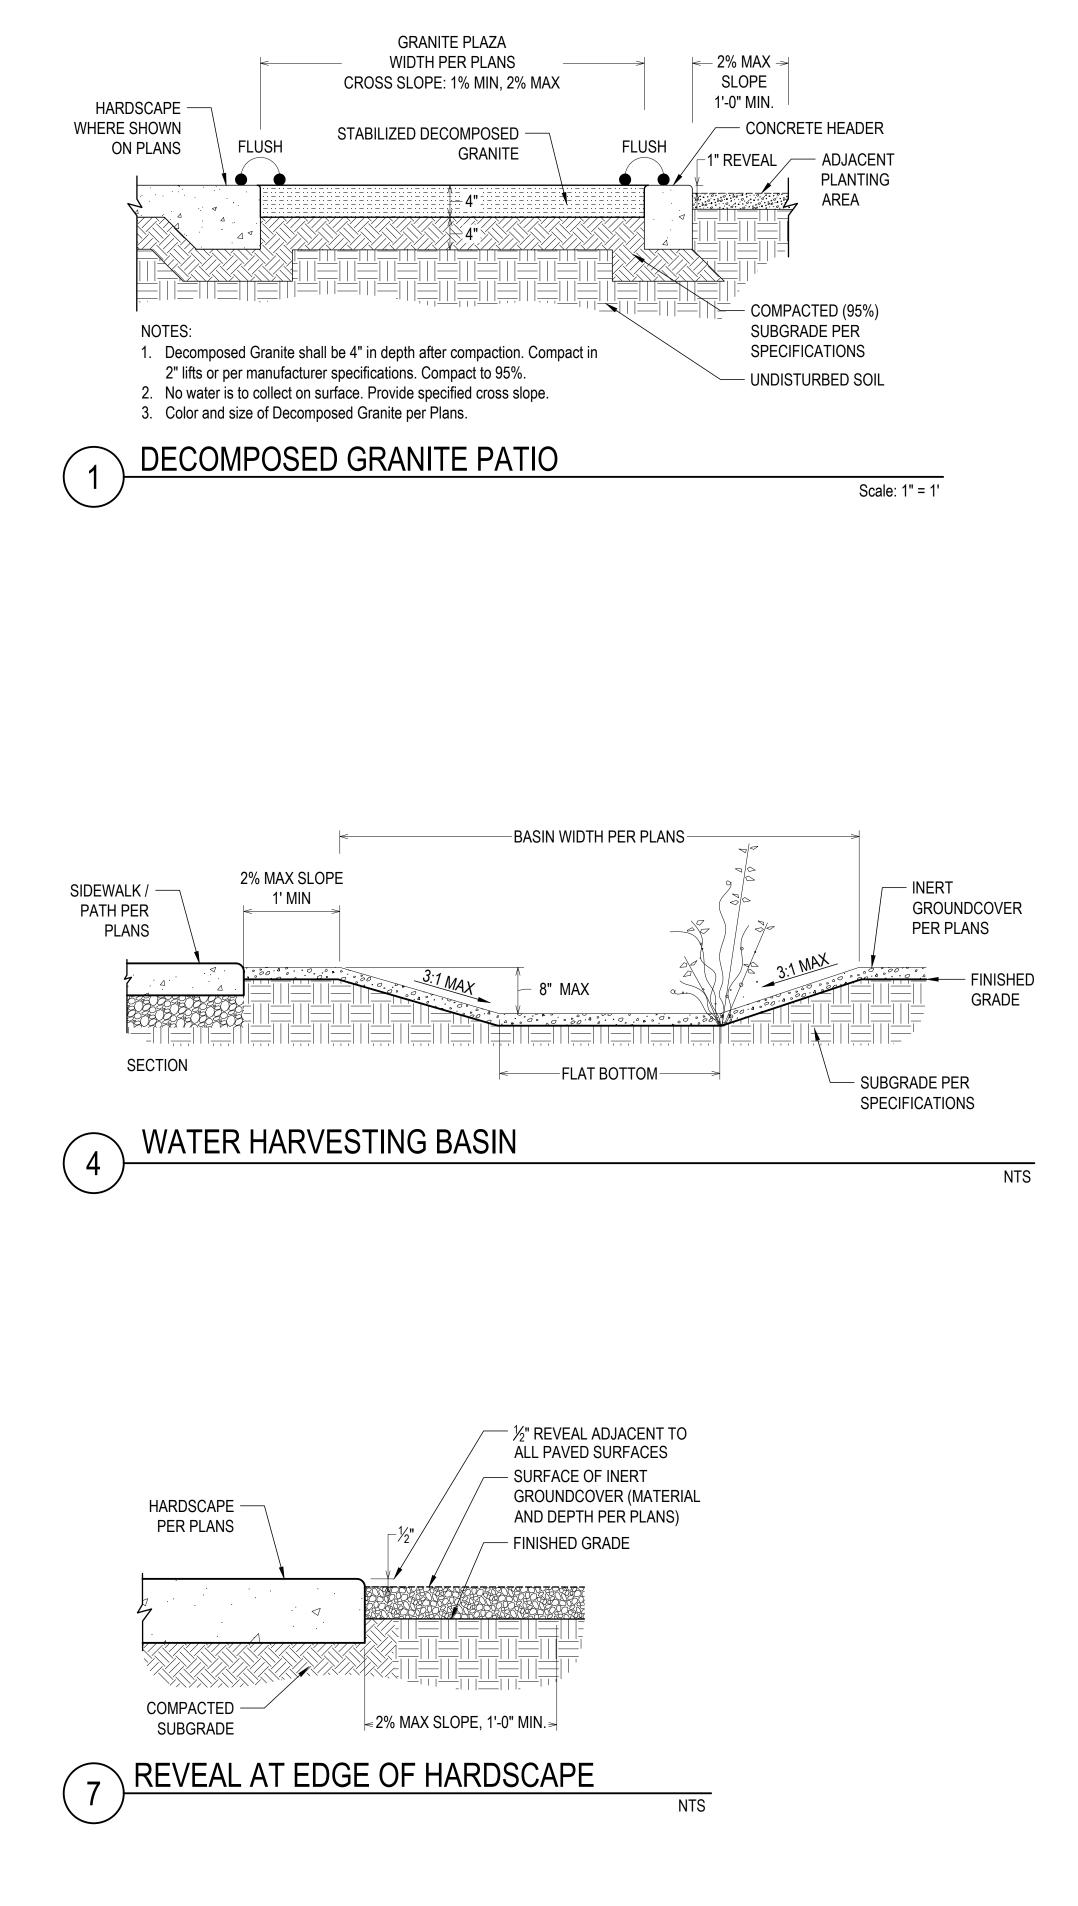
L2


SCHEDULES + DETAILS

DRAWN BY: Wilder Team REVISIONS CHECKED BY: JP

NO. DATE ISSUE

LANDSCAPE



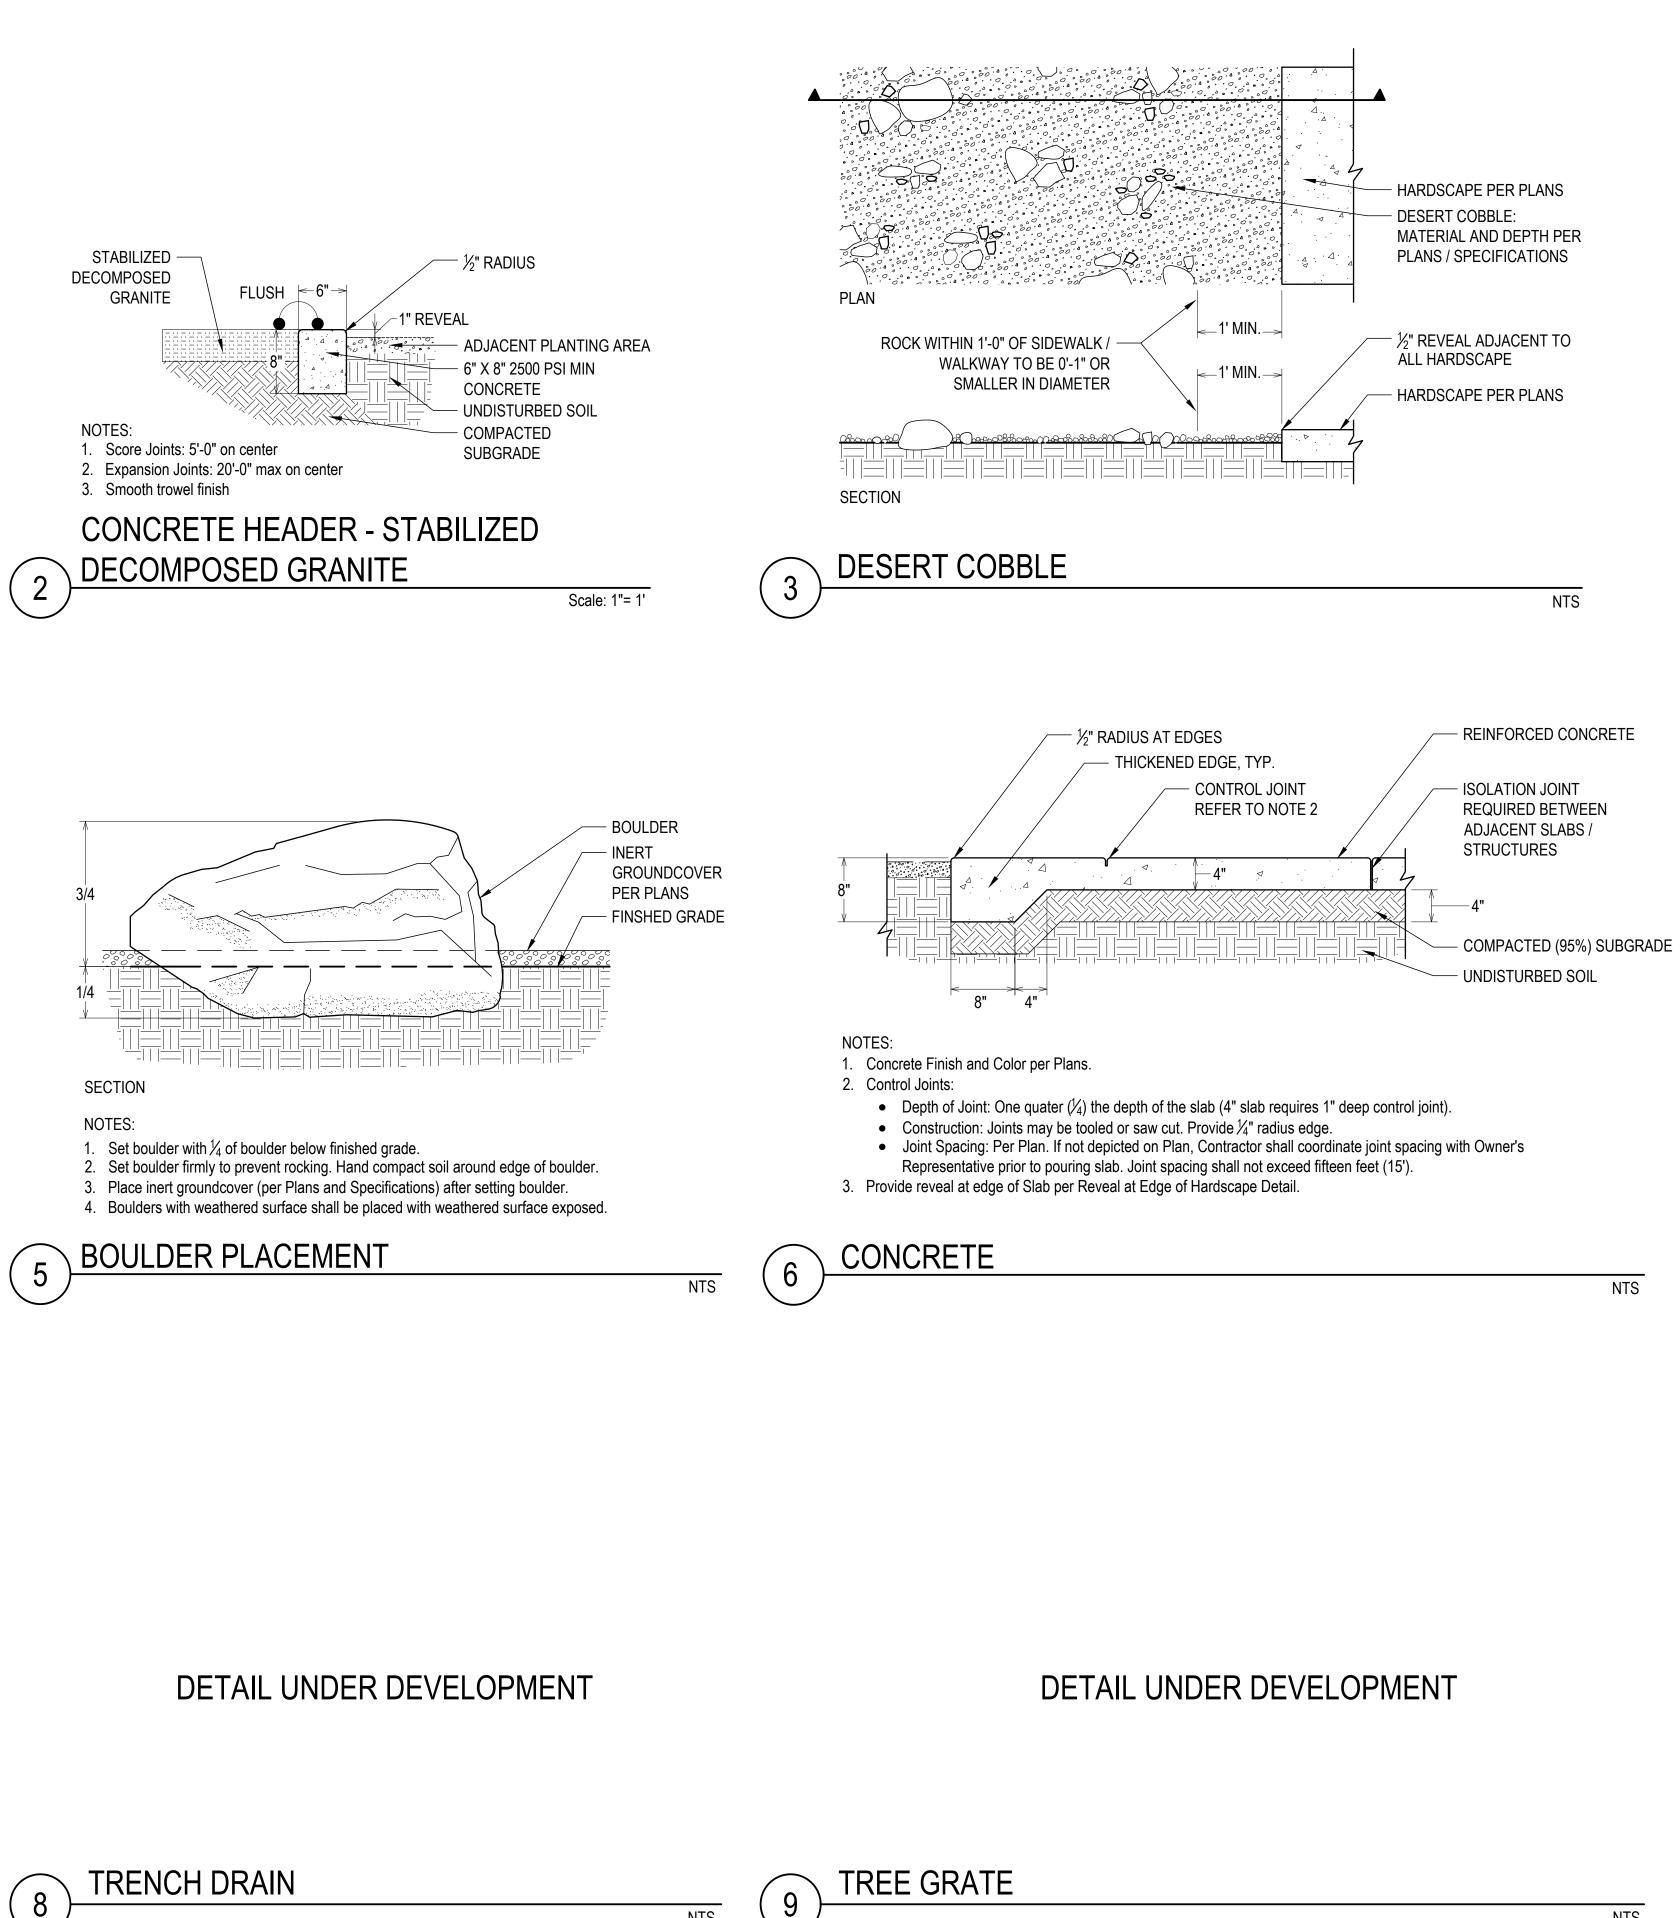




TRENCH DRAIN

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/////

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L3

NTS


LANDSCAPE DETAILS
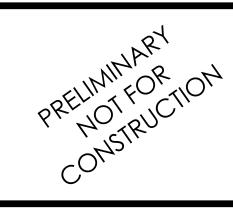
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NO. DATE ISSUE





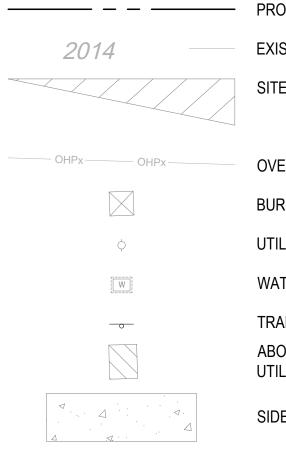

ABOVE-GROUND UTILITY BOXES

SIDEWALK, 5' WIDTH

BOTANICAL NAME COMMON NAME	CONT. SIZE	QTY	SOURCE BID ITEM #
Olneya tesota Ironwood	48" Box / 200 Gall	3	CONTRACTOR PROVIDED + INSTALLED 8061019
Olneya tesota Ironwood	36" Box / 95 Gall	6	CONTRACTOR PROVIDED + INSTALLED 8061013
	Olneya tesota Ironwood	COMMON NAME         Olneya tesota         Ironwood         48" Box /         200 Gall         Olneya tesota         36" Box /	COMMON NAMEOlneya tesotaValue

ME E	CONT. SIZE	QTY	SOURCE BID ITEM #
i n	5 Gal	3	AGENCY 8061297
na	5 Gal	1	AGENCY 8061297
urberi ckle	5 Gal	3	AGENCY 8061297
hylla	5 Gal	14	AGENCY 8061297
	5 Gal	3	CONTRACTOR 8061298
folia 1	5 Gal	15	CONTRACTOR 8061298
formis ean	1 Gal	5	AGENCY 8061295
1	15" Treepot	3	AGENCY 8062015
yi Ion	1 Gal	5	AGENCY 8061295
bigua	1 Gal	3	AGENCY 8061295
ntachaeta a	1 Gal	21	AGENCY 8061295
olia	5 Gal	2	AGENCY 8061297

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BOTANICAL NAME COMMON NAME	CONT. SIZE	QTY	SOURCE BID ITEM #
Agave schottii var. schottii Schott's century plant	5 Gal	13	CONTRACTOR 8061305
Cylindropuntia leptocaulis Christmas Cactus	5 Gal	3	AGENCY 8061610
Cylindropuntia versicolor Staghorn cholla	5 Gal	1	AGENCY 8061610
Echinocereus engelmannii Hedgehog Cactus	3 Gal	3	AGENCY 8061610
Ferocactus wislizeni Fishhook Barrel	3 Gal	7	AGENCY 8061610
Jatropha cardiophylla Limberbush	5 Gal	6	AGENCY 8061610
Mammillaria grahamii Pincushion Cactus	3 Gal	5	AGENCY 8061610
Yucca schottii Mountain Yucca	5 Gal	2	CONTRACTOR 8061305



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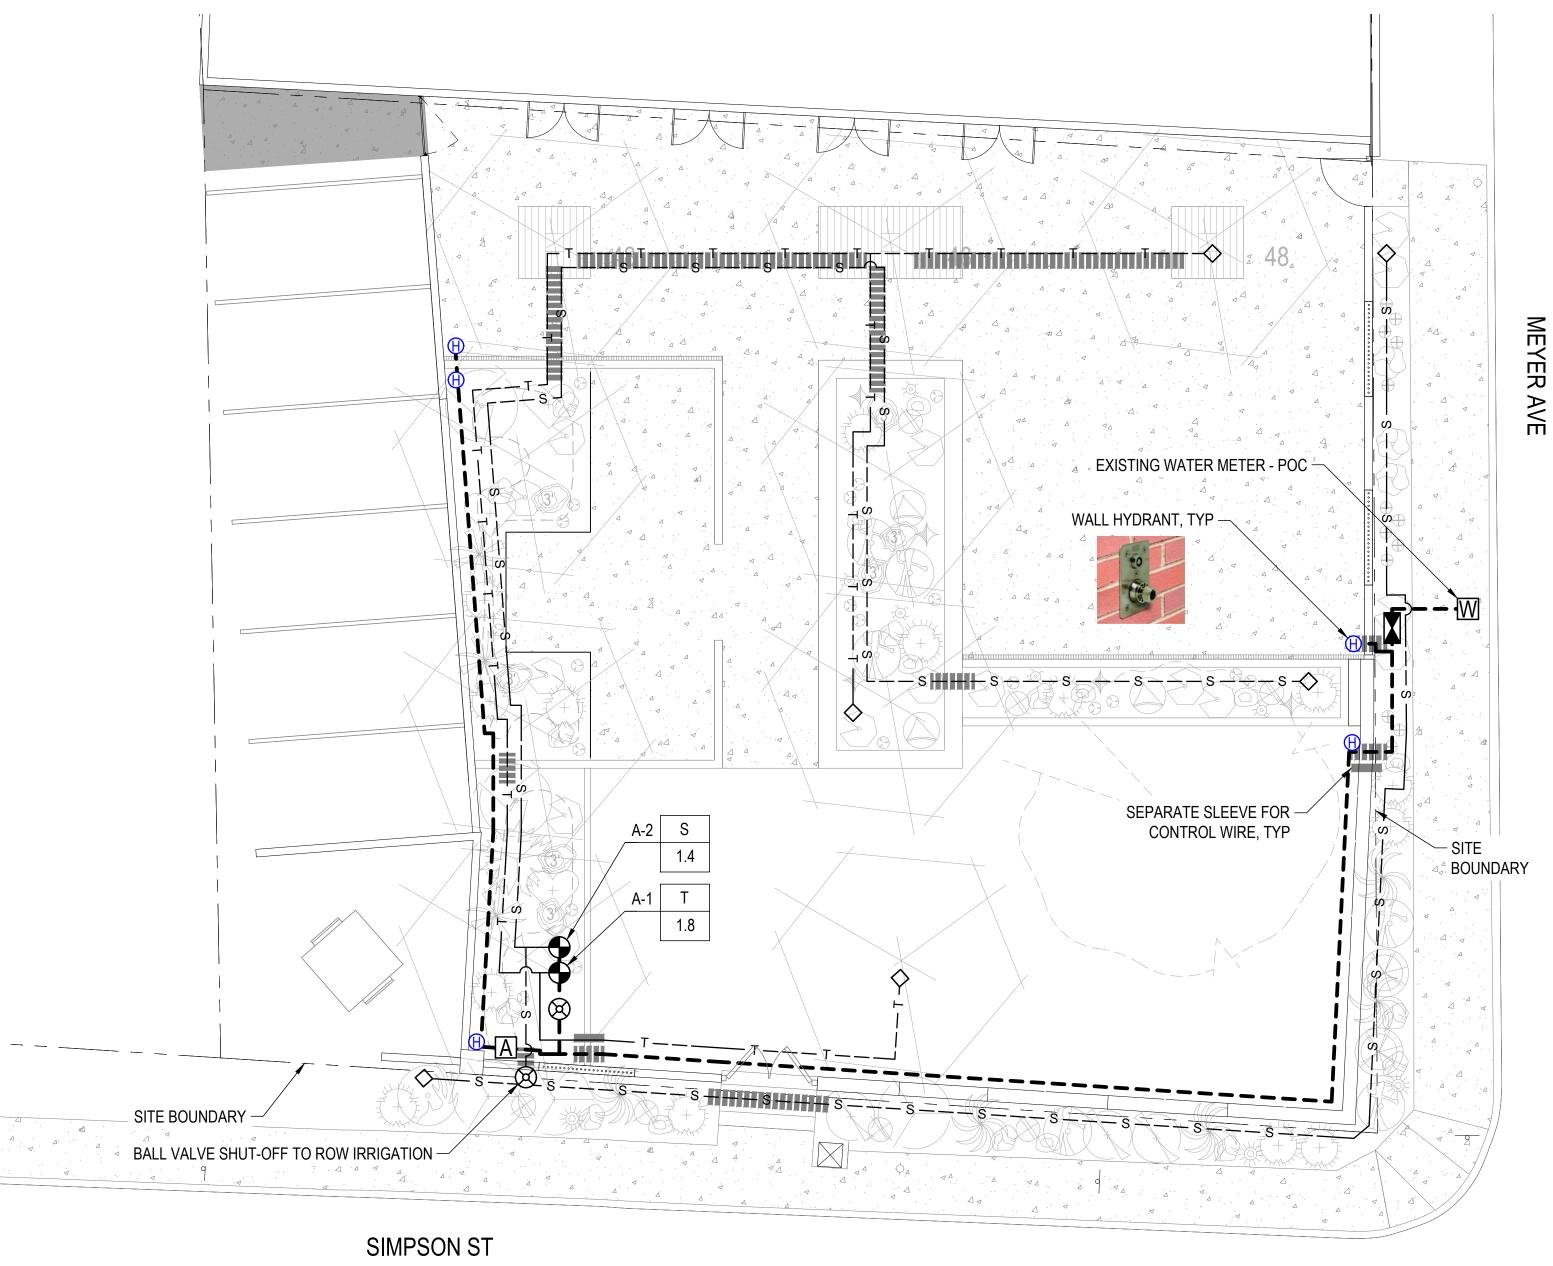
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L4

PLANTING PLAN

DRAWN BY: Wilder Team REVISIONS CHECKED BY: JP NO. DATE ISSUE



## **IRRIGATION PLAN**

8 4 0 8

#### **IRRIGATION NOTES**

- 1. A new irrigation system is being installed utilizing all PVC laterals.
- 2. Any existing irrigation system components shall be removed from site by Contractor.
- shown on the plan.
- 4. The Irrigation Plan is schematic. For clarity of Plans, irrigation lines / components may be shown within hardscape areas or in areas with existing plant material. All irrigation lines / components are to be located within previously disturbed site area, and within non-paved areas wherever possible. Do not run irrigation lines through basins. Trenching near existing tree roots shall be done by hand to minimize damage to roots.
- 5. Irrigation lines and components shall be located to not interfere with proposed plant material. In areas with limited planting space, locate irrigation lines to one side or the other to maximize area available for planting.
- 6. Sleeving is indicated on the irrigation plan where needed.

#### **IRRIGATION SCHEDULE**

SYMBOL	ITEM	MANUFACTURER / MODEL	SIZE	QTY	NOTES
W	Existing Water Meter (Point of Connection)				
	Reduced Pressure Backflow Preventer	Febco 825Y	3⁄4"	1 EA	Refer to Detail #, Sheet L#. Cover with tan insulating blanket.
A	Irrigation Controller "A" Security Enclosure	Rain Bird ESP4ME + LNKWIFI Lemeur Safeguard SG-AJR, Tan	N/A	1 EA	Refer to Detail #, Sheet L#
⊞	Rain Sensor	Rain Bird RSD	N/A	1 EA	
Ø	Ball Valve Shut-off	Nibco Brass	1"	2 EA	Refer to Detail #, Sheet L#
Ð	Wall Hydrant Hose Bib	Zurn Z1333XL	3⁄4"	5 EA	Refer to Detail #, Sheet L#
Ð	Zone Control Valve Combo Filter and Pressure Regulator	Rain Bird 100-PESB Rain Bird PRB-QKCHK-100	1" 1"	2 EA 2 EA	Refer to Detail #, Sheet L#
Not Shown	Valve Boxes: Remote Control Valve Ball Valve Master Valve & Flow Sensor Flush End Cap, Emitter Assembly	Model: Carson 1220, Tan Lid Carson 1419, Tan Lid Carson 1419, Tan Lid Carson 708, Tan, Twist-on Cover	14" x 22" 12" x 17" 12" x 17" 6" Dia.	2 EA 1 EA N/A 30 EA	Refer to Detail 1, Sheet L7 for Valve Box Layout Contractor to size valve boxes to provide suitable room for access and maintenance to valves. All valve boxes to have 4" layer of fractured, screened rock below valves and be wrapped with geotextile.
$\diamond$	Flush End Cap Assembly		N/A	6 EA	Refer to Detail #, Sheet L#
	Unconnected Pipe Crossing		N/A	N/A	
	Mainline Pipe, Sch 40 PVC (From Point of Connection to Valves)		1"	195 LF	Refer to Detail #, Sheet L#
———т—	Lateral Line (Tree) Sch 40 PVC		3⁄4"	215 LF	Refer to Detail #, Sheet L#
s_	Lateral Line (Shrub) Sch 40 PVC		3⁄4"	335 LF	Refer to Detail #, Sheet L#
	Sleeve, Sch 40 PVC (Piping) Sleeve, Sch 40 PVC (Wiring)		4" 2"	95 LF 5 LF	Refer to Detail #, Sheet L#
Not Shown	Emitters	Rain Bird Multi-outlet XB	2 GPH 1 GPH	9 15	Refer to Detail #, Sheet L#
Not Shown	Diffuser Bug Cap	Rain Bird DBC-025		140	Install bug cap to ends of all $\frac{1}{4}$ " distribution tubing.

#### VALVE & EMITTER SCHEDULE

VALVE #	ABBREV	DESCRIPTION	SIZE	# EMITTERS	GPH	EXCEPTIONS / NOTES	SUGGESTED VALVE RUN TIMES / FREQUENCY - JUNE
A-1	Т	Tree	1"	6	2	No emitters on existing tree	Newly Planted: 1 hour daily Established: 2 - 3 hours / 15 - 30 days
A-2	S	Shrub / Succulent	1"	1	1	Succulents to receive irrigation: Limberbush, Mountain Yucca	Newly Planted: 1 hour daily Established: 1 - 2 hours / 3 - 15 days

NOTE: No cacti to receive irrigation, unless noted otherwise. Hand water to establish.

### VALVE CALLOUT

Controller Station ID — A-1 T – Valve Description GPM - Valve Flow (GPM)

NOTES:

- 1. Run times and frequencies are suggestions. Water requirements for plants depend on many factors (soil type, shade / sun conditions, plant type, plant maturity, plant drought tolerance and weather). Owner is responsible for observing plants and adjusting schedules as needed.
- 2. Run times and frequencies shown for June, the highest water demand month in Tucson. Reduce the irrigation frequency during other times of the year. Smart controllers can be programmed to do this automatically.
- 3. Plant establishment requires 2 3 years. Water frequency for newly planted plants may be reduced after a month or two in the summer.
- 4. After establishment, native cacti planted in-ground can be removed from the irrigation system completely. Other succulents may need some supplemental irrigation in the hot months.
- 5. In general, longer, less frequent waterings are preferred to shorter, more frequent ones. Run the valve the time it takes to wet the root zone (3' deep for trees, 2' for
- 6. Signs of inadequate water: leaves wilting, curling or drooping; yellowing or drop-off of older leaves; dead stems or branches. 7. Signs of excess water: brittle leaves remaining on plant; wilted shoot tips; soft, smelly tissue; presence of algae, moss or mushrooms.

3. A new mainline will be run from the water service line point of connection to the valve location as shown on the plans. The mainiline will also serve 5 hose bib / wall hydrants as

shrubs, 1' for small shrubs and cacti). Use a soil probe or metal rod to determine water depth. The rod can be inserted into the soil as deeply as the water depth.



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## WILDER Landscape Architects

2738 East Adams Street Tucson, Arizona 85716 Jennifer Patton, 520-320-3936 jennifer@wilderla.com




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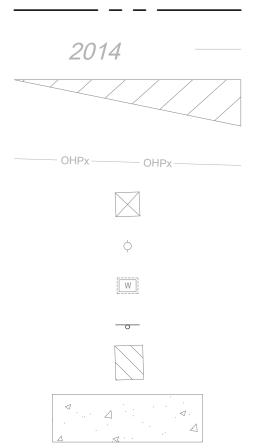
380 S. MEYER AVE. TUCSON, AZ 85701

IRRIGATION PLAN

DRAWN BY: Wilder Team REVISIONS CHECKED BY: JP NO. DATE ISSUE

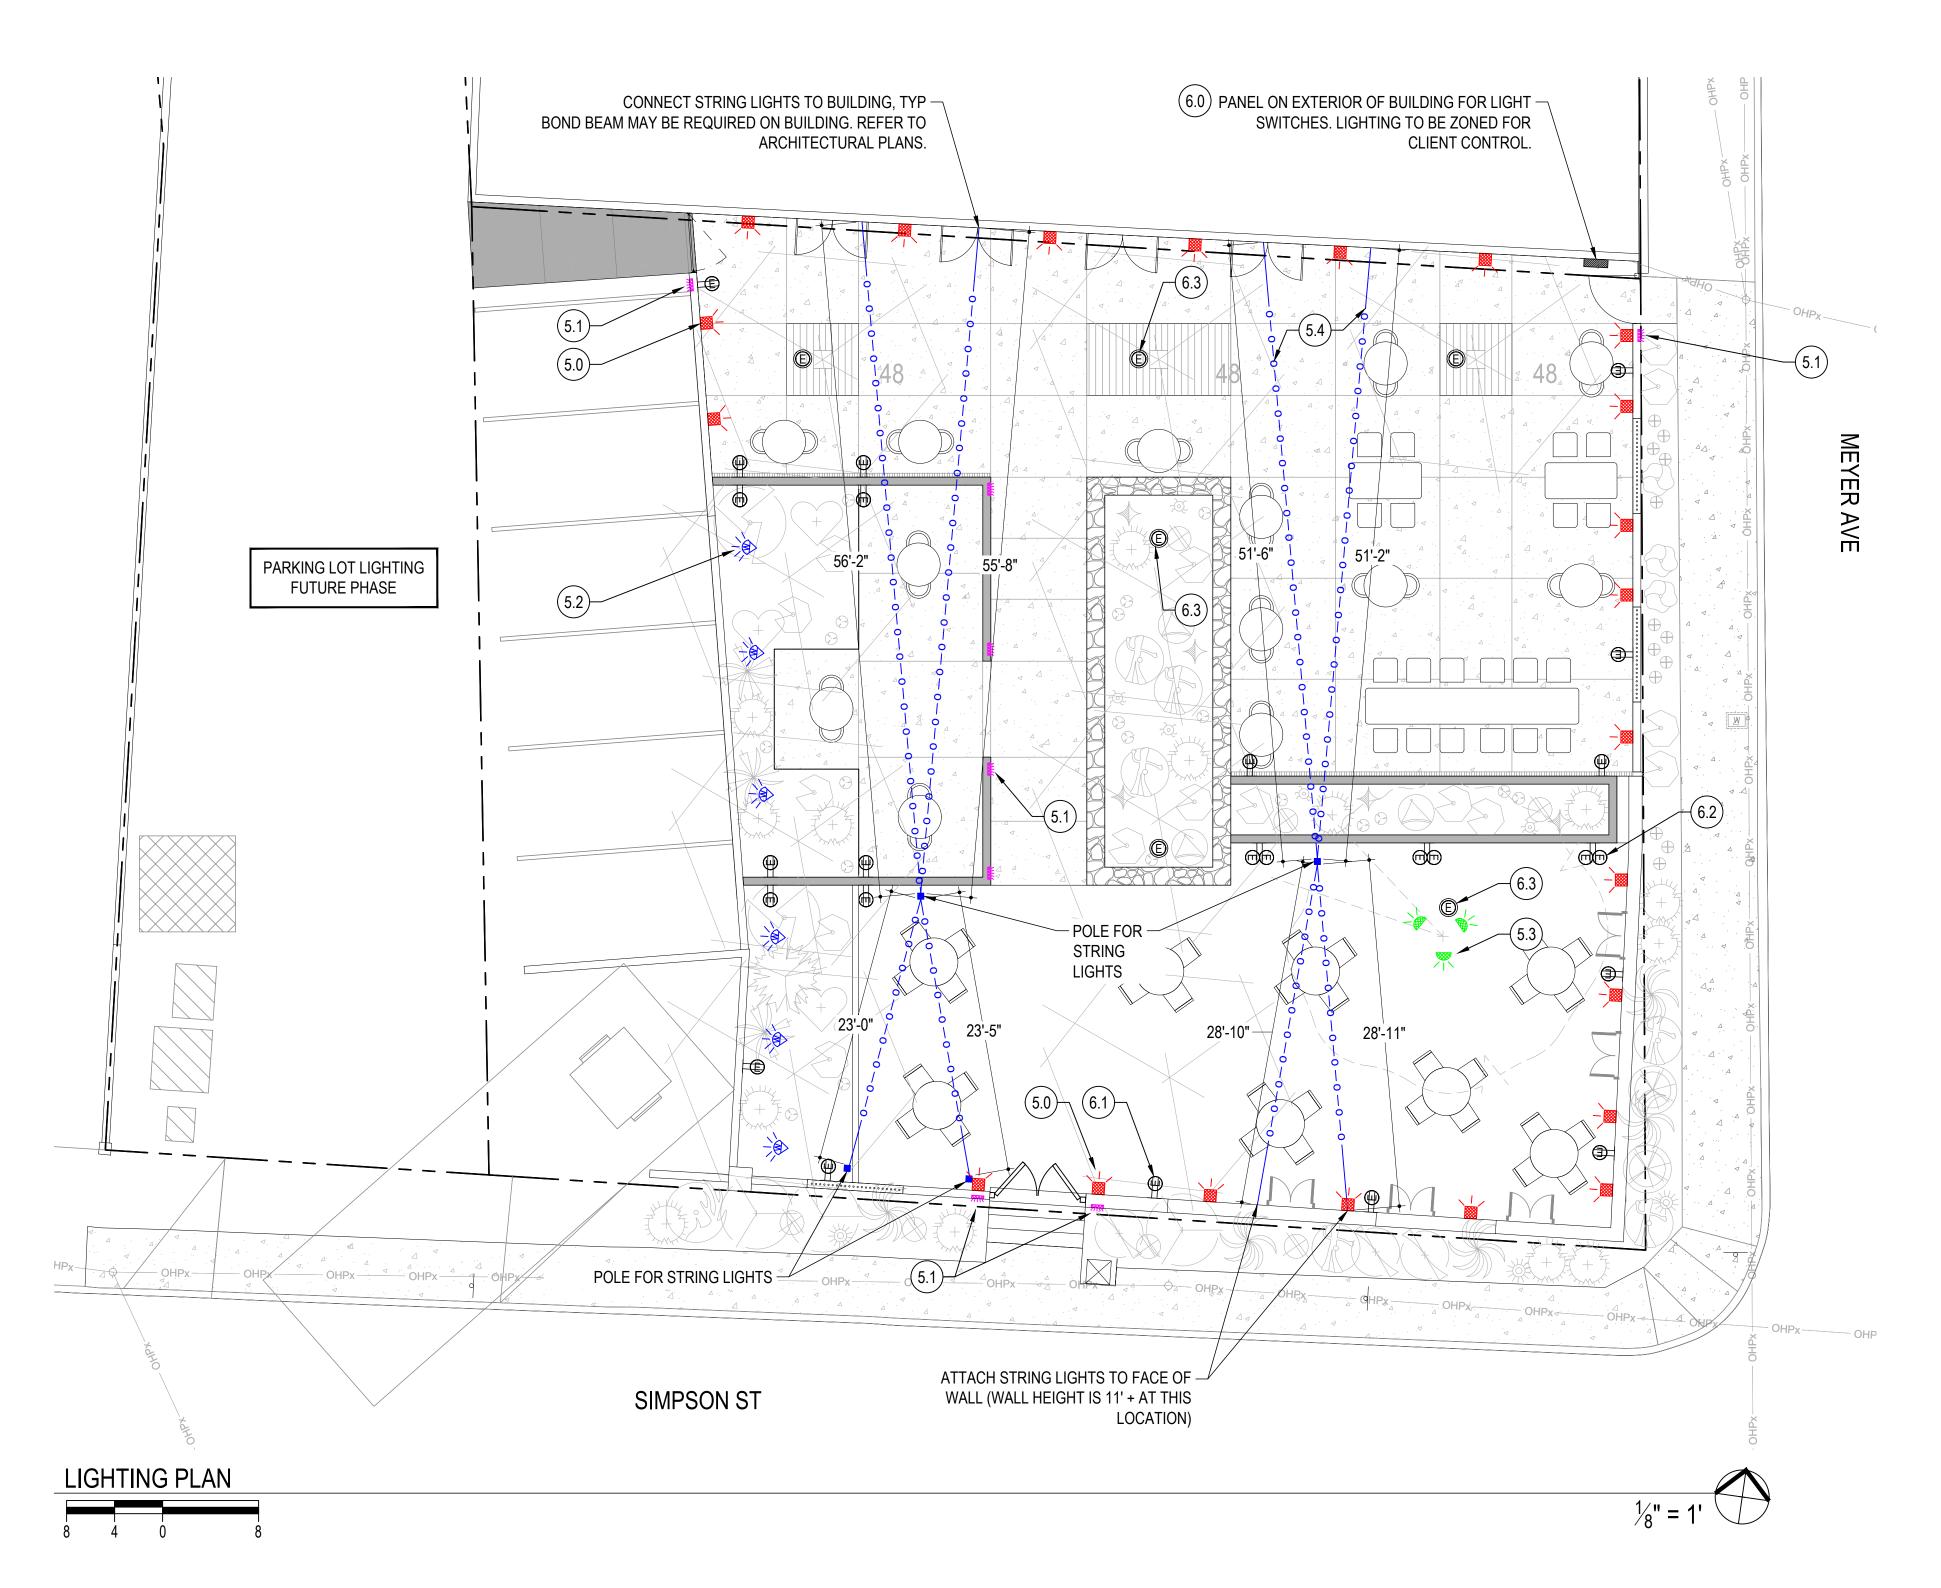

### SYMBOL / LINETYPE LEGEND (EXISTING ELEMENTS)



- - PROPERTY BOUNDARY EXISTING CONTOUR

SITE VISIBILITY TRIANGLE

OVERHEAD ELECTRICAL

- BURIED UTILITY BOX
- UTILITY POLE
- WATER METER
- TRAFFIC SIGN ABOVE-GROUND UTILITY BOXES
- SIDEWALK, 5' WIDTH

## LIGHTING NOTES

 This Plan depicts lighting intent. Fixture selection and wire runs will be reflected on the Electrical Plan prepared by the Lighting Consultant.

#### LIGHTING SCHEDULE -LINE VOLTAGE LIGHTS

SYMBOL	DESCRIPTION	KEYNOTE	QTY
-	Wall Sconce, Down Light	(5.0)	22 EA
<b>7112</b>	Wall Light, Flush	(5.1)	9 EA
	Wall Wash	(5.2)	6 EA
-	Hanging Down Lights or Lights wrapped around tree trunk / branches (strand lights)	(5.3)	TBD
0000	String Lights mounted to stainless steel cables strung between building and steel posts in lower patio	(5.4)	318' - 8"

ELECTRICAL OUTLETS + SWITCHES					
SYMBOL	DESCRIPTION	KEYNOTE	QTY		
	Panel for Light Switches (Phase 1 use)	6.0	1 EA		
Ē	Duplex Electrical Outlet, Wall Mount	6.1	22 EA		
P	Quad Electrical Outlet, Wall Mount	6.2	3 EA		
Ē	Electrical Outlet on Steel Riser (free-standing)	6.3	6 EA		





REPRESENTATIVE FIXTURES ILLUSTRATING DESIGN INTENT





String Lights



Wall Light, Flush



Tree Lights (existing tree)



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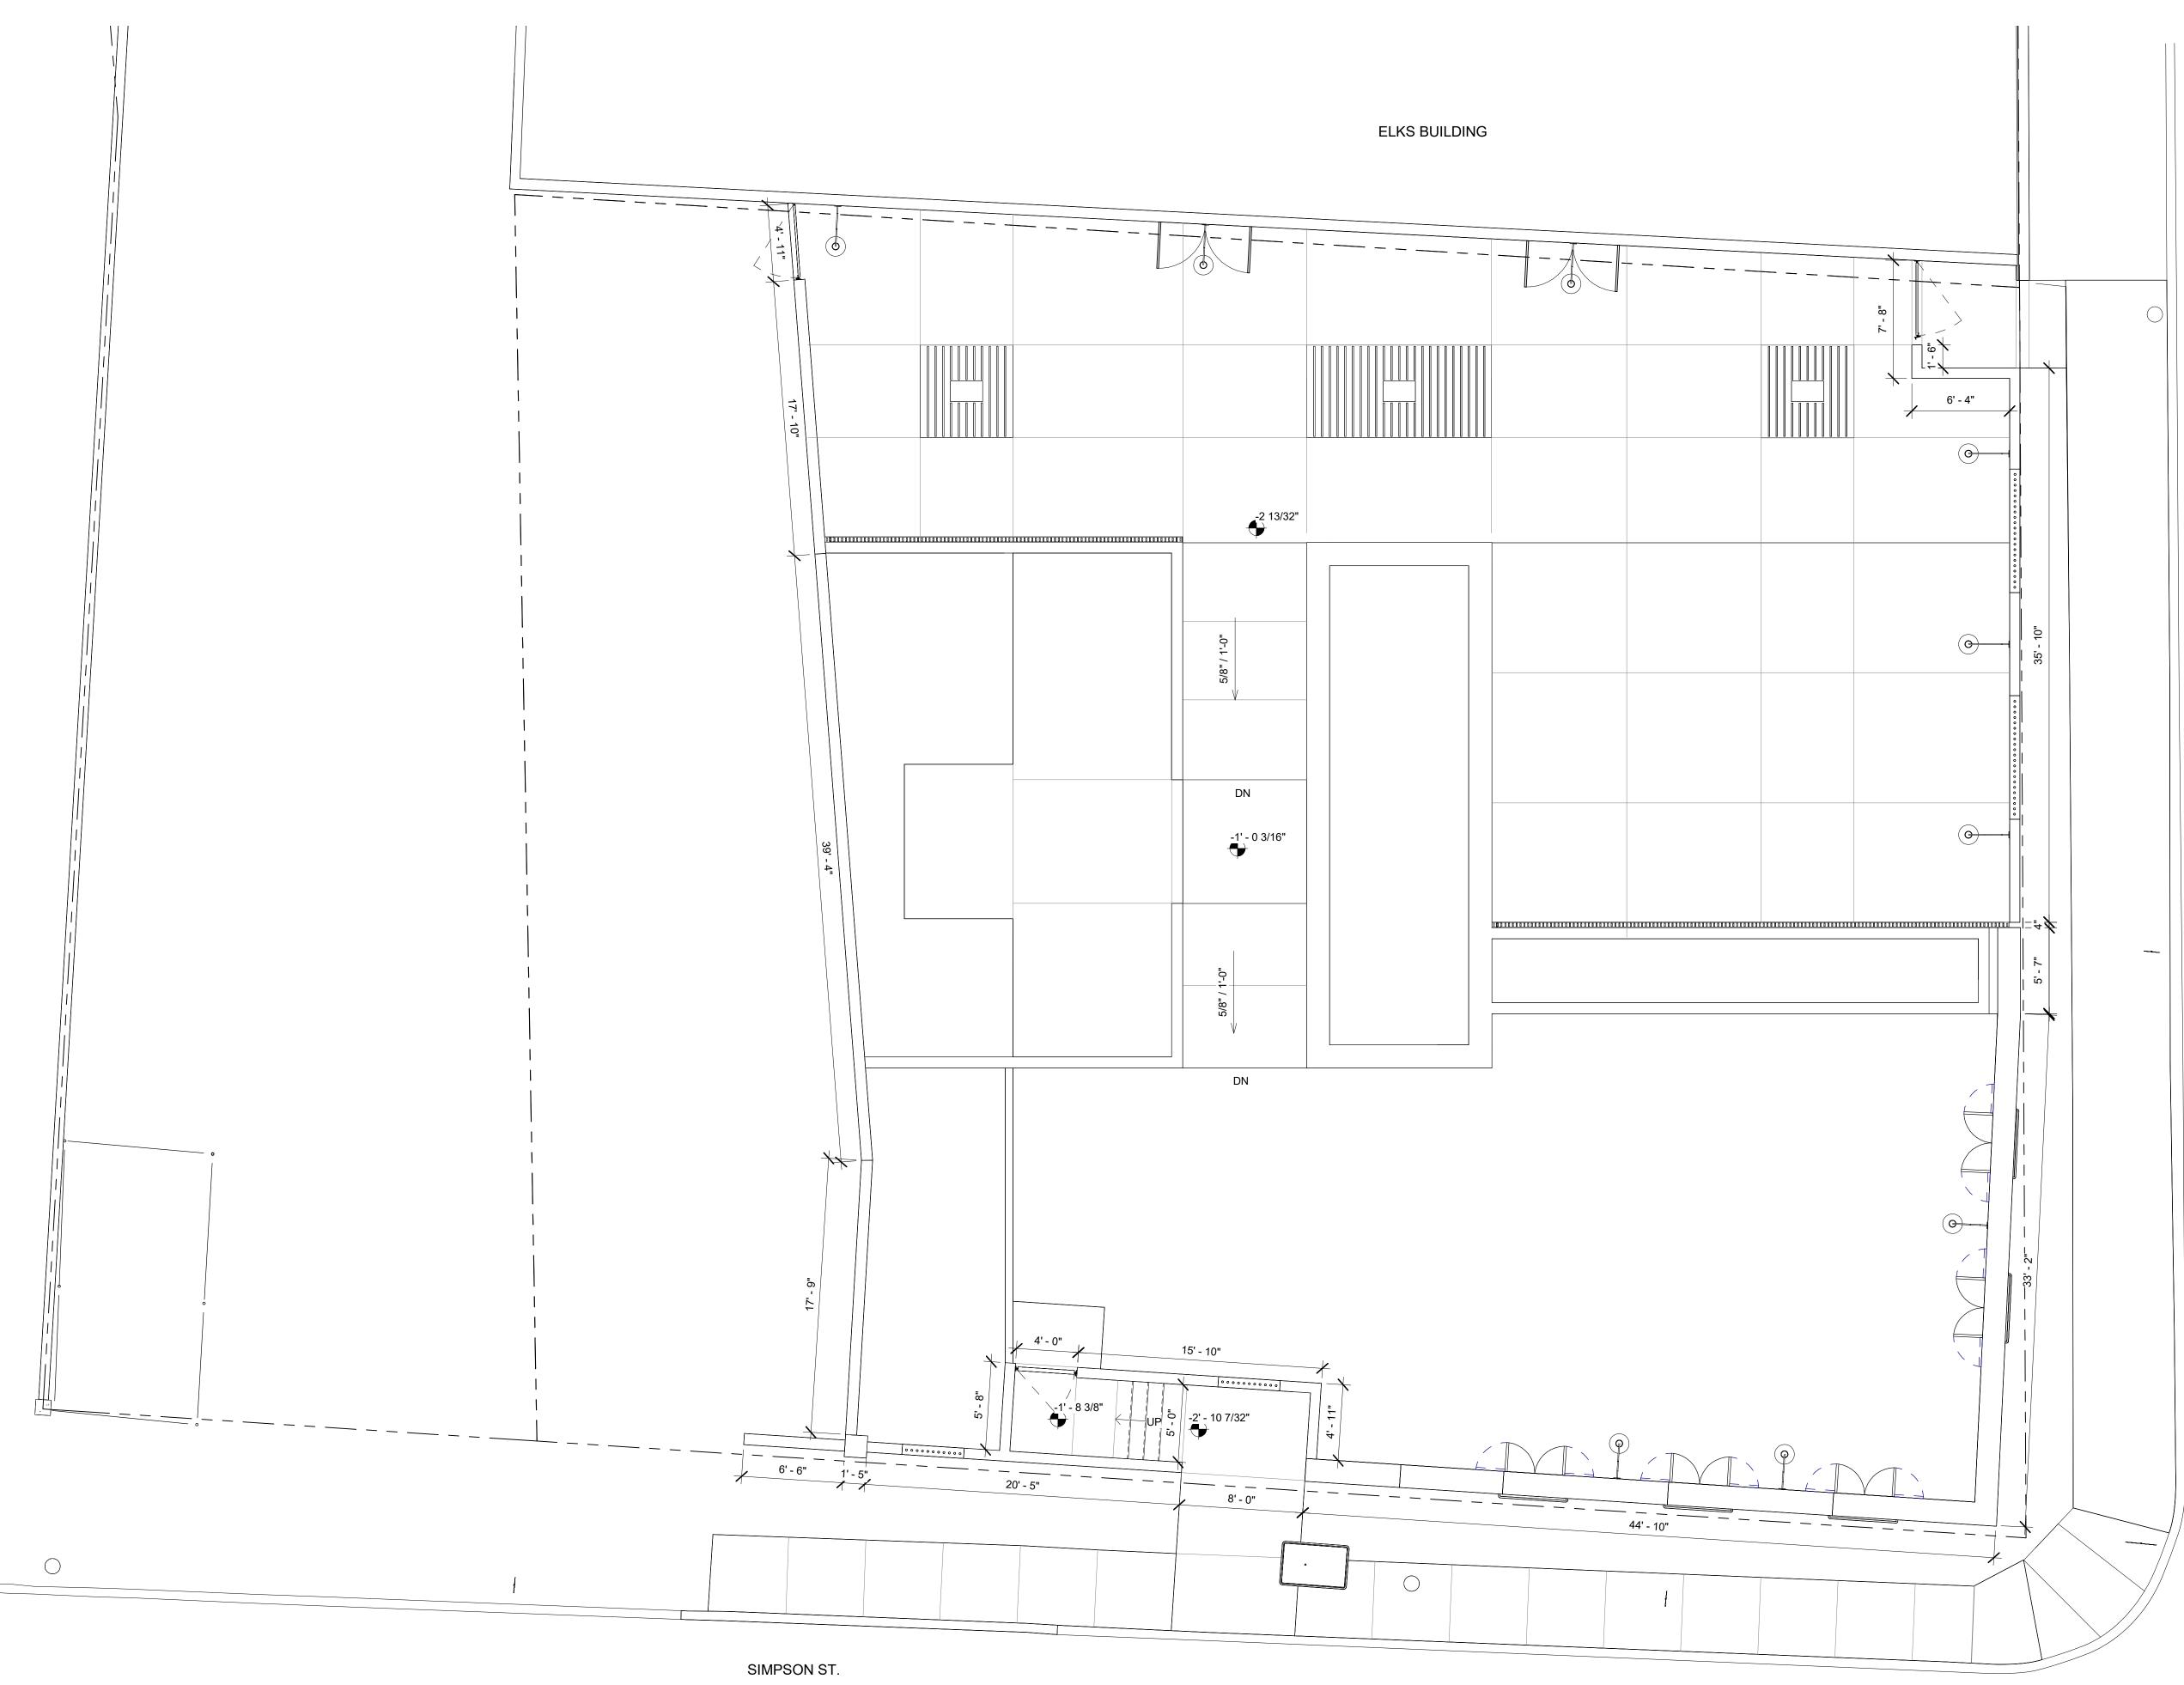
380 S. MEYER AVE. TUCSON, AZ 85701

L6

LIGHTING PLAN

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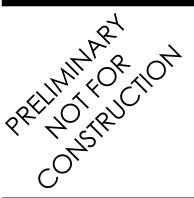




1 PATIO SITE PLAN - DIMENSION SCALE: 3/16" = 1'-0"

PMM ARCHITECTURE PLANNING PRESERVATION

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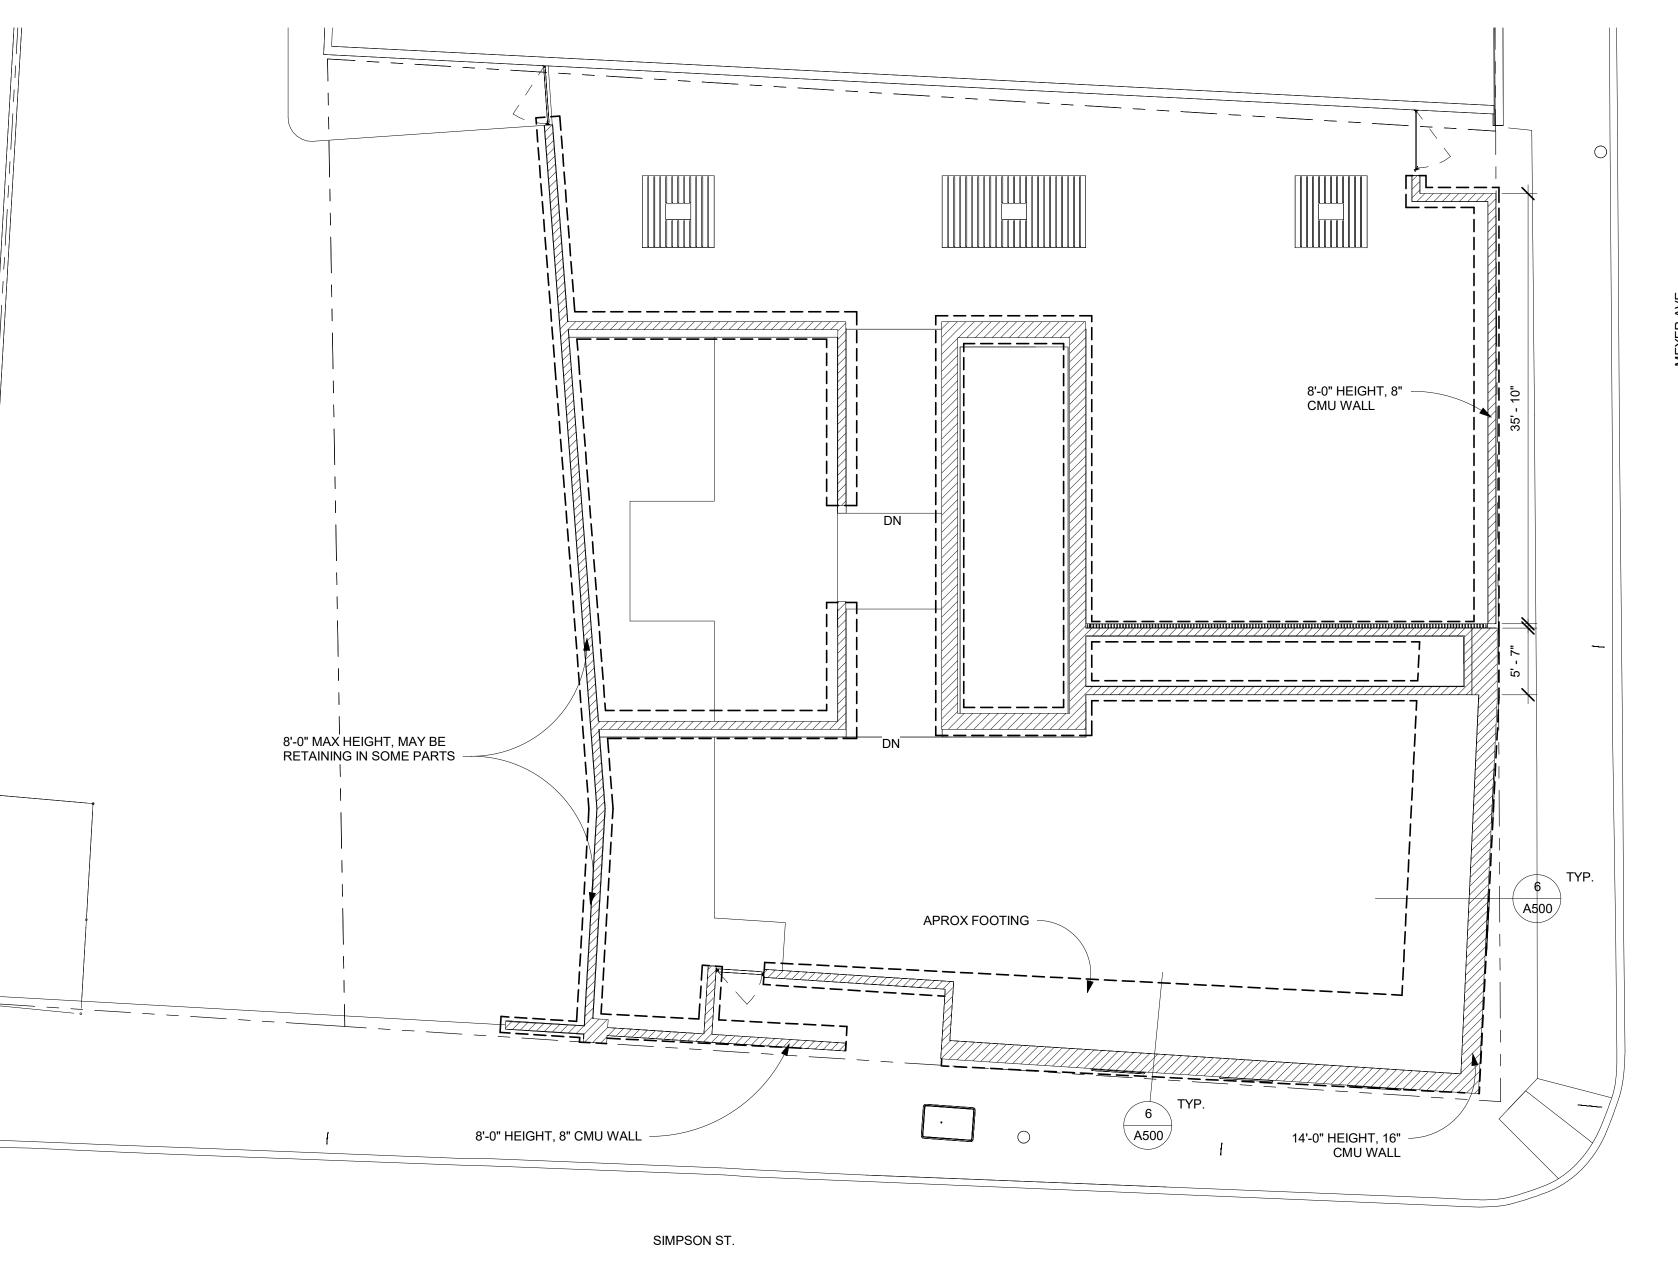
TEATRO CARMEN REHABILITATION OF HISTORIC THEATER 380 S. MEYER AVE. - TUCSON, AZ 85701

A101

PATIO PLAN DIMENSION

DRAWN BY: Author REVISIONS CHECKED BY: Checker NO. DATE ISSUE

 $\bigcirc$ 



1 PATIO WALL FOOTING PLAN SCALE: 1/8" = 1'-0"



MIRTO McDONALD

KEYNOTES





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A102

FOUNDATIONS PLAN & DETAILS

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2' - 4" 4' - 0"

5.03

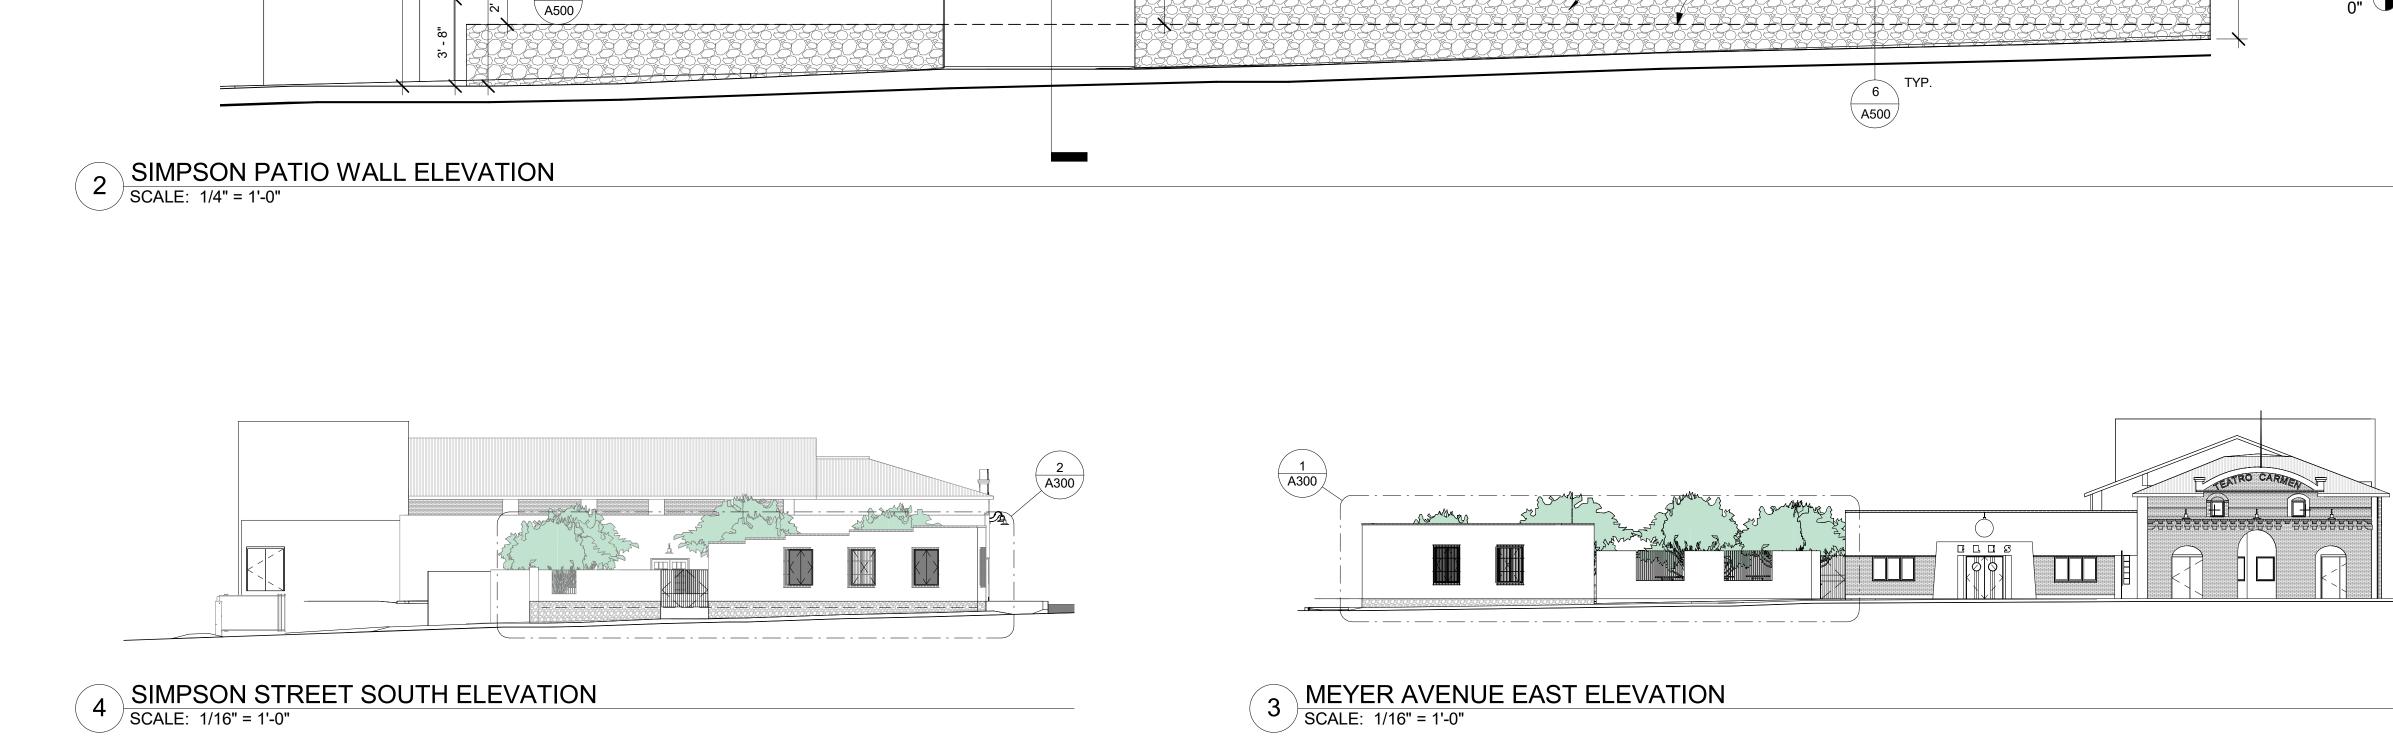7' - 11"

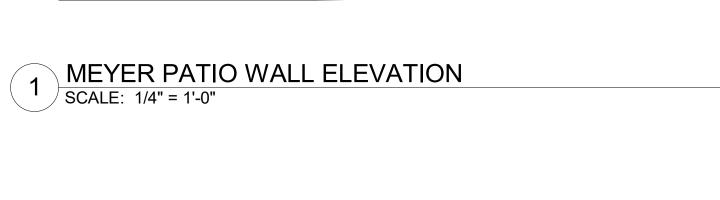
4.01 -


20' - 5"

5 A500

14' - 1"

-(4.01)

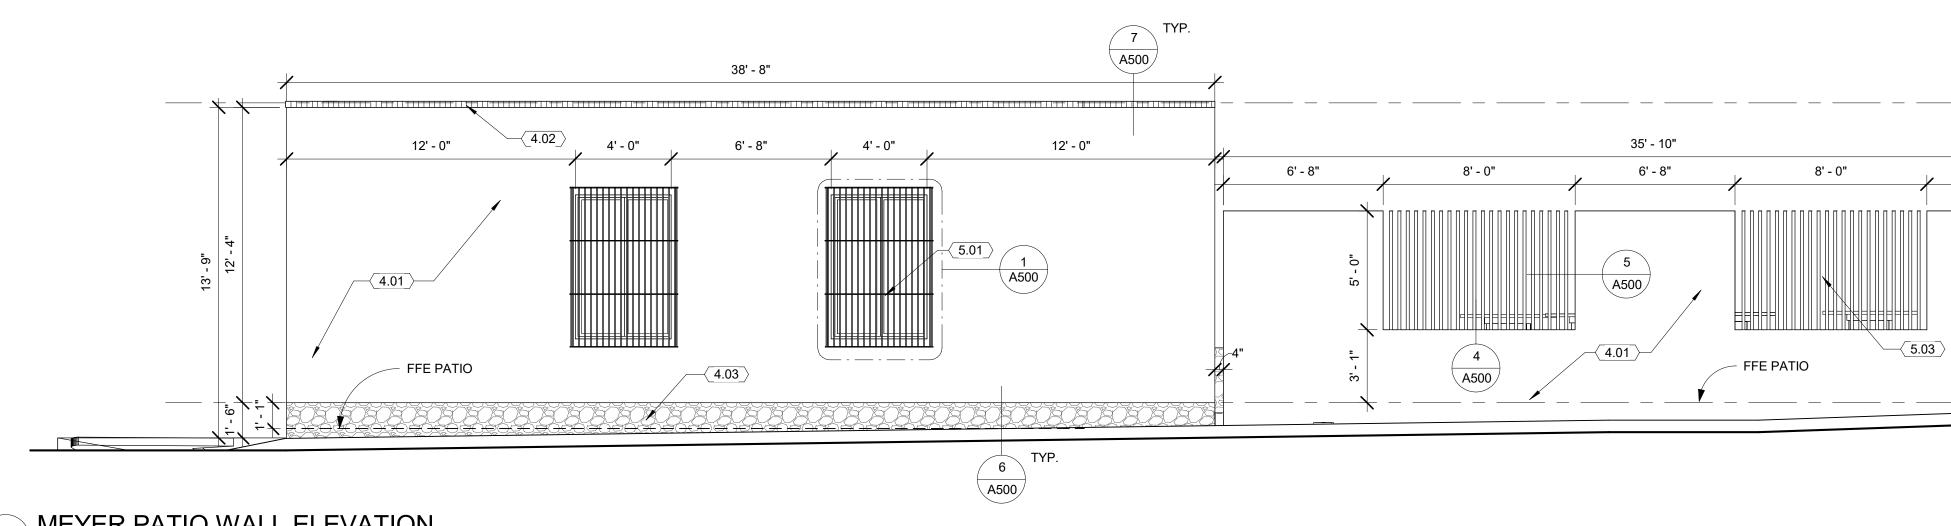

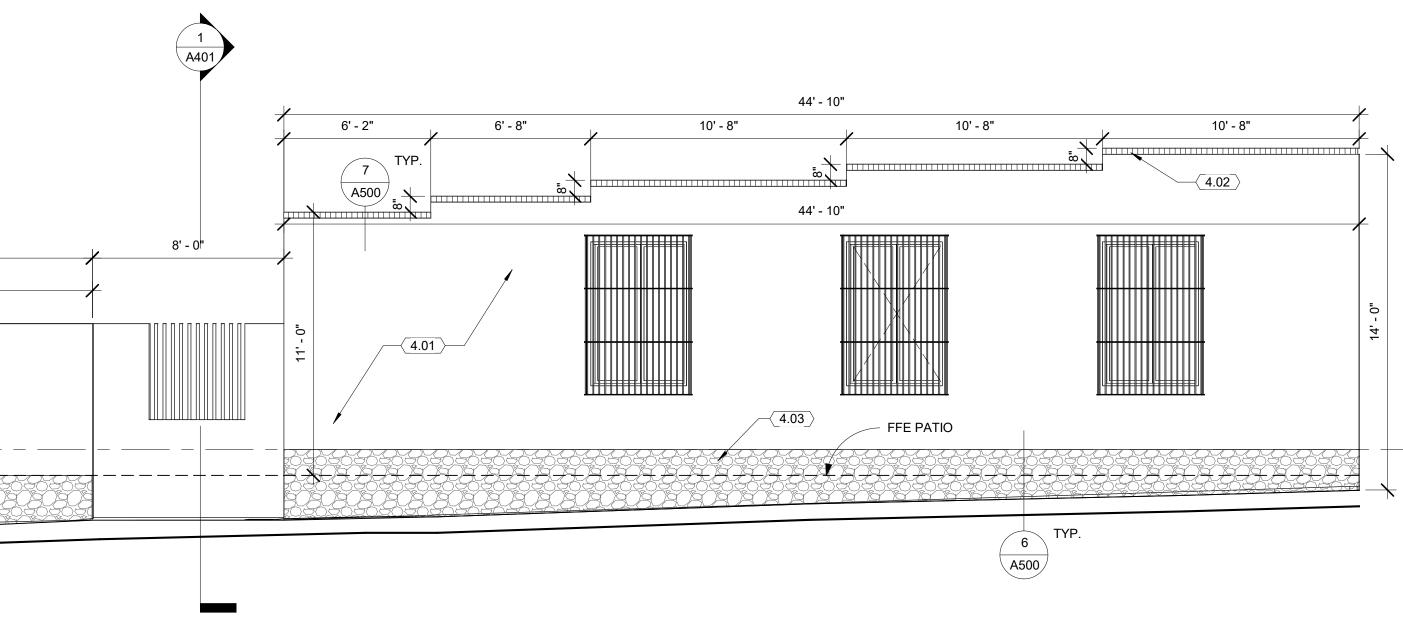




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#### KEYNOTES

4.01	
4.02	
4.03	
5.01	
5.03	
5.04	

CMU, CEMENT STUCCO, PAINT RED BRICK CAP STONE VENEER 1 1/2" STEEL PIPE WROUGHT IRON GATE

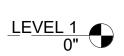


<u>(5.04</u>)

6' - 6"

LEVEL 2 12' - 6"

<u>LEVEL 1</u> 0"

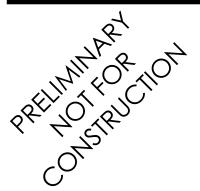



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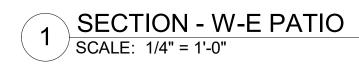
A300


PATIO WALL ELEVATIONS

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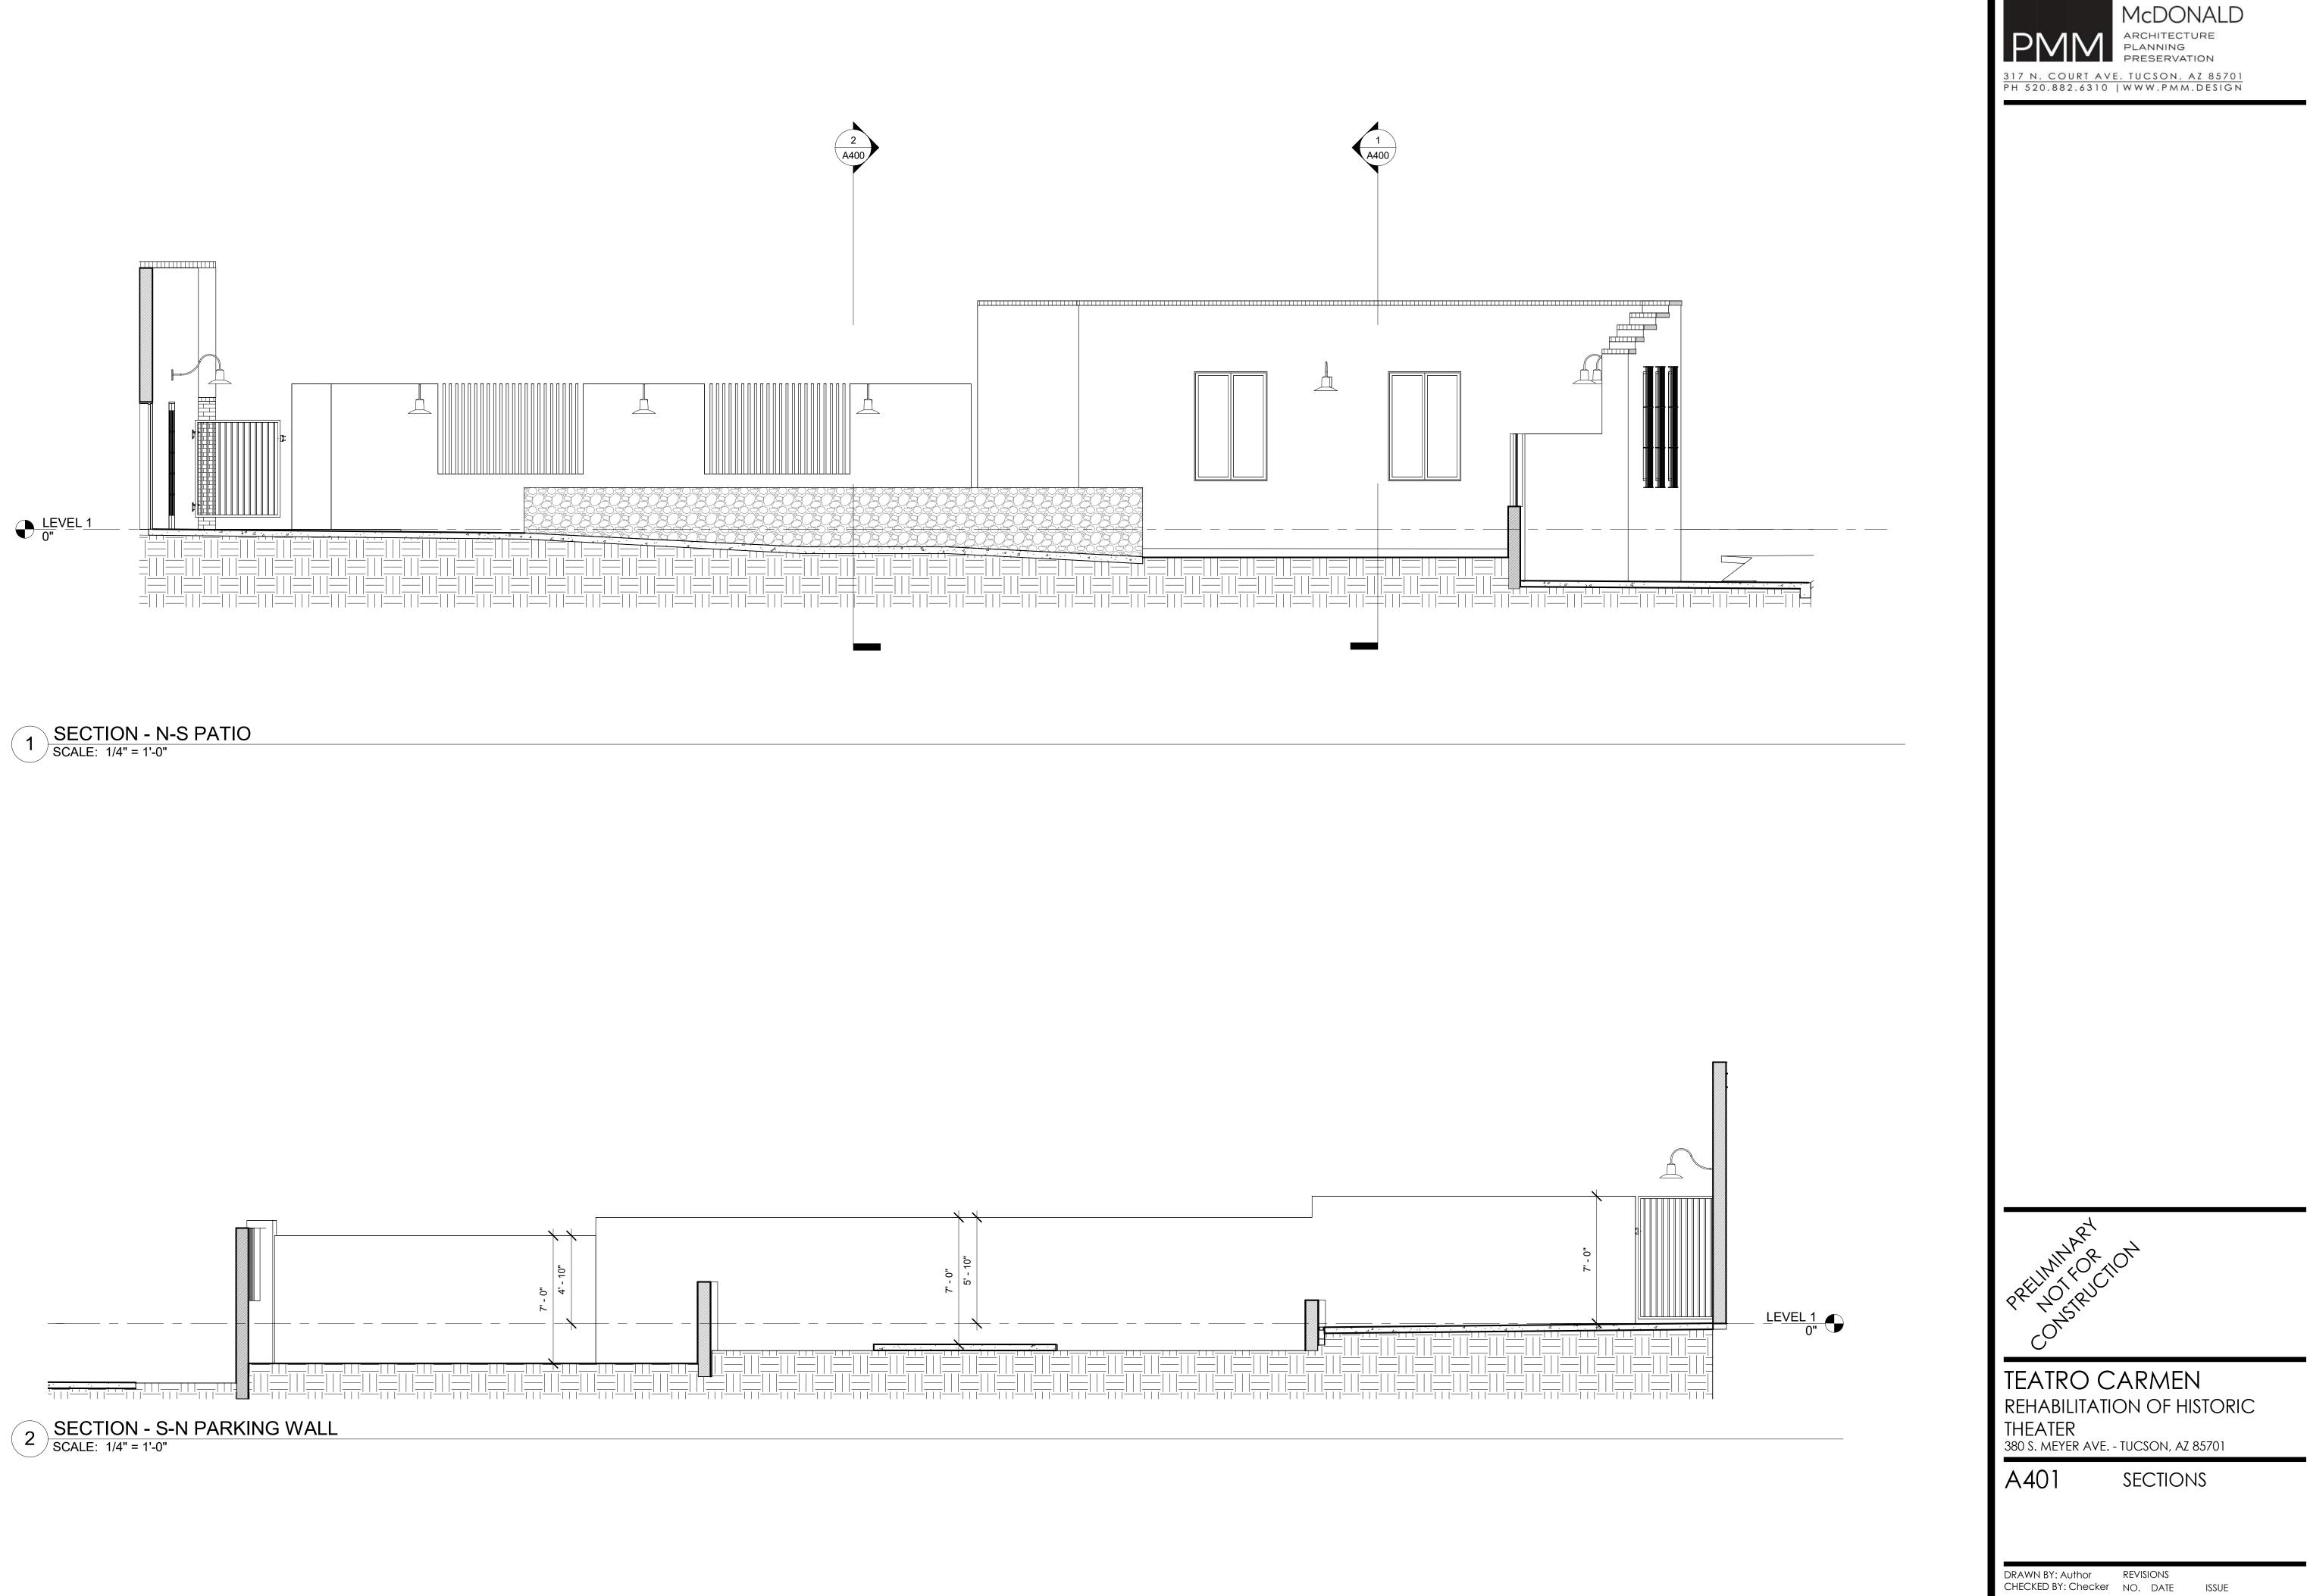



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A400

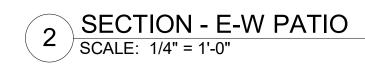SECTIONS
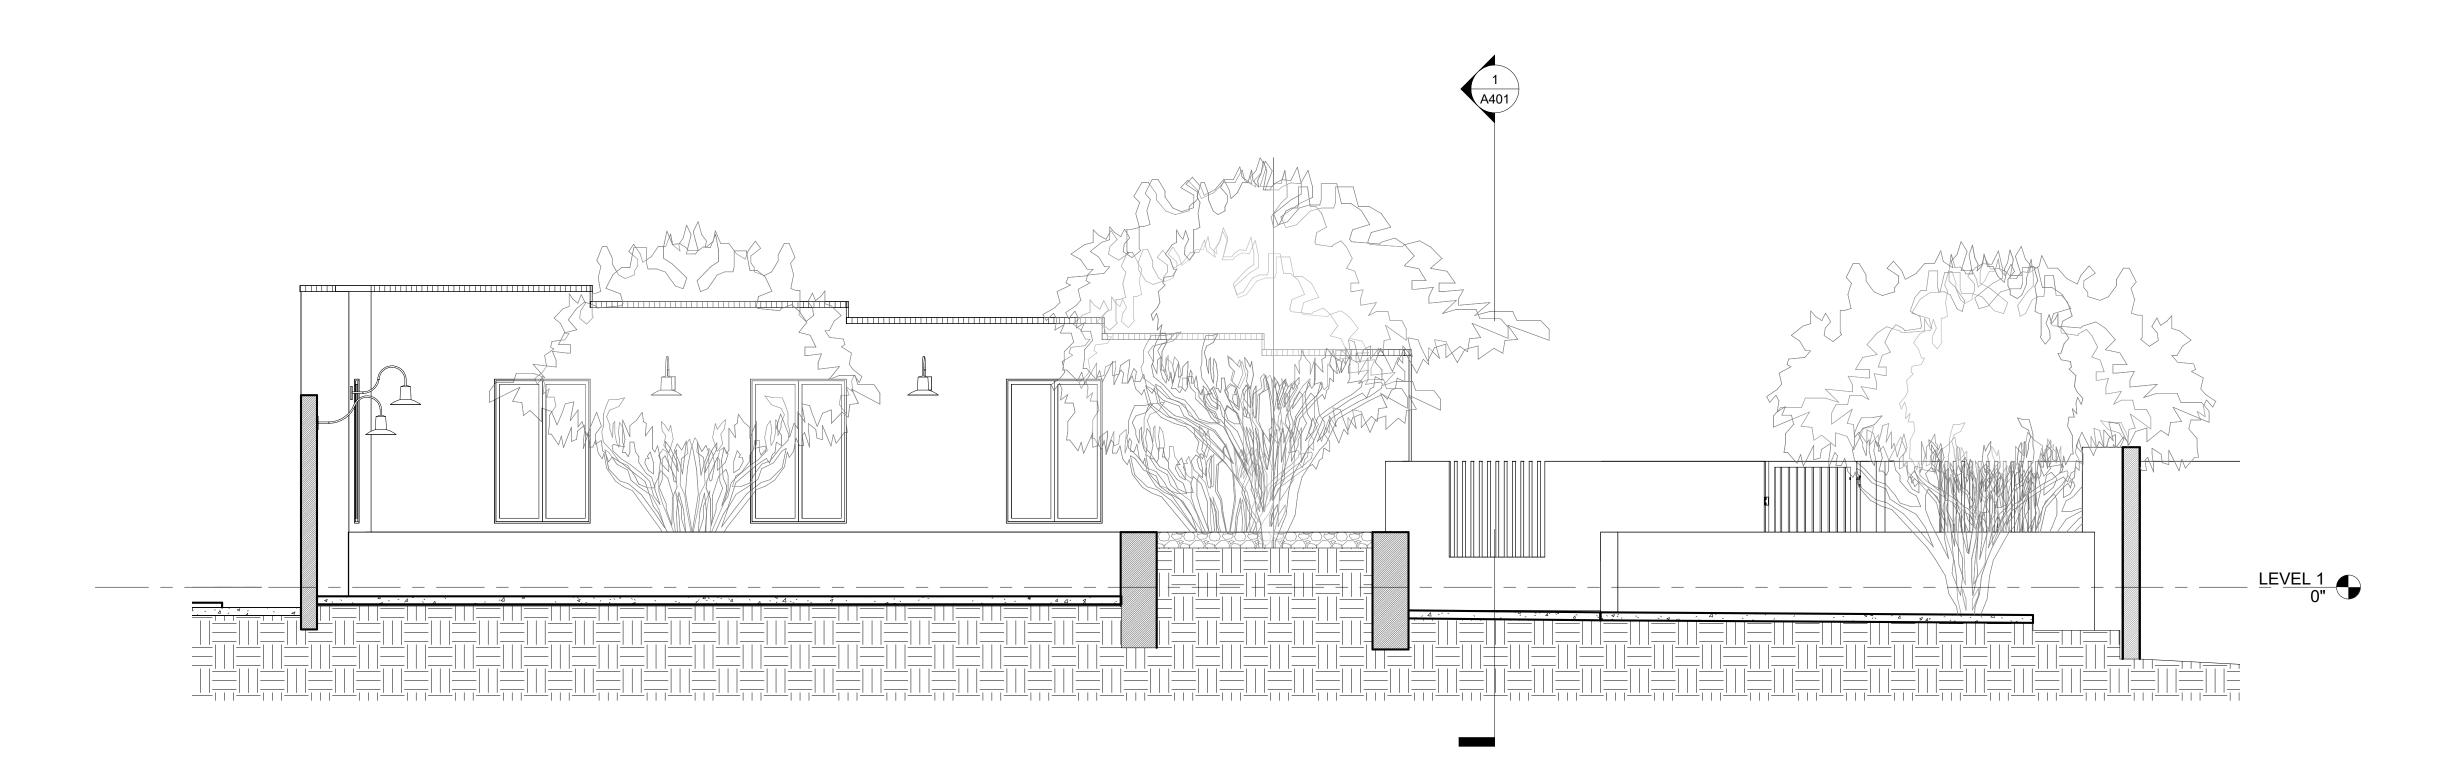
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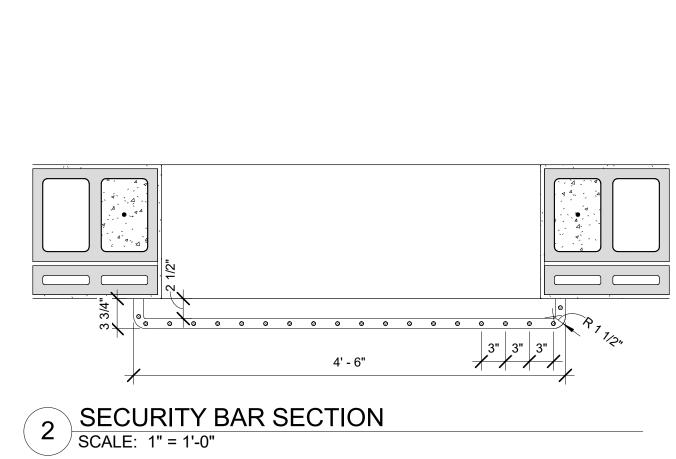


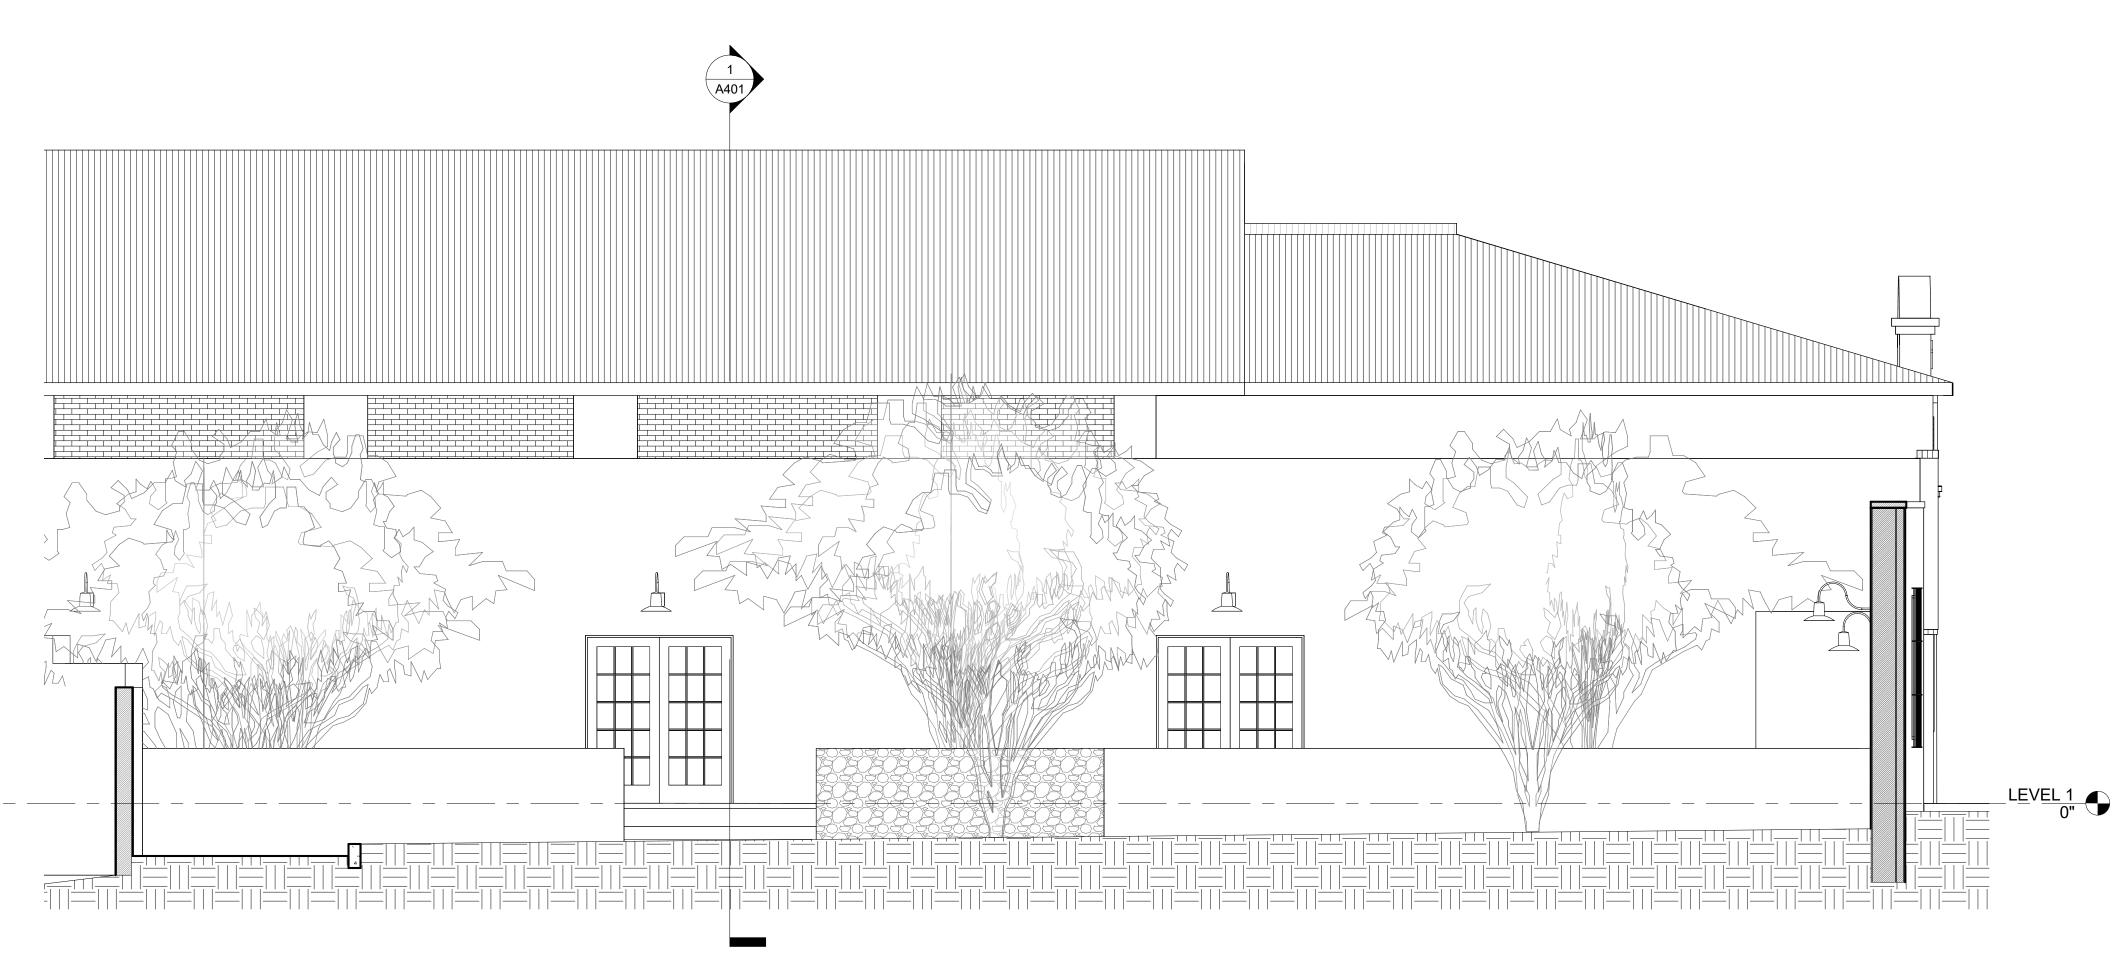


© DATE: 5.31.2022 PROJECT NO: A-1553
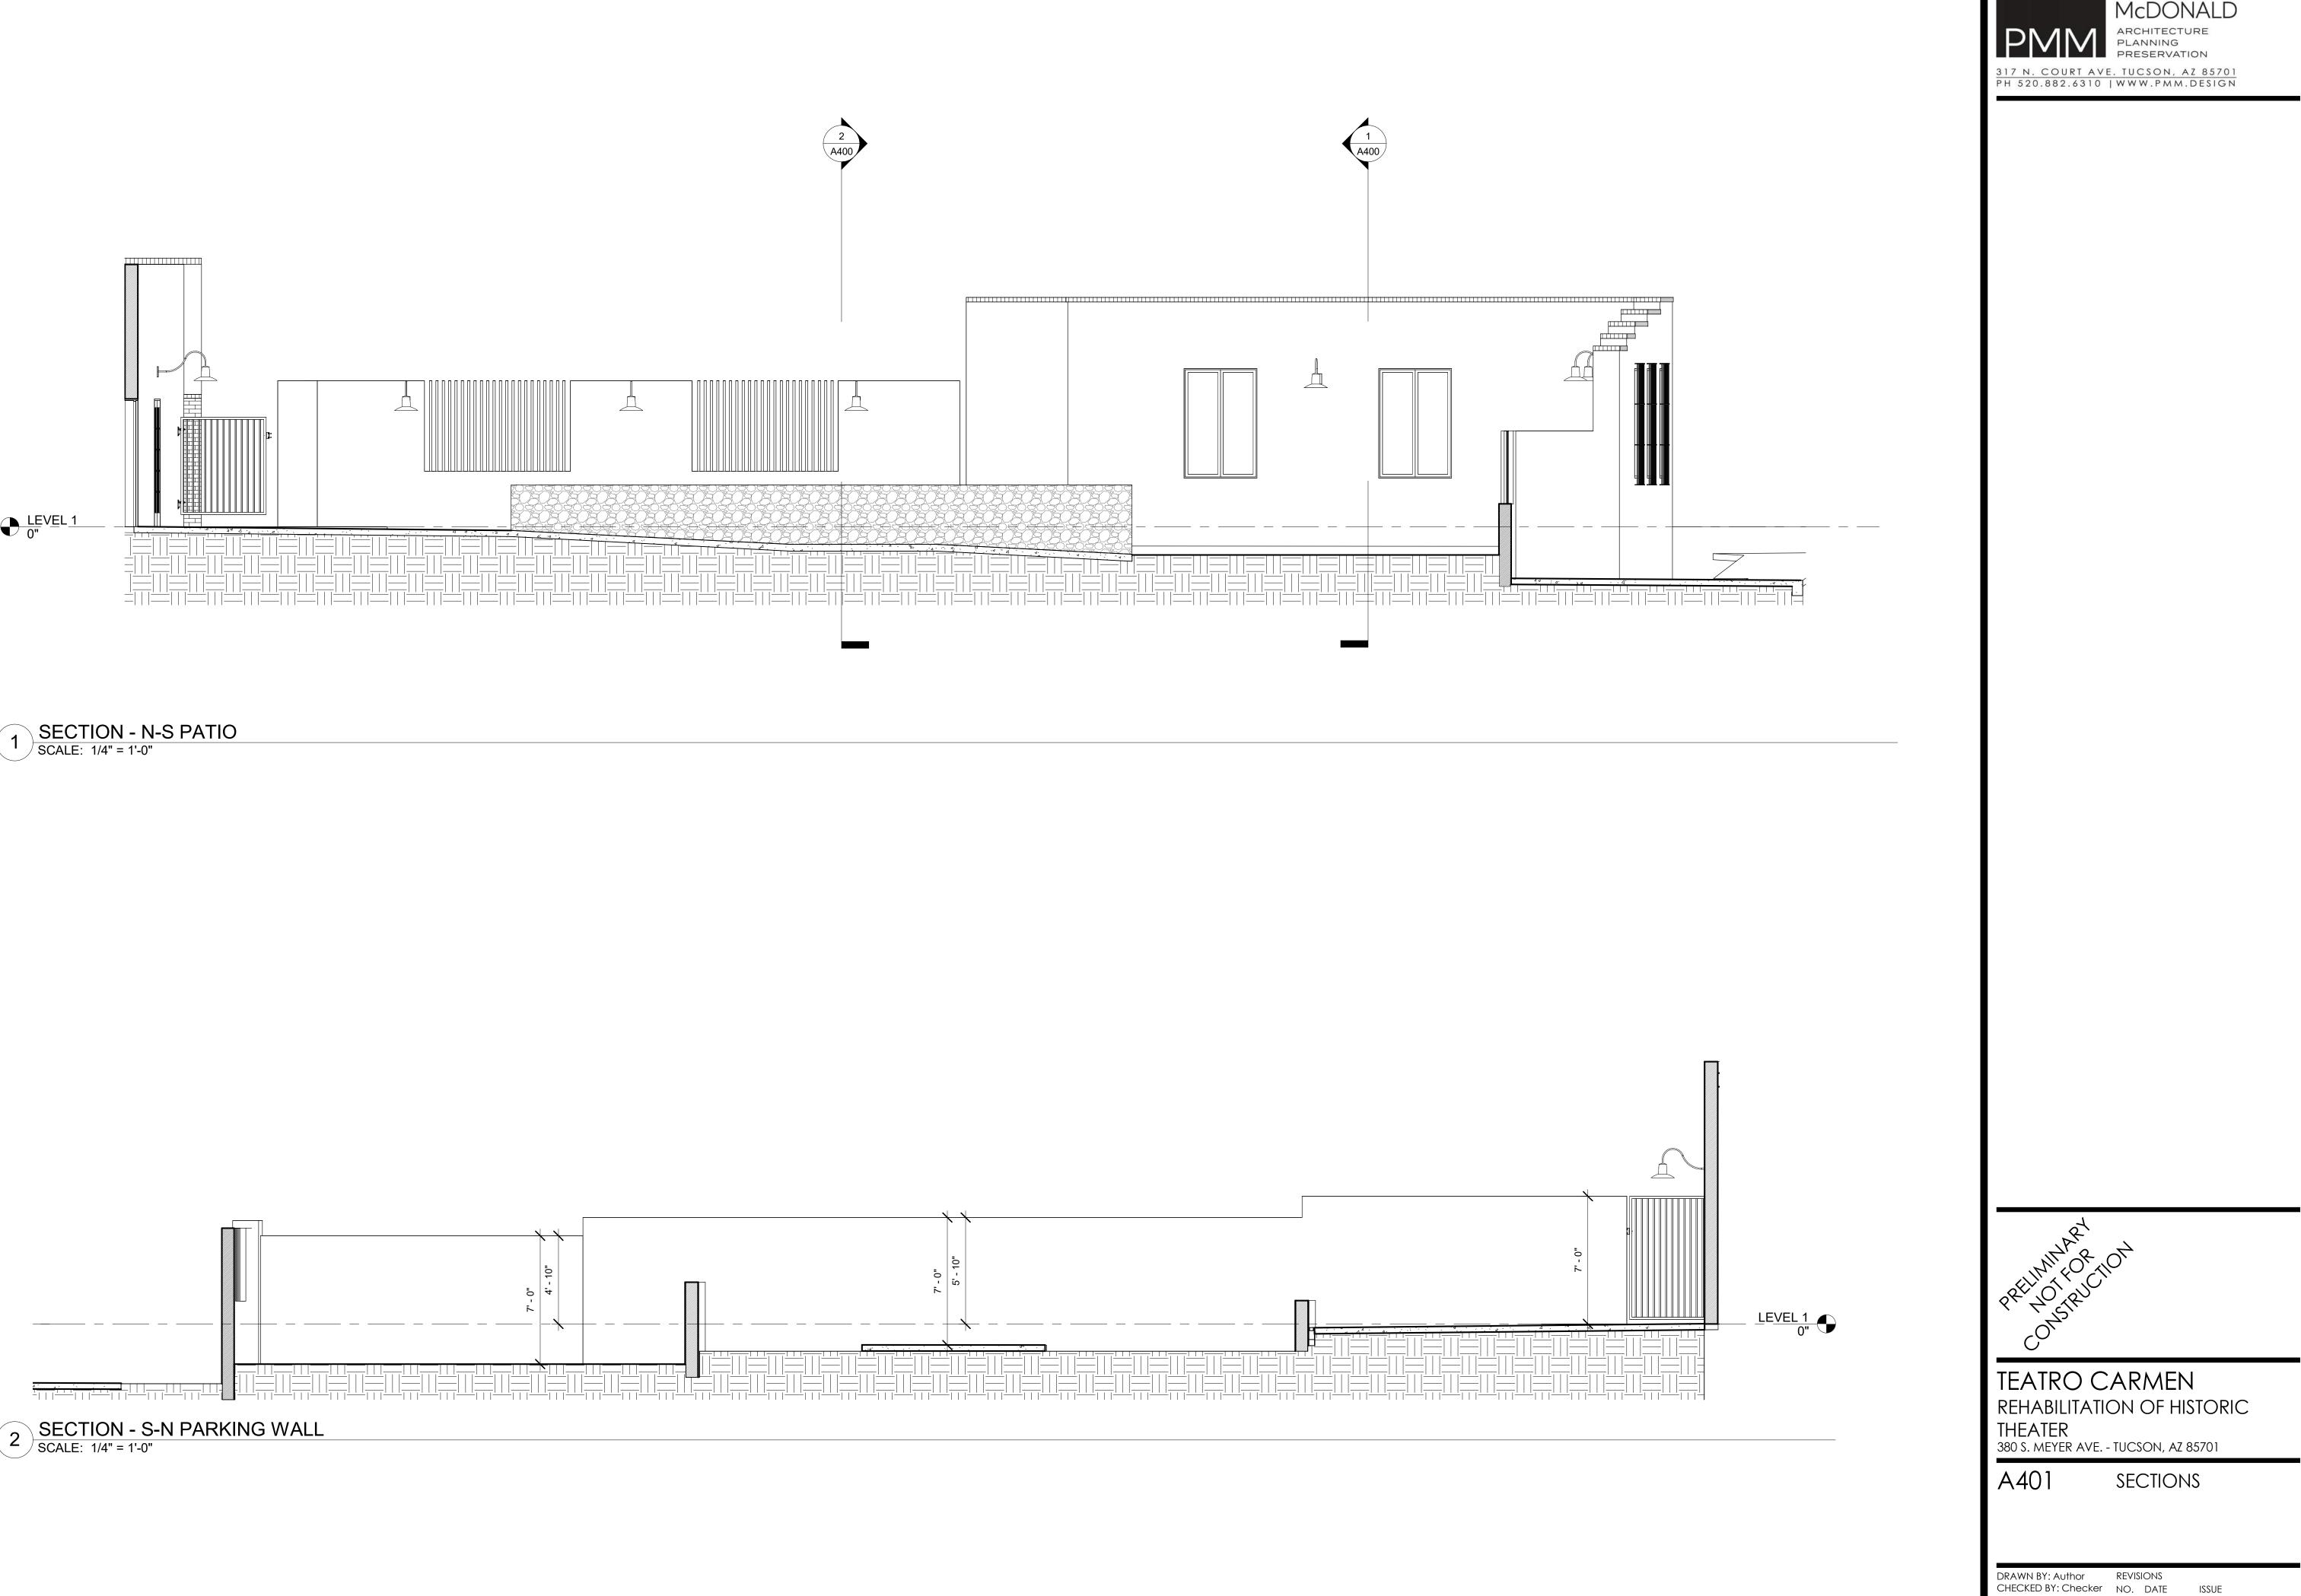
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MIRTO




1 SECURITY BARS SCALE: 1" = 1'-0"

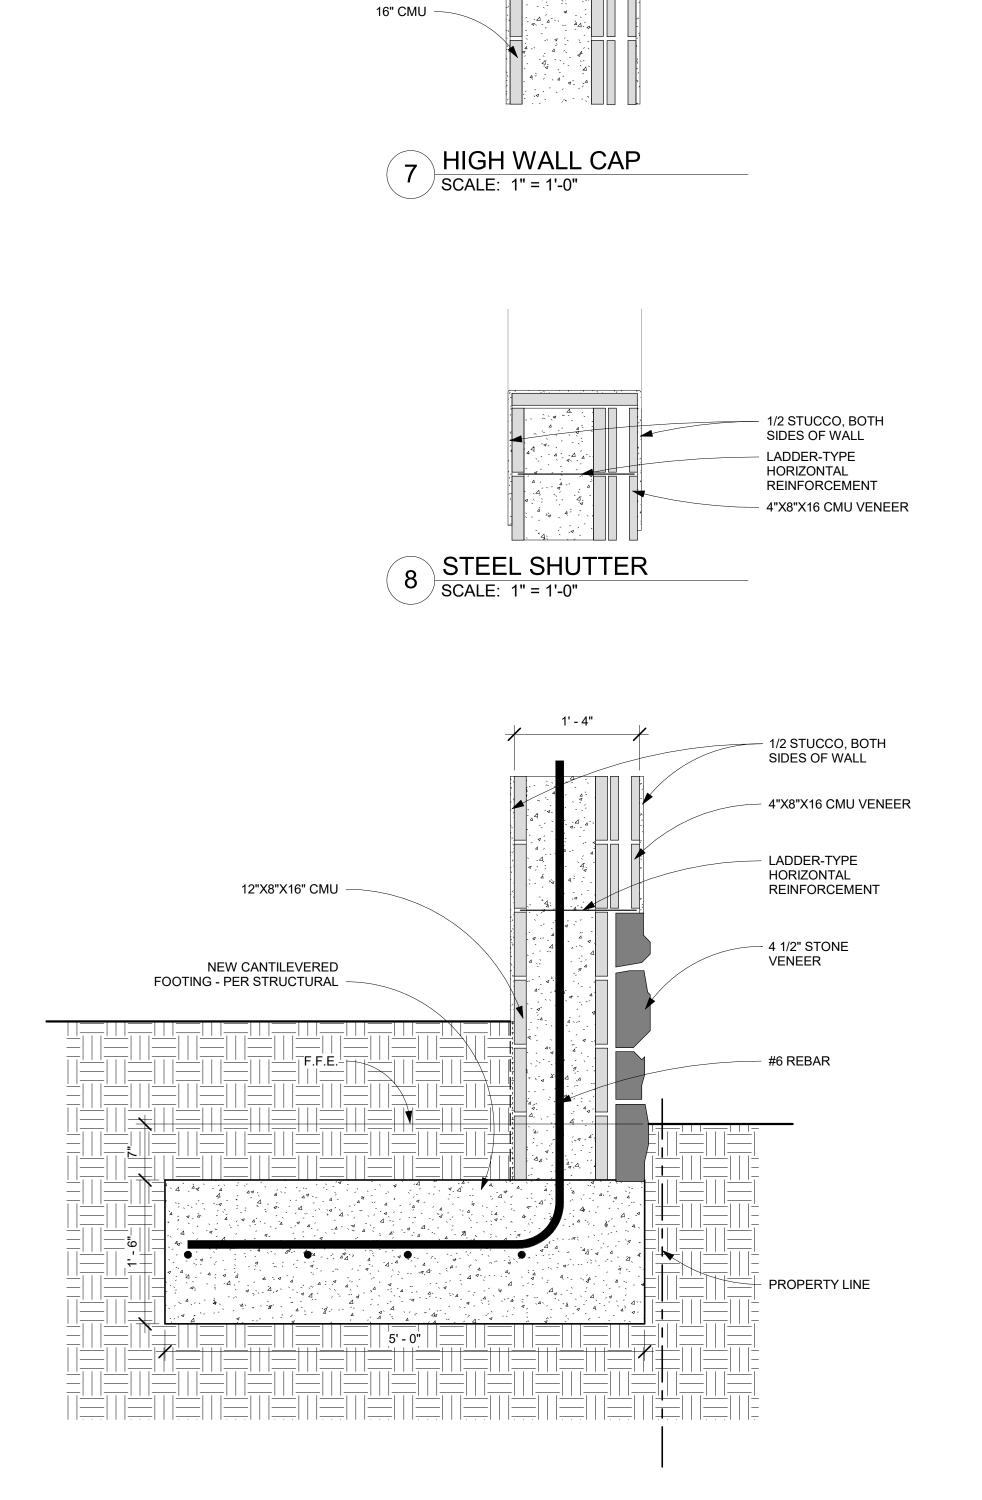


SOILD RED BRICK CAP

1' - 3 3/4" 🦯

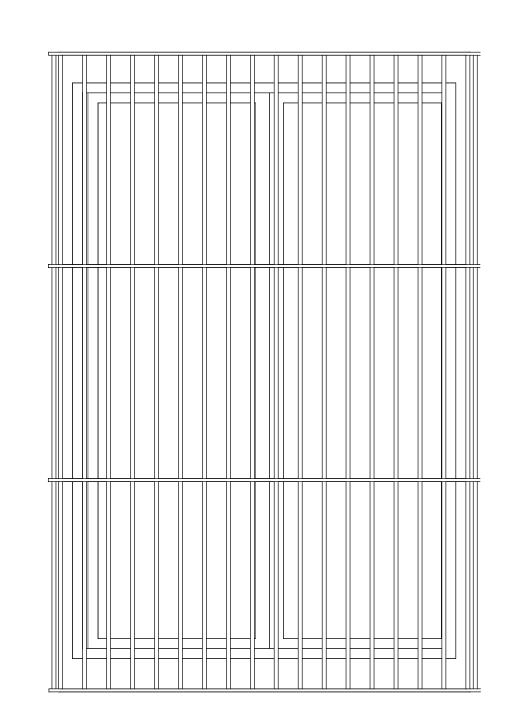

# 6 HIGH WALL FOOTING DETAIL SCALE: 1" = 1'-0"

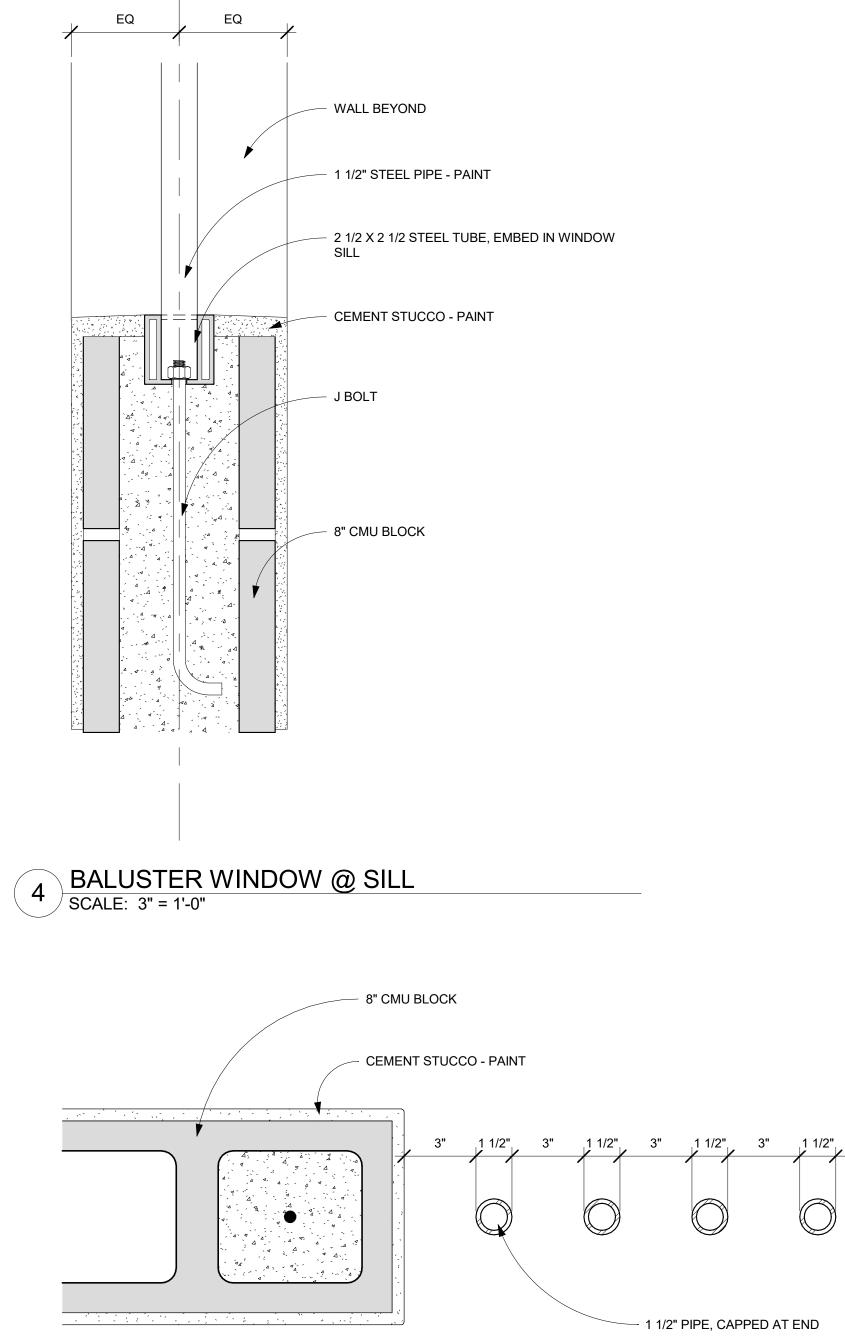

5 BALUSTER WINDOW @JAMB SCALE: 3" = 1'-0"



POSTER MIRTO McDONALD




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A500

DETAILS

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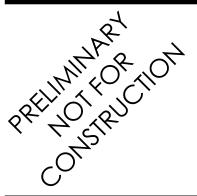
-1-1/2" CAP BLOCK

-PAINTED STUCCO FINISH

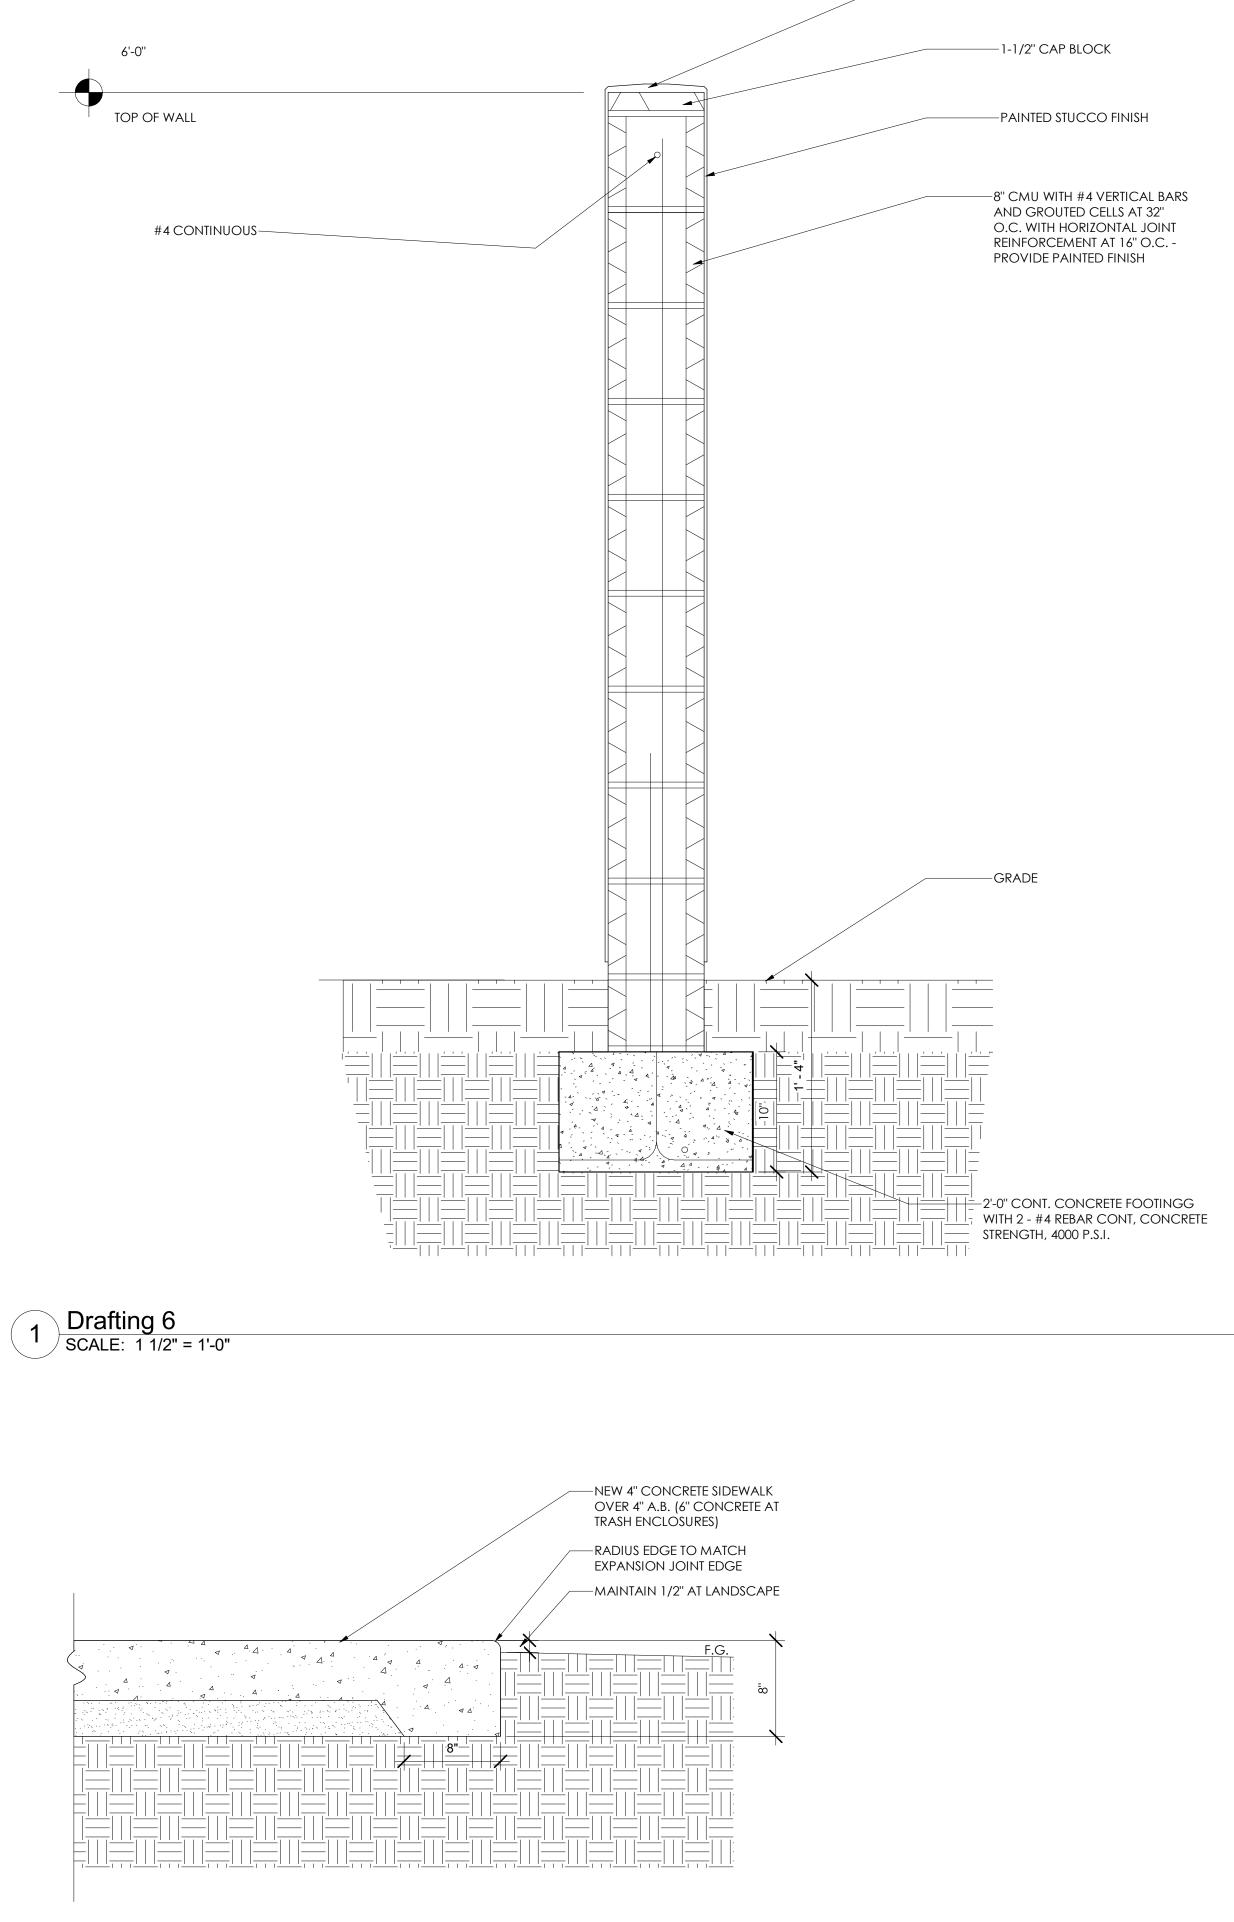-8" CMU WITH #4 VERTICAL BARS AND GROUTED CELLS AT 32" O.C. WITH HORIZONTAL JOINT REINFORCEMENT AT 16" O.C. -PROVIDE PAINTED FINISH



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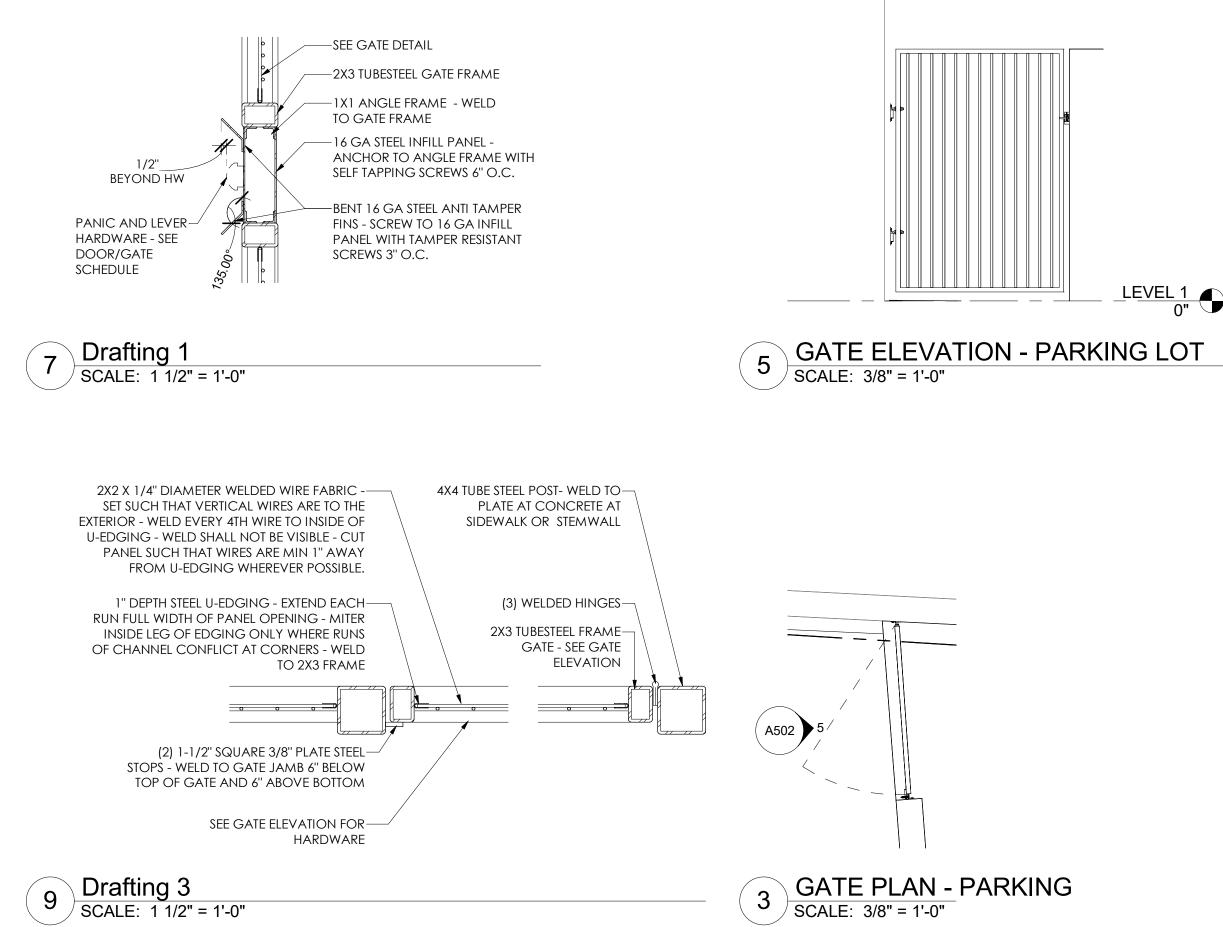



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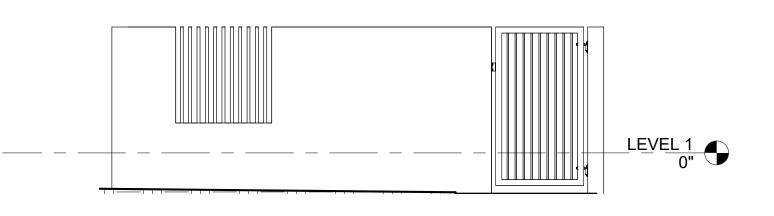
A501

DETAILS

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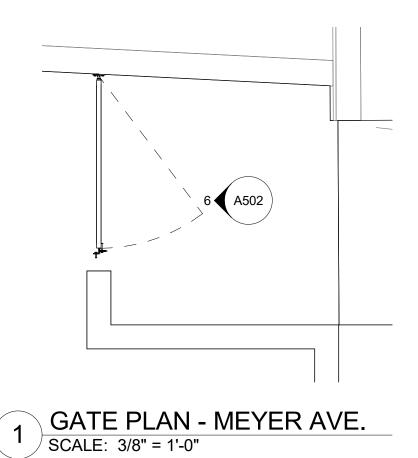





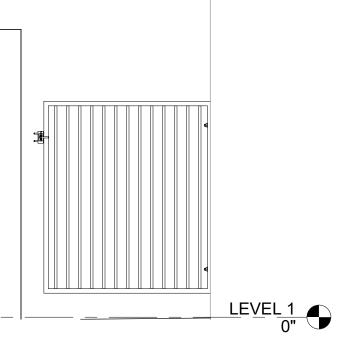


6 GATE ELEVATION - MEYER SCALE: 3/8" = 1'-0"





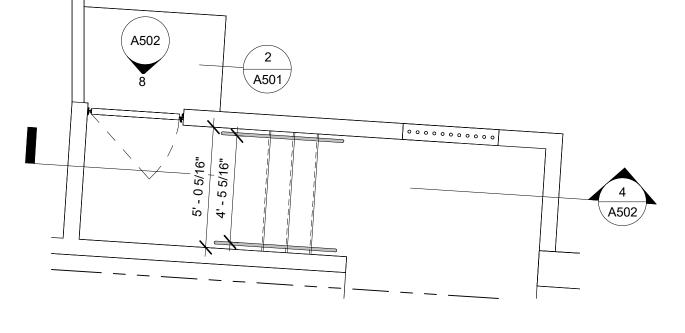

2 GATE & STAIR PLAN - SIMPSON ST. SCALE: 1/4" = 1'-0"

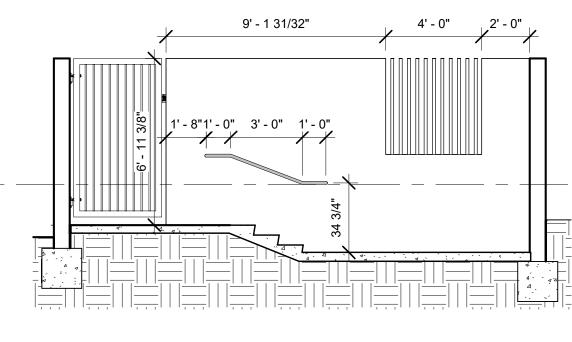

4 SECTION - E-W PATIO STAIRS SCALE: 1/4" = 1'-0"

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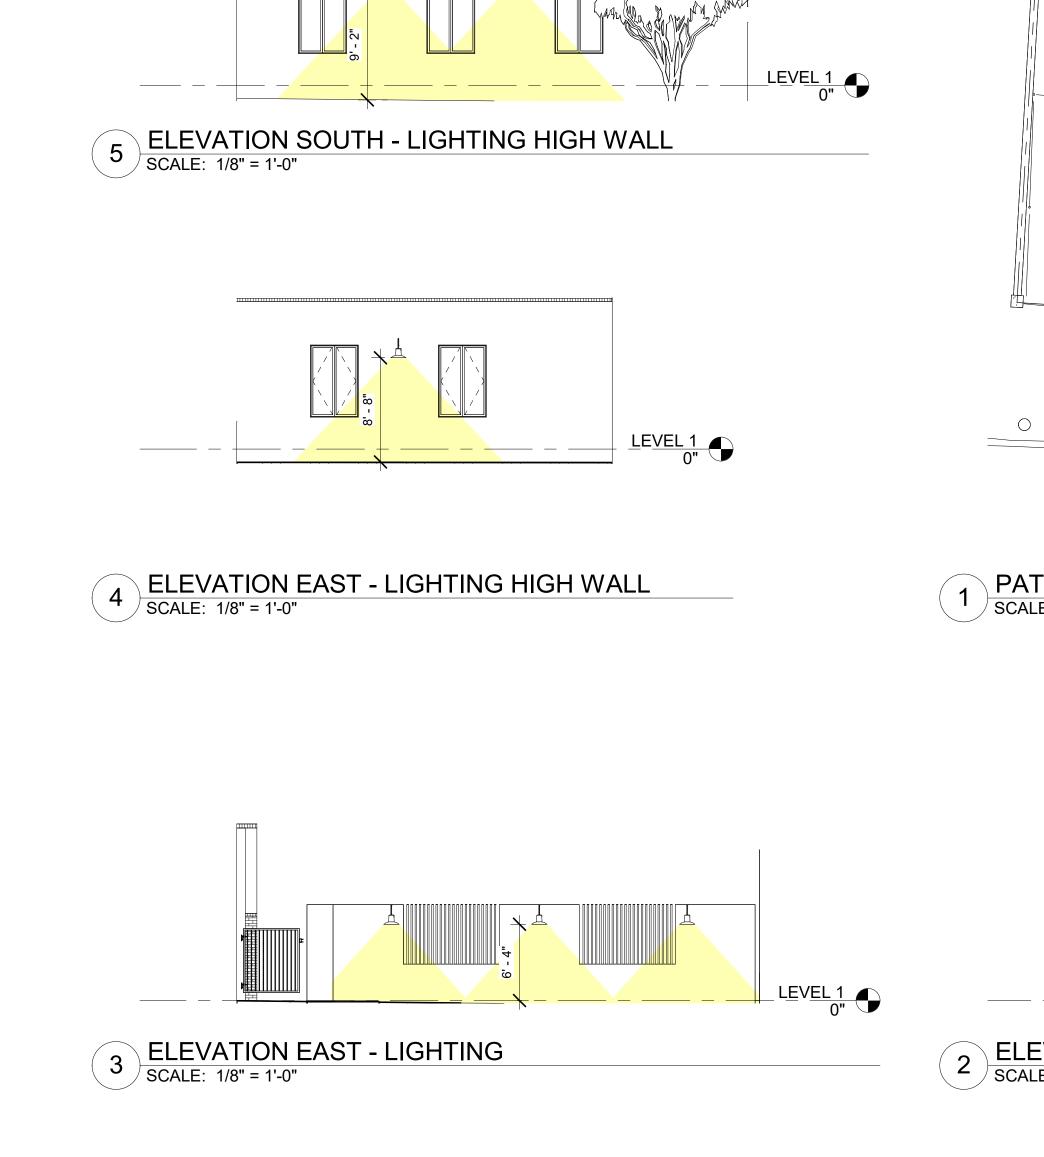


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A502


GATE DETAILS

DRAWN BY: Author REVISIONS CHECKED BY: Checker NO. DATE ISSUE





1 PATIO SITE - LIGHTING SCALE: 1/8" = 1'-0"

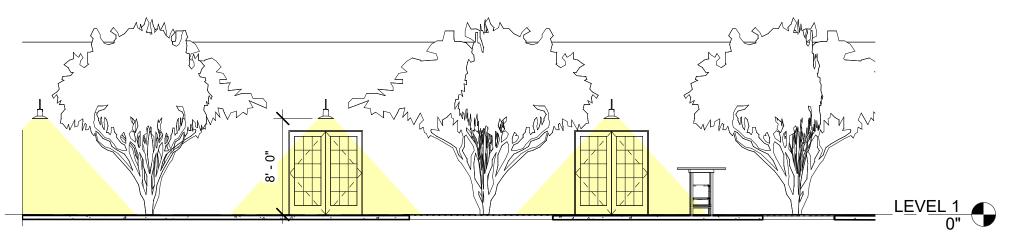

2 ELEVATION - NORTH LIGHTING SCALE: 1/8" = 1'-0"






TEATRO CARMEN REHABILITATION OF HISTORIC THEATER 380 S. MEYER AVE. - TUCSON, AZ 85701

A600

LIGHTING DIAGRAMS

DRAWN BY: Author REVISIONS CHECKED BY: Checker NO. DATE ISSUE

#### Specifications BEL14

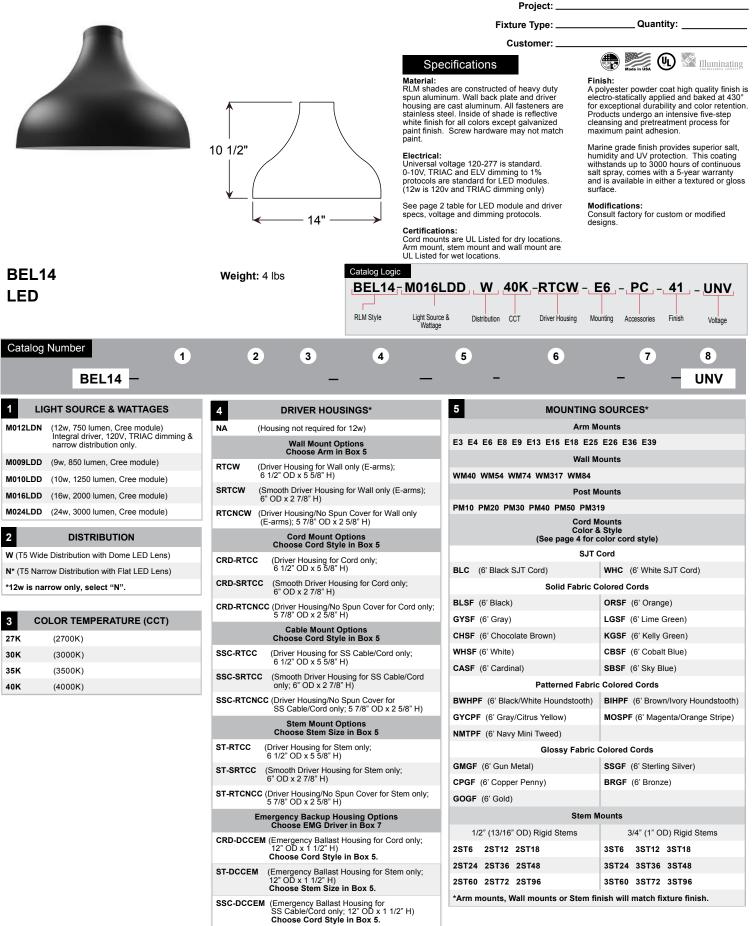

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\*Driver Housing finish will match fixture finish.

#### **Specifications BEL14**

Project: \_\_\_\_

Customer: \_\_\_\_

Fixture Type: \_\_\_\_\_ Quantity: \_\_\_

6	ACCESSORIES*
*EMG-LED06	6 (6w, LED Emergency Driver, remote placement, Cree module only, Not applicable for 12w LED) MUST CHOOSE DCCEM CANOPY IN BOX 4.
*EMG-LED10	(10w, LED Emergency Driver, remote placement, Cree module only, Not applicable for 12w LED) MUST CHOOSE DCCEM CANOPY IN BOX 4.
*EMG-LED16	i (16w, LED Emergency Driver, remote placement, Cree module only, Not applicable for 12w LED) MUST CHOOSE DCCEM CANOPY IN BOX 4.
*EMG-LED20	(20w, LED Emergency Driver, remote placement, Cree module only, Not applicable for 12w LED) MUST CHOOSE DCCEM CANOPY IN BOX 4.
PC (Butto	n Photo Cell) Remote Only
SC (Scrol	I for Arms)**
SLC (Slope	d Ceiling Mount Canopy, 20° Max)**
SQ (Squa	are Back Plate)**
SWL (Adju	stable Locking Swivel)**
TBK (Turn	Buckle Kit)**
*For Emergen ANPlighting.c	cy lumen output data; see Resources section at www. om
**Accessory f	inish will match fixture finish.

7 FINISHES *Marine Grade Finish has an additional charge					
Standard Colors	Standard Grade	Marine Grade*	Premium Colors	Premium Grade	Marine Grade*
Aspen Green	10	10M	High Gloss Black	01	01M
Cantaloupe	11	11M	Arctic Silver	14	14M
Lilac	12	12M	Candy Apple Red	64	64M
Putty	13	13M	Cobalt Blue	65	65M
Raw Unfinished	40	NA	Caramel	66	66M
Black	41	41M	Butterscotch	67	67M
Forest Green	42	42M	Black Silver	68	68M
Bright Red	43	43M	Gunmetal Gray	69	69M
White	44	44M	Mayan Gold	79	NA
Bright Blue	45	45M	Textured Desert Stone	80	80M
Sunny Yellow	46	46M	Extreme Chrome	81	81M
Aqua Green	47	47M	Graystone	82	82M
Galvanized	49	NA	Oil Rubbed Bronze	83	83M
Navy	50	50M	Carbon Graphite	96	96M
Architectural Bronze	51	51M			
Patina Verde	52	52M			
Copper Clay	53	53M			
Silver	56	56M			
Black Verde	61	61M			
Painted Chrome	70	70M			
Painted Copper	71	71M			
Textured Black	72	72M			
Matte Black	73	73M			
Textured Architectural	76	76M			
Textured White	77	77M			
Textured Silver	78	78M			
Consult Fa	ctory for	additiona	al paint charges and availal	oility.	

LED MODULE SPECIFICATIONS					
LED	ССТ	Typical Luminous Flux	System Wattage	Typical Efficacy	
	2700K	850	11W	97	
9W	3000K	850	11W	97	
011	3500K	850	11W	97	
	4000K	850	11W	97	
	2700K	1250	12W	125	
10W	3000K	1250	12W	125	
1000	3500K	1250	12W	125	
	4000K	1250	12W	125	
	2700K	750	12W	65	
12W	3000K	750	12W	65	
1200	3500K	750	12W	65	
	4000K	750	12W	65	
	2700K	2000	19W	125	
16W	3000K	2000	19W	125	
1000	3500K	2000	19W	125	
	4000K	2000	19W	125	
	2700K	3000	29W	125	
24W	3000K	3000	29W	125	
2400	3500K	3000	29W	125	
	4000K	3000	29W	125	

**MODULE LISTINGS** 

Certifications: CE/UL

•

Fully compliant with the RoHS Directive

#### **MODULE SPECIFICATION:**

•	Efficacy 65-125 lumens per watt
•	Life: L70 50,000 hours
•	Color temp: 2700K, 3000K, 3500K and 4000K
•	CRI: >90

#### **MODULE DRIVER SPECIFICATION:**

•	Input Voltage: 120-277 Volts; 50/60Hz
•	Dimmable down to 1%
•	0-10V, TRIAC and ELV dimming protocols are standard. (12w is 120v and TRIAC dimming only)
•	Output Current: Constant Current; 440mA to 940mA (model dependent)
•	Driver Efficiency > 80%; Power Factor > 0.9
•	Integral Surge Protection in conformance to ANSI C62.41 Category A.

#### WARRANTY

.

See www.ANPlighting.com for complete fixture warranty.


- LED warranty information
  - 5 year limited warranty\*
- \*Limited Warranty: A typical year is defined as 4380 hours of operation

8

# 08012019

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ARM MOUNTS   Dimensions are Projection x Height   CB included with all arms	Driver Housings
WALL MOUNTS   Dimensions are Projection x Height	Image: Constraint of the second se
$WM317   15^{\circ} x 12 34^{\circ}$	
ACCESSORIES	

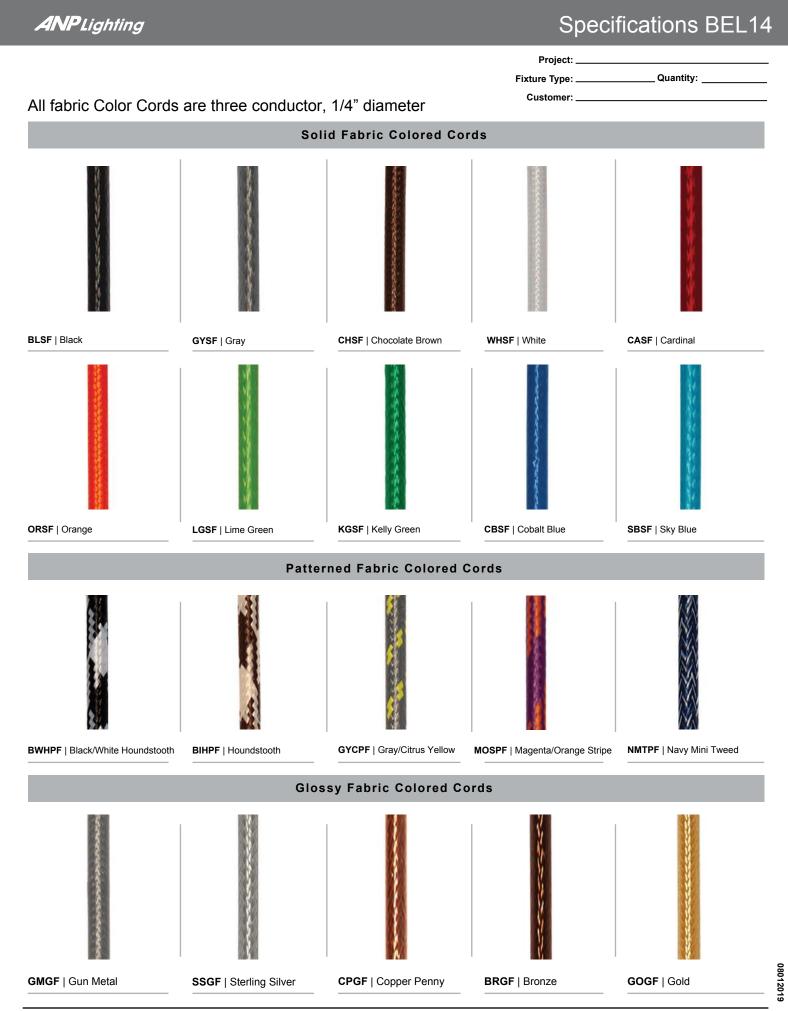

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#### 1-800-548-3227 ANPlighting.com

#### Specifications A814

#### Project: Fixture Type:

Customer: \_

#### Certifications:

Cord mounts are UL Listed for dry locations. Arm mount, stem mount and wall mount are UL Listed for wet locations.

Quantity: \_


#### Finish:

A polvester powder coat high quality finish is for exceptional durability and color retention. Products undergo an intensive five-step cleansing and pretreatment process for maximum paint adhesion.

#### Marine grade finish provides superior salt, humidity and UV protection. This coating withstands up to 3000 hours of continuous salt spray, comes with a 5-year warranty and is available in either a textured or gloss surface.

Modifications:

Consult factory for custom or modified designs.

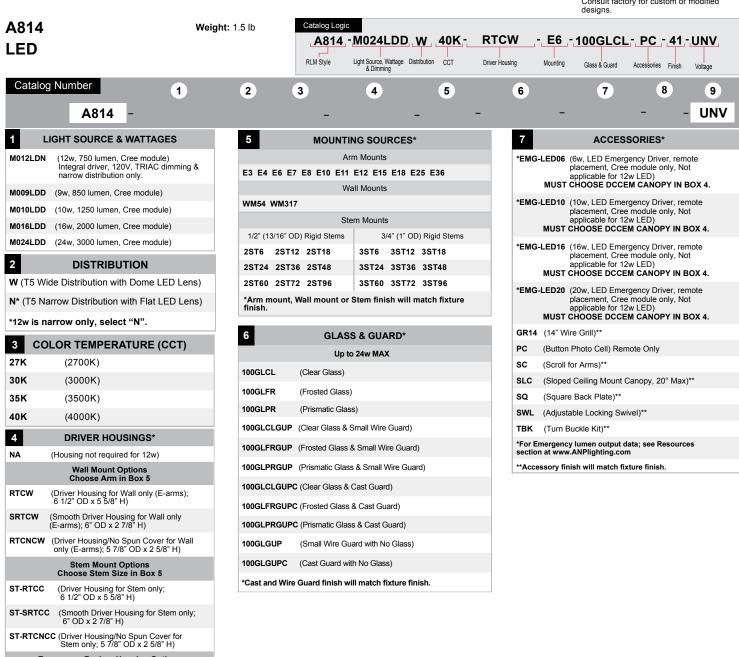

(Emergency Ballast Housing for Stem only; 12" OD x 1 1/2" H) Choose Stem Size in Box 5. ST-DCCEM \*Driver Housing finish will match fixture finish.

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11 3/4,

14 1/4"

Glass: Choice of clear, frosted or prismatic glass up to 24w Max.

Material:

paint.

Specifications

RLM shades are constructed of heavy duty spun aluminum. Wall back plate and driver housing are cast aluminum. All fasteners are stainless steel. Inside of shade is reflective white finish for all colors except galvanized paint finish. Screw hardware may not match

Electrical:

Liectrica: Universal voltage 120-277 is standard. 0-10V, TRIAC and ELV dimming to 1% protocols are standard for LED modules. (12w is 120v and TRIAC dimming only)

See page 2 table for LED module and driver specs, voltage and dimming protocols

Illuminating

#### Specifications A814

Fixture Type:

Project:

Customer: \_\_\_\_\_

Quantity: \_\_\_\_

8 *M	larine Grad		ISHES has an additional charge				LED	MODULE SI	PECIFI	CATION	IS	
Standard Colors	Standard Grade	Marine Grade*	Premium Colors	Premium Grade	Marine Grade*	LED	сст	Typical Luminous	Syste	em Wattage	Typical Efficacy	
Aspen Green	10	10M	High Gloss Black	01	01M			Flux			-	
Cantaloupe	11	11M	Arctic Silver	14	14M	9W	2700K	850		11W	97	
Lilac	12	12M	Candy Apple Red	64	64M		3000K	850		11W	97	
Putty	13	13M	Cobalt Blue	65	65M		3500K	850		11W	97	
Raw Unfinished	40	NA	Caramel	66	66M		4000K	850		11W	97	
Black	41	41M	Butterscotch	67	67M		2700K	1250		12W	125	
Forest Green	42	42M	Black Silver	68	68M	10W	3000K	1250		12W	125	
Bright Red	43	43M	Gunmetal Gray	69	69M	1000	3500K	1250		12W	125	
White	44	44M	Mayan Gold	79	NA		4000K	1250		12W	125	
Bright Blue	45	45M	Textured Desert Stone	80	80M		2700K	750		12W	65	
Sunny Yellow	46	46M	Extreme Chrome	81	81M		3000K	750		12W	65	
Aqua Green	47	47M	Graystone	82	82M	12W	3500K	750		12W	65	
Galvanized	49	NA	Oil Rubbed Bronze	83	83M		4000K	750		12W	65	
Navy	50	50M	Carbon Graphite	96	96M		2700K	2000		19W	125	
Architectural Bronze	51	51M					3000K	2000		19W	125	
Patina Verde	52	52M				16W						
Copper Clay	53	53M				24W	3500K	2000		19W	125	
Silver	56	56M					4000K	2000		19W	125	
Black Verde	61	61M					2700K	3000		29W	125	
Painted Chrome	70	70M					3000K	3000		29W	125	
Painted Copper	71	71M					3500K	3000		29W	125	
Textured Black	72	72M					4000K	3000		29W	125	
Matte Black	73	73M				MODI	JLE SPECIFICAT	ION:	морш	E LISTING	s	
Textured Architectural	76	76M										
Textured White	77	77M					Efficacy 65-125 lumens per watt			•	the RoHS Directive	
Textured Silver	78	78M				Life: L70 50,000 hours     Certifications: CE/UL			JL			
Consult Factory for additional paint charges and availability.				Color temp: 2700K, 3000K, 3500K and 4000K     CRI: >90								
9		vo	LTAGE			• •	<i.>90</i.>					
<b>JNV</b> (120-277)						MOD	JLE DRIVER SPE	ECIFICATION:				
						• In	put Voltage: 120-277 Vo	olts; 50/60Hz				
						• D	immable down to 1%					
						• 0- (1	10V, TRIAC and ELV of 2w is 120v and TRIAC d	dimming protocols are a limming only)	standard.			
							utput Current: Constanded dependent)	ant Current; 440mA to	940mA			
						• D	river Efficiency > 80%; P	ower Factor > 0.9				
							,,, -, -, -, -, -, -, -, -, -,					

Integral Surge Protection in conformance to ANSI C62.41 Category A.

#### WARRANTY

See www.ANPlighting.com for complete fixture warranty.

LED warranty information

• 5 year limited warranty\*

\*Limited Warranty: A typical year is defined as 4380 hours of operation

•

### Specifications A814

				Project:			
					Quantity:		
				Customer: _			
ARM MOUNTS   Dimensio	ons are Projection x Height		Driver Housings				
$\cap$		$\cap$	- 0		RTCW (6 1/2" OD x 5 5/8" H) Wall Only (E-arms)		
					RTCNCW (5 7/8" OD x 2 5/8" H) Wall Only (E-arms)		
<b>E3</b>   35" x 11 7/8"	<b>E4</b>   29" x 14"	<b>E6</b>   29" x 9 1/4"	<b>E7</b>   44 1/4" x 9 1/8"		SRTCW (6" OD x 2 7/8" H) Wall Only (E-arms)		
	•				ST-RTCC (6 1/2" OD x 5 5/8" H) Stem Only		
<b>E8</b>   32 1/4" x 12 1/2"	E10   55 1/4" x 18"	E11   38 1/4" x 17 1/4"	<b>E12</b>   40 3/8" x 2"		ST-RTCNCC (5 7/8" OD x 2 5/8" H) Stem Only		
	$\left( \right)$		$\sim$		ST-SRTCC (6" OD x 2 7/8" H) Stem Only		
E15  16 3/8" x 10 1/2"	<b>E18</b>   30 3/4" x 21 3/8"	<b>E25</b>   26" x 5 1/4"	<b>E36</b>   23 1/4" x 8"		ST-DCCEM (12" OD x 1 1/2" H) Stem Only		
					GLASS & GUARDS		
					UP TO 24W MAX		
				Glass Lege	and: CL = Clear FR = Frosted PR = Prismatic 100 = Small 200 = Large		
WALL MOUNTS   Dimensi	ons are Projection x Height				Glass Only (6 1/2" H X 4 1/8" W)		
$\frown$				8	100GLCL		
( )					100GLFR		
					100GLPR		
<b>WM54</b>   23 3/8" x 18"	WM317   15" x 12 3/4"			Glass	s with Cast Guard (7 1/2" H X 4 1/8" W)		
VVIVI34   23 3/8 X 18					100GLCLGUPC		
					100GLFRGUPC		
					1		
				Ð	100GLPRGUPC		
				Glass	s with Wire Guard (7 1/2" H X 4 1/8" W)		
					100GLCLGUP		
ACCESSORIES					100GLFRGUP		
1. The second se					100GLPRGUP		
1					Guards Only (7 1/2" H X 4 1/8"		
EMG-LED	GR14	PC	SLC		100GLGUPC (Cast Guard)		
· (				E			
SQ.	SWL	твк	sc		100GLGUP (Wire Guard)		
				Y			

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08012019

## WAC LIGHTING

#### Endurance<sup>™</sup> Brick Lights

#### Louver Step And Wall Light

	-		
Model & Voltage	Color Temp & CRI	Lumens	Finish
WL-5205 120 VAC	<b>3000K</b> 90	45	ABK Architectural Black ABZ Architectural Bronze AGH Architectural Graphite AWT Architectural White

#### Example: WL-5205-30-ABK

#### DESCRIPTION

Designed for integration into brick walls or vertical risers. The energy-efficient Endurance<sup>™</sup> LED Brick Light features a die-cast aluminum housing and integrated LED light engine with a heat resistant opal glass diffuser for a glare-free even spread of light, making outdoor areas safer and more secure.

#### FEATURES

- Glare controlling die-casted aluminum louver
- Factory sealed LED light engine
- 5 year warranty


#### SPECIFICATIONS

Construction:	Die-cast aluminum (K-Alloy)
Power:	5.5W
Input:	120 VAC, 50/60Hz
Dimming:	ELV: 100-10%
Light Source:	Integrated LED
Rated Life:	80000 Hours
Mounting:	Mortar into masonry, screw into wood walls, or retrofit into existing brick light installations, Can be mounted on wall vertically or horizontally
Cut Out:	3 1/4" x 8"
Finish:	Electrostatically Powder Coated: Architectural White, Architectural Graphite, Architectural Bronze, Architectural Black
Operating Temp:	-40°F to 122°F (-40°C to 50°C)
Standards:	ETL, cETL, Wet Location Listed, IP66, ADA

#### FINISHES:



#### LINE DRAWING:

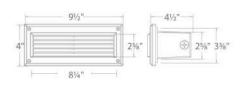

#### **REPLACEMENT PARTS**

5205-COV-AWT - Louvered Cover Plate AWT 5205-COV-AGH - Louvered Cover Plate AGH 5205-COV-ABZ - Louvered Cover Plate ABZ 5205-COV-ABK - Louvered Cover Plate ABK 5005-PLATE - Mnt Plate for Light Engine

waclighting.com | Phone (800) 526.2588 | Fax (800) 526.2585 | Headquarters/Eastern Distribution Center 44 Harbor Park Drive Port Washington, NY 11050

WAC Lighting retains the right to modify the design of our products at any time as part of the company's continuous improvement program. August 2022

Fixture Type:

Catalog Number:

Project:

Location: